# MASON COUNTY PUD 1

MASON COUNTY WASHINGTON



## LAKE ARROWHEAD WATER MAIN REPLACEMENT

## PUD OFFICIALS

MIKE SHEETZ

**RON GOLD** 

**JACK JANDA** 

**DISTRICT 1 COMMISSIONER** 

**DISTRICT 2 COMMISSIONER** 

**DISTRICT 3 COMMISSIONER** 

### KRISTIN MASTELLER

GENERAL MANAGER

FUNDED THROUGH THE WASHINGTON STATE REVOLVING FUND (DWSRF)
PROGRAM WITH FEDERAL FUNDS FROM THE ENVIRONMENTAL
PROTECTION AGENCY. Project No. DWL27176



AUG 2024 G&O #22249

M:∖Mason County PUD 1\22249.00 Lake Arrowhead Water Main Replacement\01 Design\Planset\General\COVER.dwg


1130 RAINIER AVENUE SOUTH, SUITE 300 SEATTLE WASHINGTON 98144 (206) 284-0860

STA

STATION

Gray & Osborne, Inc CONSULTING ENGINEERS

> 1130 RAINIER AVENUE SOUTH, SUITE 300 SEATTLE, WASHINGTON 98144 (206) 284-0860

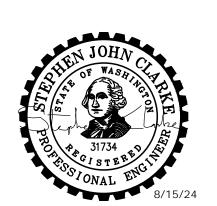



LAKE ARROWHEAD **WATER MAIN** REPLACEMENT 160 W SATSOP CLOQUALLUM RD., ELMA, WA 98541

No. DATE REVISION

ISSUED FOR: ISSUE DATE: AUG 2024 APPROVED BY: S. CLARKE M. JOHNSON CHECKED BY: DRAWN BY: P. SMILEY P. SMILEY

DESIGNER:

G & O JOB NO.:


LEGEND.DWG TWO INCHES AT FULL SCALE. IF NOT, SCALE ACCORDINGLY

22249

**GENERAL** 


ABBREVIATIONS, SYMBOL LEGEND, AND **GENERAL NOTES** 

DRAWING: G-1 OF: 5

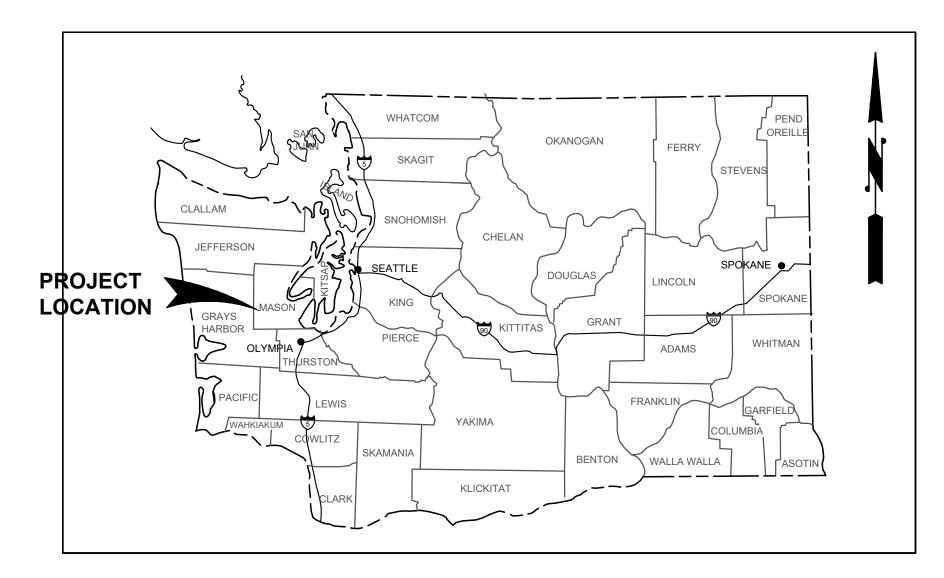


### **VICINITY MAP**

NTS

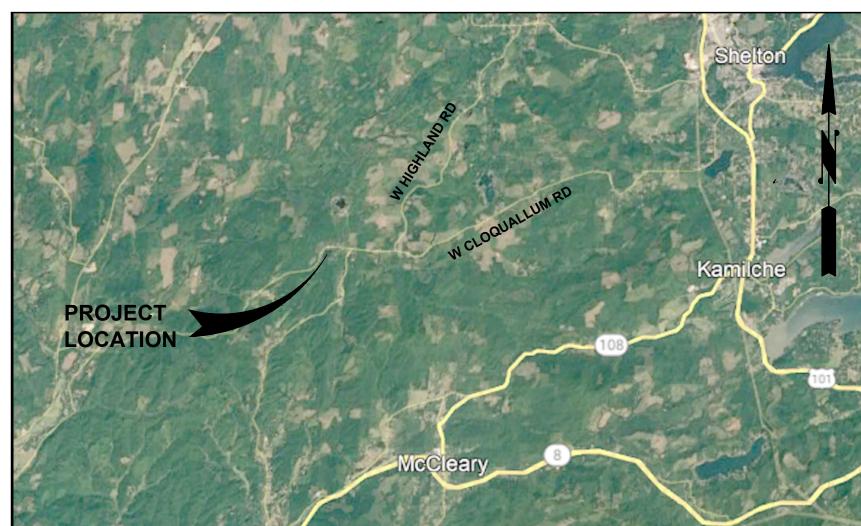

### VICINITY MAP

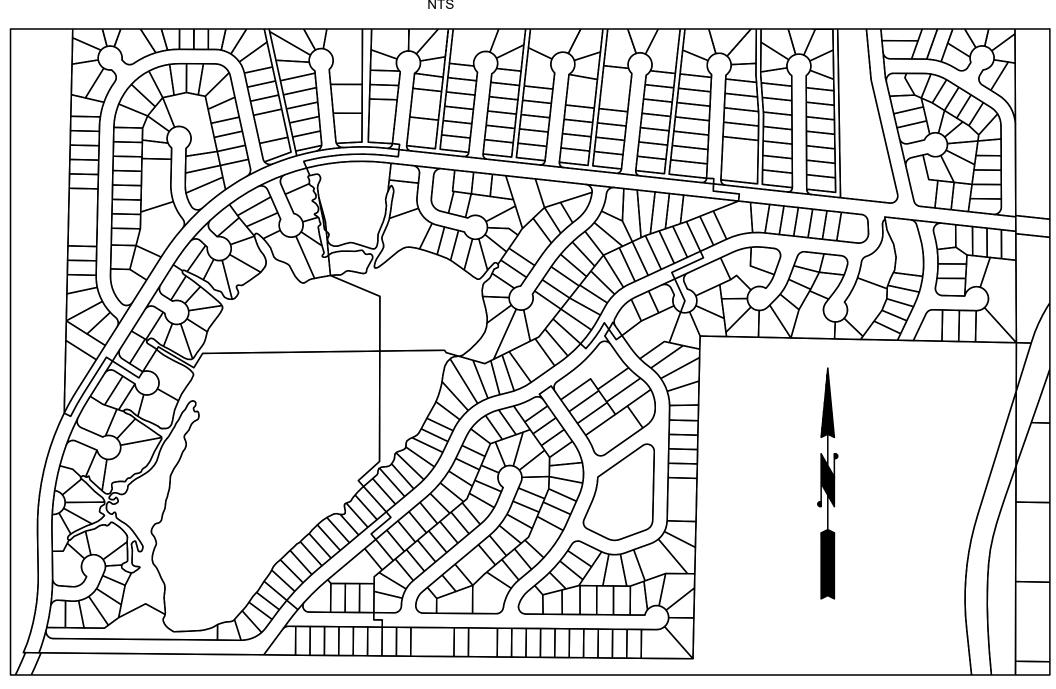

<b>PROJECT</b>	SITE
NTS	

	SHEET INDEX			
SHEET	DESCRIPTION			
	COVER			
G-1	ABBREVIATIONS, SYMBOL LEGEND, AND GENERAL NOTES			
G-2	SHEET INDEX, VICINITY MAP, AND LOCATION MAP			
G-3	SURVEY CONTROL PLAN			
G-4	SURVEY CONTROL NOTES			
G-5	SHEET KEYMAP			
D-1	TESC NOTES & DETAILS			
D-2	WATER MAIN DETAILS			
D-3	WATER MAIN DETAILS			
C-1	WOWA CT			
C-2	W KIOWA PL			
C-3	TEKOA PL			
C-4	SEKIU PL			
C-5	W HOKO PL			
C-6	LOLO PL			
C-7	QUEETS PL			
C-8	SHEET FOR FUTURE CONSTRUCTION			
C-9	KAMILICHIE TR			
C-10	SHEET FOR FUTURE CONSTRUCTION			
C-11	SHEET FOR FUTURE CONSTRUCTION			
C-12	SHEET FOR FUTURE CONSTRUCTION			
C-13	STA 30+00 TO 38+08			
C-14	STA 38+08 TO 45+75			
C-15	STA 45+75 TO 53+90			
C-16	STA 53+90 TO 61+69			
C-17	STA 61+69 TO 65+29 AND W TIPI CT			
C-18	STA 65+29 TO 69+05 AND W CLOQUALLUM CT			
C-19	STA 69+05 TO 71+50 AND CHINOOK CT			
C-20	STA 71+50 TO 72+90 AND KALOCH LN			
C-21	KALALOCH LN AND W KALAMA PL			
C-22	SHEET FOR FUTURE CONSTRUCTION			
C-23	SHEET FOR FUTURE CONSTRUCTION			
C-24	SHEET FOR FUTURE CONSTRUCTION			
C-25	HOQUIAM & SUQUAMISH TRAIL			
C-26	W MAKAH TRAIL			
C-27	W DOSEWALIPS TR			
C-28	THUNDERBIRD DR (1)			
C-29	THUNDERBIRD DR (2)			
C-30	W TYEE PL			

	C-31	TOTEM DR
	C-32	TOTEM DR AND SKOOKUM LN
,	C-33	PUYALLUP DR (1)
	C-34	PUYALLUP DR (2)
	C-35	W STAR LAKE DR AND MOWITCH CIRCLE
	C-36	W STAR LAKE DR AND W CHIMACUM DR
	C-37	W CHIMACUM DR AND PAPOOSE PL



JOHN CHARLES OF WASHINGS OF WA



REPLACEMENT

160 W SATSOP CLOQUALLUM
RD., ELMA, WA 98541

No. DATE REVISION

ISSUED FOR:
BID

ISSUE DATE: AUG 2024

APPROVED BY: S. CLARKE

CHECKED BY: M. JOHNSON

P. SMILEY
P. SMILEY

VICINITY.DWG

0 1" 2"
TWO INCHES AT FULL SCALE.
IF NOT, SCALE ACCORDINGLY


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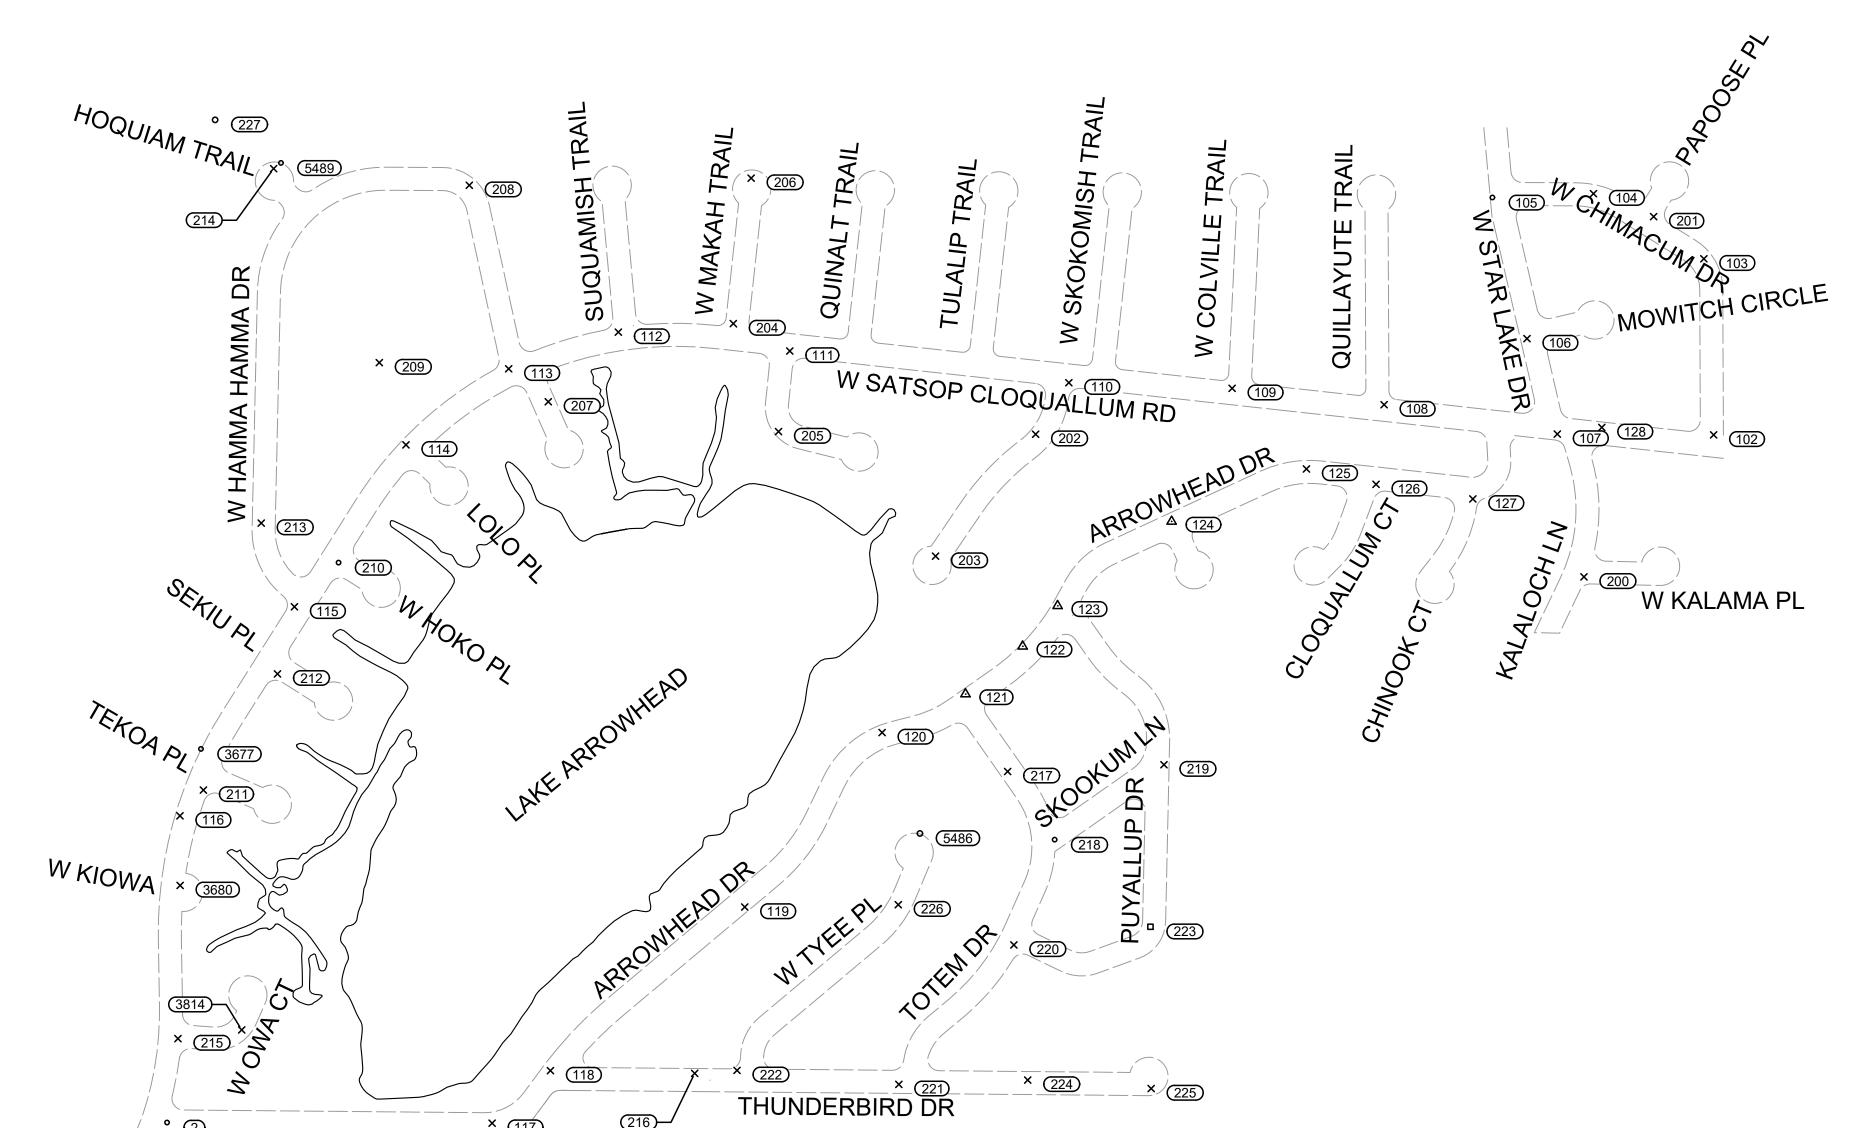
DESIGNER: G & O JOB NO.:


GENERAL

SHEET INDEX, VICINITY MAP, AND LOCATION MAP

DRAWING: **G-2** OF: **5** 



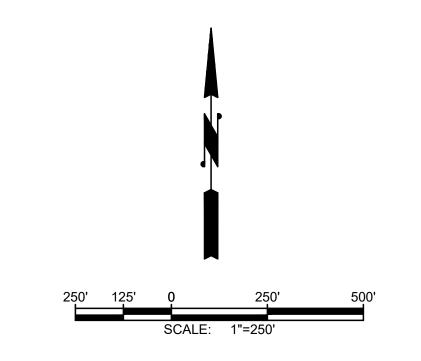

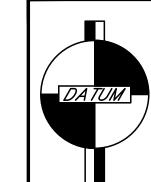

**RIGHT-OF-WAY DISCLAIMER** 

THE RIGHT-OF-WAY AND/OR PROPERTY LINES SHOWN HEREON ARE BASED ON AVAILABLE INFORMATION, NOT ON A SURVEYED LOCATION AND

ARE ONLY APPROXIMATE.

### **DATUM**

VERTICAL: HORIZONTAL:

NAVD88 NAD83/2011 W.S.P.C.S. S. ZONE Gray & Osborne, Inc.

CONSULTING ENGINEERS

1130 RAINIER AVENUE SOUTH,

SUITE 300

SEATTLE, WASHINGTON 98144

(206) 284-0860



08/15/2024





PUD 1
LAKE ARROWHEAD
WATER MAIN
REPLACEMENT

160 W SATSOP CLOQUALLUM RD., ELMA, WA 98541

No.	DATE	REVISION		
ISSUED FOR:				
		BID		
ISSUE	DATE:	AUG 2024		
APPR	OVED BY:	M. JOHNSON		
CHEC	KED BY:	R. BOND		
DRAW	N BY:	B. HAYDEN		
DESIG	SNER:	P. SMILEY		
G & O	JOB NO.:	22249		

TWO INCHES AT FULL SCALE.
IF NOT, SCALE ACCORDINGLY

SURVEY.DWG

**GENERAL** 

SURVEY CONTROL PLAN

DRAWING: **G-3** OF: **5** 


SURVEY CONTROL 1" = 250'

	CONTROL COORDINATES TABLE			
MASON COUNTY PUD 1 - LAKE ARROWHEAD WATER SYSTEM				
JOB NU	JOB NUMBER - 22249			
	HORIZONTAL DATUM:  NAD83/2011, EPOCH 2010.00 WASHINGTON PLANE COORDINATE SYSTEM, SOUTH ZONE, GRID NORTH MODIFIED GROUND COORDINATES, SCALED TO GROUND USING AVG. CGF OF 0.99994753270 AT BASE POINT G&O #101.			
VERTIC	AL DATUM:	NAVD88 HOLDING WS	DOT PUB	LISHED ELEVATION ON WSDOT "LOST PRARIE" (G&O #1)
POINT	NORTHING	EASTING	ELEV	DESCRIPTION
1	674868.85	958543.44	487.73	SFMC=FOUND MONUMENT IN CASE, WSDOT "LOST PRAIRIE" MON ID: 5421. DOWN 0.8' IN CASE.
2	668126.12	932681.38	341.42	SSS=SET SPIKE, SMALL MAG SPIKE DOWN 0.05' IN GRAVEL. S SIDE ARROWHEAD DR. 10' N10°E OF STREET NAME SIGN FOR "ARROWHEAD DR." 10' S OF WATER VALVE IN CONCRETE COLLAR. CENTERLINE GRAVEL ROAD, SW QUADRANT INTX ARROWHEAD DR & CLOQUALLUM.
100	669818.27	937288.44	346.38	SSN=SET NAIL, MAG NAIL W/ WHISKERS IN TRIANGLE SHOULDER BETWEEN SATSOP-CLOQUALLUM RD & W CLOQUALLUM RD. 8' FROM EDGE OF PAVEMENT ON BOTH SIDES.
101	669753.55	937768.51	346.72	SSN, 60-D NAIL W/ PINK WHISKERS AT GRADE IN GRAVEL SHOULDER. 5' S OF S EDGE OF ASPHALT OF CLOQUALLUM RD. 6' NW TOP CENTER OF 14" CMP CULVERT. 17' E OF CENTERLINE OF DRIVEWAY. 484' E OF G&O #100. 1ST DRIVEWAY E OF #100 TO SE.
102	669916.95	936709.08	336.41	SSN, SET MAG NAIL W/ WHISKERS E SIDE GRAVEL ACCESS ROAD "CHIMACUM DR." 15' N OF EDGE OF PAVEMENT OF SATSOP-CLOQUALLUM RD. 13.75' S OF PRIVATE RD/STREET NAME SIGN.
103	670375.51	936683.66	336.93	SSN, 60-D NAIL W/ WHISKERS, NE SIDE OF GRAVEL ACCESS ROAD. 15' SE OF CENTERLINE 1ST DRIVEWAY ON THE NE SIDE OF GRAVEL ROAD. 10' S OF CPEP CULVERT.
104	670545.06	936396.09	337.62	SSN, 60-D NAIL W/ WHISKERS, N SIDE OF GRAVEL ACCESS ROAD. 3.5' N OF EDGE OF GRAVEL. 3' S OF TOP DITCH. 25' E OF CENTERLINE GRAVEL DRIVEWAY FOR EMPTY LOT. SECOND DRIVEWAY ON N SIDE FROM NORTH-SOUTH ROAD.
105	670535.10	936132.73	337.18	SSRC=SET 5/8" REBAR W/ RED PLASTIC "G&O CONTROL" CAP, TOP OF DITCH ACROSS FROM INTX OF GRAVEL ACCESS ROAD & STAR LAKE RD. 22.5' N OF CHAIN LINK FENCE CORNER. 13.5' W OF EDGE OF PAVEMENT.
106	670167.52	936222.93	336.58	SSN, LARGE MAG NAIL W/ FLAGGING, W OF STAR LAKE ROAD IN GRAVEL DRIVE FOR UTILITY DEPOT. 3' W OF EDGE OF ASPHALT. 3' N OF S EDGE OF GRAVEL. 15' NE OF CONC CULVERT.
107	669919.02	936301.92	336.95	SSN, LARGE MAG NAIL W/ FLAGGING, SE QUADRANT INTX STAR LAKE RD & CLOQUALLUM RD. 2' S OF EDGE OF ASPHALT. 13' N OF MAILBOX ROW. 25' E OF STREET NAME SIGN.
108	669995.60	935850.88	337.50	SSN, LARGE MAG SPIKE W/ FLAGGING, NE QUADRANT INTX OF CLOQUALLUM RD & QUILLAUTE TRAIL. 3' N OF EDGE OF ASPHALT. 11' W OF MAILBOX POST. 2.5' FROM TOP OF DITCH.
109	670038.30	935455.05	337.95	SSN, LARGE MAG NAIL W/ WHISKERS, NW QUADRANT INTX COLVILLE TRAIL & SATSOP-CLOQUALLUM RD. 2.5' N OF EDGE OF PAVEMENT. 2' SSE OF PHONE RISER.
110	670052.81	935029.89	337.95	SSN, LARGE MAG NAIL W/ WHISKERS, SE QUADRANT DOSEWALIPS TRAIL & SATSOP-CLOQUALLUM RD. 7' S OF EDGE OF ASPHALT. 4.5' NW OF CULVERT.
111	670135.39	934303.23	339.84	SSN, LARGE MAG NAIL W/ WHISKERS, 5.5' S OF EDGE OF ASPHALT OF SATSOP-CLOQUALLUM RD IN SE QUADRANT INTX W/ KAMILCHIE TRAIL. 6.5' NW OF CULVERT. 14' N OF WATER METER.
112	670184.51	933856.84	338.73	SSN, 60-D NAIL W/ WHISKERS AT EDGE OF GRAVEL, NW QUADRANT INTX OF SATSOP-CLOQUALLUM RD & SUQUAMISH TRAIL. 10' N OF EDGE OF ASPHALT. 20' SE OF STREET NAME SIGN.
113	670088.99	933571.29	339.20	SSN, 60-D NAIL W/ WHISKERS IN GRASS. AT NW QUADRANT HAMMA HAMMA DR & SATSOP-CLOQUALLUM RD. 21' N60°E OF POWER POLE.
114	669890.91	933303.80	342.05	SSN, 60-D NAIL W/ BLUE WHISKERS. 5.5' E OF E MAILBOX (OF 6). 6' N OF N EDGE OF SATSOP-CLOQUALLUM RD. AT W EDGE GRAVEL OF HOQUIAM TRAIL.
115	669469.25	933013.23	341.96	SSN, 60-D NAIL W/ BLUE WHISKERS IN GRASS SHOULDER. SW QUADRANT INTX HAMMA HAMMA DR & SATSOP-CLOQUALLUM RD. 3.5' NE OF DITCH TOP AT PC OF CURVE. 15' N32°E OF PHONE PEDESTAL.
116	668924.93	932715.14	344.00	SSN, 60-D NAIL W/ BLUE WHISKERS AT GRADE. IN EDGE OF GRAVEL S SIDE DRIVEWAY TO CLEAR CUT. 3' N OF DITCH TOP. 8' W OF W EDGE OF ASPHALT SATSOP-CLOQUALLUM DR. 10' NW OF EDGE OF ASPHALT/GRAVEL AP. DRIVEWAY IS S OF TEKOA PL.
117	668124.58	933528.00	344.88	SSN, 60-D NAIL W/ BLUE WHISKERS DOWN 0.05' IN GRAVEL SHOULDER, S SIDE OF ARROWHEAD DR. 1.25' NW OF S DITCH TOP. 3.5' S OF S EDGE OF GRAVEL. S29°E OF W END OF WOOD FENCE ALONG N EDGE OF GRAVEL AT HOUSE #650.
118	668261.42	933679.89	355.34	SSN, 60-D NAIL W/ BLUE WHISKERS IN DIRT SHOULDER. 4' W OF W EDGE OF GRAVEL OF ARROWHEAD DR. SW QUADRANT INTX ARROWHEAD DR & W THUNDERBIRD DR. 7.5' SSE OF FIRE HYDRANT.
119	668687.40	934186.02	371.10	SSN, 60-D NAIL W/ BLUE WHISKERS AT SE EDGE OF ASPHALT ARROWHEAD DR. 12' SSW OF CENTERLINE DRIVEWAY TO #481.
120	669141.85	934543.71	345.18	SSN, 60-D NAIL W/ WHITE WHISKERS. 2' NW OF NW EDGE ASPHALT OF ARROWHEAD DR, IN CURVE. 47' SW OF CENTERLINE N DRIVEWAY TO LACC PARK. 8' SSE OF SSE FACE OF 12" FIR TREE.
121	669242.03	934760.75	353.67	SSNT, LARGE MAG NAIL W/ SMALL UNMARKED FLASHER. 0.5' S OF N EDGE OF ASPHALT ARROWHEAD DR. AT CENTERLINE EXTENDED OF TOTEM DR. 3' S OF CENTER OF LARGE MILLSAW BLADE "LAMPHEREIS."
122	669366.39	934909.58	362.75	SSNT, LARGE MAG NAIL W/ "G&O CONTROL" TAG, 1' W OF E EDGE OF ASPHALT OF ARROWHEAD DR. 103' S OF MAILBOX TO HOUSE #20. 162' S OF CENTERLINE EXTENDED OF SKOOKUM LN.
123	669471.79	935000.61	355.40	SSNT, LARGE MAG NAIL W/ "G&O CONTROL" TAG, 1' E OF W EDGE OF ASPHALT OF ARROWHEAD DR. INTX SKOOKUM LN & ARROWHEAD DR. CENTERLINE OF SKOOKUM EXTENDED.
124	669691.50	935297.53	362.80	SSNT, LARGE MAG NAIL W/ "G&O CONTROL" TAG, 1.1' SE OF NW EDGE OF ASPHALT OF ARROWHEAD DR. AT NE EDGE OF GRAVEL OF TIPI CT EXTENDED. 9' NE OF TIPI CT CENTERLINE EXTENDED.
125	669828.22	935648.69	369.44	SSN, 60-D NAIL W/ BLUE WHISKERS. 3.5' N OF N EDGE OF ASPHALT OF ARROWHEAD DR. 4' S OF S FACE OF 56" TREE STUMP. 36' E OF CENTERLINE EXTENDED OF DRIVEWAY TO #121.
126	669788.23	935829.83	372.92	SSN, 60-D NAIL W/ TURQUOISE WHISKERS. AT E EDGE OF GRAVEL IN CURVE. SE QUADRANT INTX CLOQUALLUM CT & ARROWHEAD DR. 15' WSW OF W FACE OF MAILBOX FOR #100W.
127	669750.11	936082.09	349.67	SSN, 60-D NAIL W/ BLUE WHISKERS. DOWN 0.1' IN GRAVEL. AT S EDGE OF GRAVEL CHINOOK CT IN CURVE. AT SE QUADRANT INTX CHINOOK & ARROWHEAD DR. 2' N OF GROUND TOP. 5.5' NE OF STREET NAME SIGN FOR "CHINOOK CT." 8' N OF N FACE OF 28" EVERGREEN.

128	669936.46	936417.86	336.35	SSN, 60-D NAIL W/ BLUE WHISKERS. DOWN 0.05' IN E EDGE OF GRAVEL DRIVEWAY TO #160W SATSOP-CLOQUALLUM RD. 4.5' N OF N EDGE OF ASPHALT SATSOP-CLOQUALLUM RD.
200	669547.21	936371.42	335.13	SSN, 60-D NAIL W/ WHISKERS, IN SE QUADRANT KALALOCH LN & KALAMA PL. 3.5' SE OF EDGE OF GRAVEL. 20' NE OF POWER POLE. 15' N OF STREET NAME SIGN.
201	670485.23	936552.75	336.97	SSN, MAG NAIL W/ FLAGGING IN GRAVEL AT NE QUADRANT INTX PAPOOSE PL & CHIMACUM DR. 5' W OF EDGE OF GRAVEL. 17' S80°W OF STREET NAME SIGN FOR "PAPOOSE PL."
202	669918.62	934943.54	338.54	SSN, MAG SPIKE, NW SIDE OF DOSEWALIPS TRAIL NEAR 1ST DRIVEWAY NE SIDE OF ROAD. NE LINE EXTENDED.
203	669601.06	934682.89	339.33	SSN, 60-D NAIL W/ WHISKERS. W SIDE OF DOSEWALIPS TRAIL AT BEGINNING OF CULDESAC. 40' NW OF CORNER OF S PVC FENCE EXTENDED. 70' NE OF 48" SPRUCE & 36 CEDAR GROWING TOGETHER.
204	670206.76	934156.11	340.35	SSN, 60-D NAIL W/ WHISKERS, W EDGE OF GRAVEL MAKAH TRAIL. 30' N OF EDGE OF ASPHALT SATSOP-CLOQUALLUM RD. 18' SW OF DEAD END SIGN. 22' ENE OF STREET NAME SIGN.
205	669925.52	934273.87	338.40	SSN, 60-D NAIL W/ WHISKERS, S OF BEND IN KAMILCHE RD. 8' NE OF POWER POLE.
206	670585.57	934202.58	344.60	SSN, 60-D NAIL W/ WHISKERS, N END OF CULDESAC W MAKAH TRAIL.
207	670003.26	933674.38	337.87	SSN, 60-D NAIL W/ BLUE WHISKERS AT GRADE. AT E EDGE OF GRAVEL QUEETS PL. 15' S OF CENTERLINE 1ST DRIVEWAY ON LEFT TURNING INTO QUEETS. 15' WNW OF POWER POLE.
208	670567.03	933468.67	354.42	SSN, 60-D NAIL W/ BLUE WHISKERS IN GRASS SHOULDER. 2.5' SW OF DITCH TOP. 7' NE OF NE EDGE OF GRAVEL OF HAMMA HAMMA DR. IN CURVE 22' NW OF CENTERLINE DRIVEWAY LOT #33.
209	670105.18	933234.34	343.88	SSN, 60-D NAIL W/ BLUE WHISKERS IN GRAVEL RD. 3.5' E OF W EDGE GRAVEL OF HOQUIAM TRAIL. AT 20" CEDAR TREE. 57' N OF CENTERLINE GATED DRIVEWAY TO HOUSE #41.
210	669584.36	933128.07	342.88	SSS, MAG SPIKE AT GRADE. 6' W OF CENTERLINE OF HOKO PL. 10' S OF S EDGE ASPHALT SATSOP-CLOQUALLUM. S°61E OF WESTERLYMOST MAILBOX N OF N EDGE OF ASPHALT. MAILBOX FOR #24 "MCFARLAND."
211	668992.00	932776.19	341.29	SSN, 60-D NAIL W/ BLUE WHISKERS DOWN 0.05' IN GRASS. 7' E OF E EDGE OF ASPHALT SATSOP-CLOQUALLUM RD. 13' W OF N END OF CENTERLINE LANDSCAPING LINE. 24' S45°W OF STREET NAME SIGN FOR "TEKOA PL."
212	669294.52	932969.05	339.85	SSN, 60-D NAIL W/ BLUE WHISKERS IN GRASS. 8' S OF S EDGE OF GRAVEL SEKIU PL. 8.5' SW OF "DEAD END PVT RD" SIGN. 5' NNE OF N FACE OF POWER POLE.
213	669687.20	932926.75	346.37	SSN, 60-D NAIL W/ BLUE WHISKERS AT W EDGE OF GRAVEL HAMMA HAMMA DR. 29' N OF CENTERLINE DRIVEWAY TO #346.
214	670610.24	932959.17	370.05	SSN, 60-D NAIL W/ BLUE WHISKERS AT GRADE. 9' E OF E FACE OF POWER POLE W/ TRANSFORMER IN CENTER OF CULDESAC HOH CIRCLE.
215	668344.79	932709.96	345.39	SSN, 60-D NAIL W/ BLUE WHISKERS, 10' E OF E EDGE OF ASPHALT SATSOP-CLOQUALLUMDR. AT S EDGE OF GRAVEL OWA CT. 5.5' WNW OF WATER VALVE. 7.5' NNW OF STREET NAME SIGN FOR "OWA CT."
216	668254.26	934055.50	394.28	SSN, 60-D NAIL W/ BLUE WHISKERS, 0.5' S OF N EDGE GRAVEL THUNDERBIRD DR. 3.5' S OF DITCH TOP. W OF INTX W/ W TYEE PL. E OF #118 AT TOP OF HILL.
217	669040.39	934870.50	374.02	SSN, 60-D NAIL W/ BLUE WHISKERS, AT S EDGE OF GRAVEL TOTEM DR. CENTERLINE EXTENDED DRIVEWAY TO N. 33' W OF CENTERLINE DRIVEWAY TO #44.
218	668862.78	934992.79	370.03	SSS, MAG SPIKE, DOWN 0.05' IN GRAVEL. INTX TOTEM DR & SKOOKUM LN. 33' N09°W OF NNW FACE OF POWER POLE W/ LIGHT. 42' S60°W OF NNW FACE OF 36" EVERGREEN TREE AT PARK W OF RV DUMP. 48' SSE OF CENTERLINE DRIVEWAY TO #101W "KANE."
219	669058.11	935277.62	351.23	SSN, 60-D W/ BLUE WHISKERS AT N EDGE OF GRAVEL DRIVEWAY TO "DIV 7 LOT 2." 6' W OF W EDGE OF GRAVEL TO PUYALLUP DR.
220	668588.72	934886.73	371.10	SSN, 60-D W/ BLUE WHISKERS. INTX TOTEM DR & PUYALLUP DR.
221	668225.50	934587.30	381.10	SSN, 60-D W/ BLUE WHISKERS. SW QUADRANT INTX TOTEM DR & W THUNDERBIRD DR.
222	668261.95	934165.85	396.17	SSN, 60-D W/ WHITE WHISKERS. NW QUADRANT INTX W TYEE PL & W THUNDERBIRD DR.
223	668636.03	935242.42	370.17	SSHT=HUB W/ SMALL MAG NAIL, W/ BLUE WHISKERS IN GRASS AT TOP BANK/SHOULDER E SIDE PUYALLUP DR.
224	668236.84	934922.95	384.08	SSN, 60-D NAIL W/ BLUE WHISKERS, DOWN 0.1' IN DIRT. 0.5' N OF N EDGE OF GRAVEL THUNDERBIRD DR. 18' W OF CENTERLINE DRIVEWAY TO "MORENO."
225	668214.72	935244.33	420.55	SSN, 60-D NAIL W/ BLUE WHISKERS AT GRADE IN DIRT. 2' S OF S EDGE OF GRAVEL THUNDERBIRD DR. 39' W OF CENTERLINE DRIVEWAY TO #290.
226	668693.41	934585.82	408.24	SSN, 60-D NAIL W/ BLUE WHISKERS DOWN 0.05' IN GRASS. 1' E OF E EDGE GRAVEL OF W TYEE PL. 6' SSE OF S END OF WOOD FENCE. W OF POWER POLE "MASON CO PUD 3 #003840."
227	670737.16	932806.69	383.66	SFRC=FOUND REBAR W/ CAP, 1/2" REBAR W/ YELLOW PLASTIC "K BLUHM" CAP. 16.22' S82°W OF 12" ALDER BEARING TREE W/ BLAZES & SECTION CORNER CARD. NW CORNER OF DIVISION 4 PLAT.
3677	669099.03	932769.83	344.33	SFP=FOUND PIPE, 1/2" INSIDE DIAMETER PIPE. 0.6' ABOVE GRADE. AT ALDER CLUSTER W/ FOUR BLAZES & BOUNDARY SIGN. SW TIP OF DIVISION 4 PLAT.
3680	668743.59	932715.65	341.30	SSN*TEMP, TEMPORARY CONTROL. MAG NAIL W/ FLAGGING. AT W KIOWA, JUST OFF SATSOP-CLOQUALLUM RD.
3814	668367.52	932875.94	340.66	SSN*TEMP, TEMPORARY CONTROL. MAG NAIL W/ FLAGGING. IN GRASS, S SHOULDER OWA CT, IN CURVE.
5/186	668878 78	034641 06	104.40	SERC 5/8" REBAR W/ VELLOW PLASTIC "ROSE 44645" CAP

668878.78 934641.96 404.49 SFRC, 5/8" REBAR W/ YELLOW PLASTIC "ROSE 44645" CAP.

369.28 SFP, 7/8" OUTSIDE DIAMETER IRON PIPE. 0.2' ABOVE GRADE. AT PIPE MARKER.

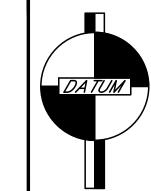

RIGHT-OF-WAY DISCLAIMER

SHOWN HEREON ARE BASED ON AVAILABLE INFORMATION, NOT ON A SURVEYED LOCATION AND ARE ONLY APPROXIMATE.


THE RIGHT-OF-WAY AND/OR PROPERTY LINES


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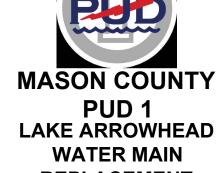
**VERTICAL:** NAVD88 **HORIZONTAL**: NAD83/2011 W.S.P.C.S. S. ZONE

Gray & Osborne, Inc. CONSULTING ENGINEERS

1130 RAINIER AVENUE SOUTH, SUITE 300 SEATTLE, WASHINGTON 98144 (206) 284-0860



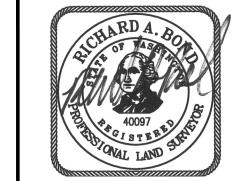

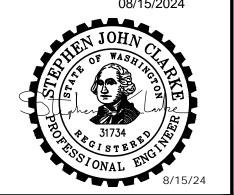

REPLACEMENT

160 W SATSOP CLOQUALLUM RD., ELMA, WA 98541

No. DATE REVISION ISSUED FOR:

ISSUE DATE: AUG 2024 APPROVED BY: M. JOHNSON CHECKED BY: R. BOND DRAWN BY: B. HAYDEN DESIGNER: P. SMILEY

SURVEY.DWG TWO INCHES AT FULL SCALE.


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**GENERAL** 

IF NOT, SCALE ACCORDINGLY


**SURVEY CONTROL** NOTES

DRAWING: **G-4** OF: **5** 



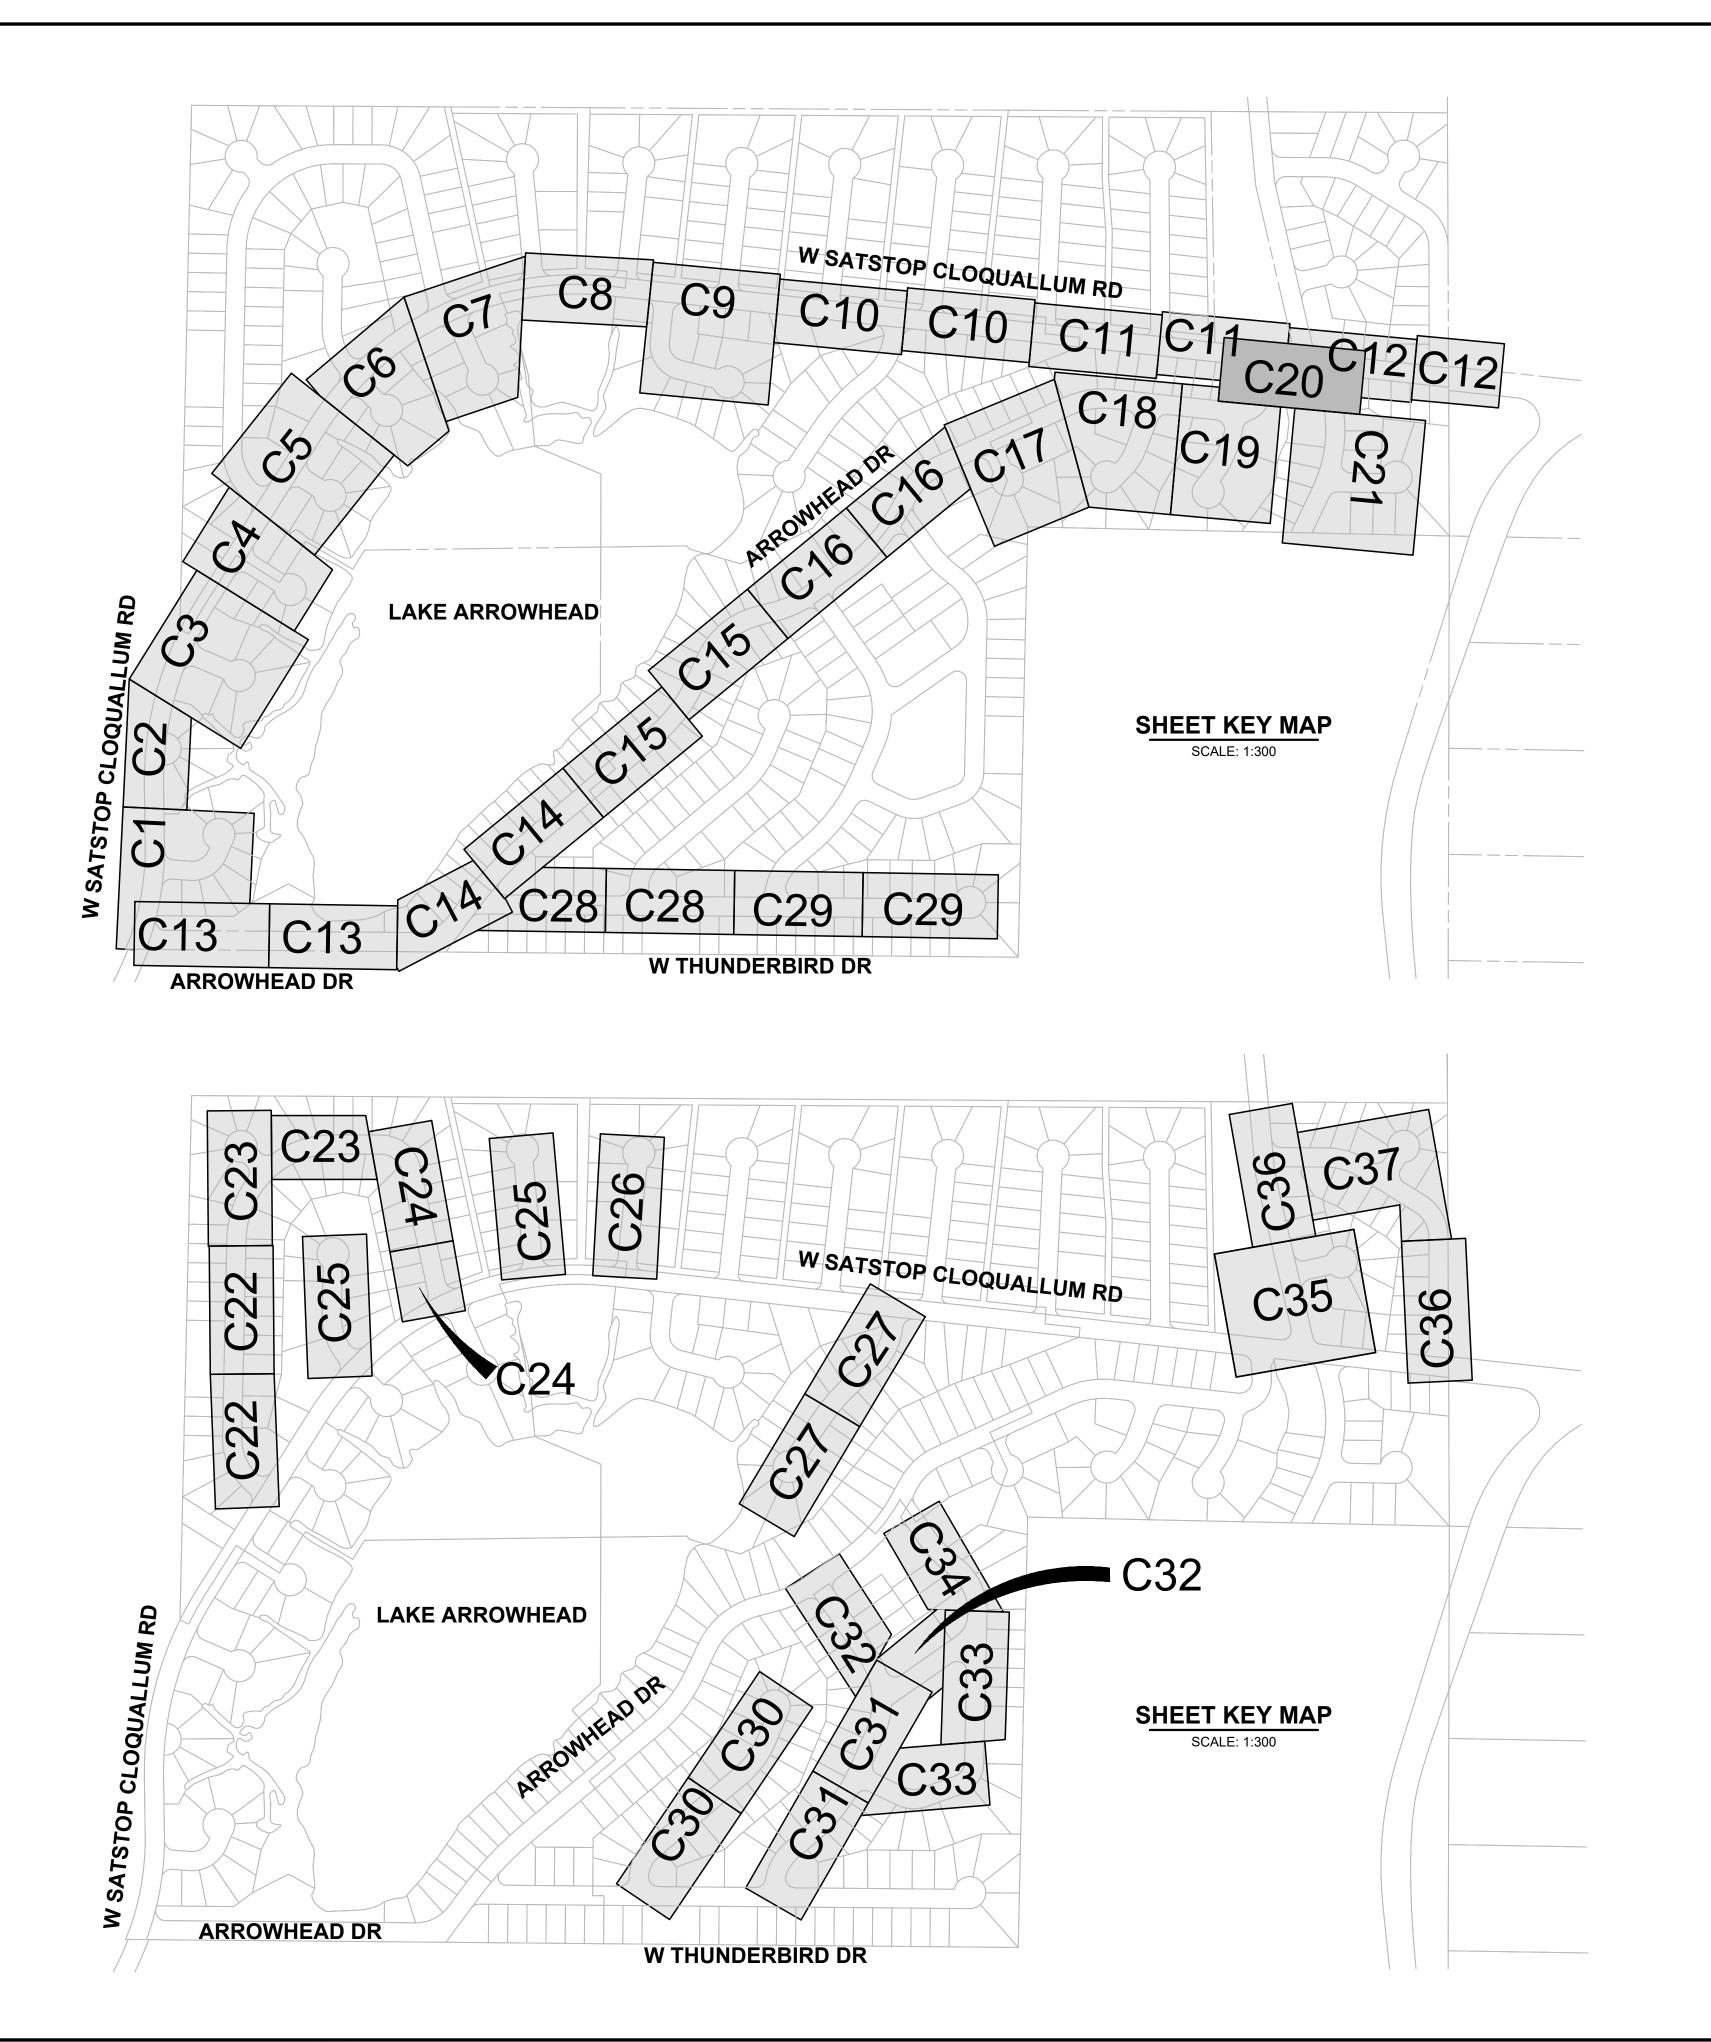

1130 RAINIER AVENUE SOUTH, SUITE 300 SEATTLE, WASHINGTON 98144 (206) 284-0860

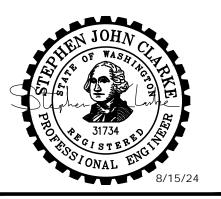



REPLACEMENT 160 W SATSOP CLOQUALLUM RD., ELMA, WA 98541

No. DATE REVISION

ISSUED FOR:

BID

ISSUE DATE: AUG 2024

APPROVED BY: S. CLARKE
CHECKED BY: M. JOHNSON
DRAWN BY: P. SMILEY
DESIGNER: P. SMILEY
G & O JOB NO.: 22249

TWO INCHES AT FULL SCALE.
IF NOT, SCALE ACCORDINGLY

KEYMAP.DWG

**GENERAL** 

SHEET KEYMAP

DRAWING: **G-5** OF: **5** 

#### GENERAL NOTES FOR TARGETED DRAINAGE PLAN:

- ALL GRADING SHALL COMPLY WITH PERMIT CONDITIONS, CURRENT MASON COUNTY PUD AND MASON COUNTY CODES AND DEVELOPMENT STANDARDS, AND STATE (WSDOT) STANDARD SPECIFICATIONS, CURRENT EDITION.
- 2. IT SHALL BE THE OBLIGATION AND RESPONSIBILITY OF THE CONTRACTOR TO ADDRESS ANY NEW CONDITIONS THAT MAY BE CREATED BY THE CONTRACTOR'S ACTIVITIES AND TO PROVIDE ADDITIONAL FACILITIES THAT MAY BE NEEDED TO PROTECT THE NATURAL FEATURES OR ADJACENT PROPERTIES.
- THE TEMPORARY EROSION/SEDIMENTATION CONTROL FACILITIES SHALL BE CONSTRUCTED PRIOR TO ANY GRADING OR SITE WORK. THESE FACILITIES MUST BE SATISFACTORILY MAINTAINED UNTIL CONSTRUCTION AND LANDSCAPING IS COMPLETED AND WITHIN 30 DAYS OF FINAL SITE STABILIZATION OR UNTIL THE POTENTIAL FOR ON-SITE EROSION HAS PASSED.
- ALL PERSONS ENGAGING IN CONSTRUCTION ACTIVITIES SHALL PREVENT OR MINIMIZE EROSION AND SEDIMENTATION ON-SITE, AND SHALL PROTECT PROPERTIES AND WATER COURSES DOWNSTREAM FROM THE SITE.
- NON COMPLIANCE WITH THE EROSION CONTROL REQUIREMENTS, WATER QUALITY REQUIREMENTS AND/OR CLEARING LIMITS MAY RESULT IN REVOCATION OF PROJECT PERMITS, REVOCATION OF PLAN APPROVAL, AND BOND FORECLOSURES.
- PRIOR TO INITIATION OF SITE WORK, HIGHLY VISIBLE MARKERS SUCH AS ORANGE BARRIER FENCING OR FLAGGING SHALL BE USED TO IDENTIFY CLEARING LIMITS AND EXISTING NGPA AREAS.
- ALL STREETS SHALL BE KEPT CLEAR OF DIRT AND DEBRIS DURING EXCAVATION AND FILL OPERATIONS. SWEEP STREETS IMMEDIATELY WHEN DIRT HAS BEEN TRACKED ONTO PAVED SURFACES.
- STOCKPILES ARE TO BE LOCATED IN SAFE AREAS AND ADEQUATELY PROTECTED WITHIN 24 HOURS OF FORMATION TO PREVENT SOIL LOSS.
- STORM SEWER INLETS RECEIVING SITE STORM WATER RUNOFF DURING CONSTRUCTION SHALL BE PROTECTED SO THAT WATER WILL NOT ENTER THE INLET WITHOUT FIRST BEING FILTERED OR OTHERWISE TREATED TO MINIMIZE THE AMOUNT OF SEDIMENT ENTERING THE INLET.
- 10. FROM MAY 1 TO SEPTEMBER 30, NO SOIL SHALL REMAIN EXPOSED FOR MORE THAN 7 DAYS. DENUDED AREAS SHALL BE COVERED BY MULCH, SOD, PLASTIC OR EQUIVALENT BMP LISTED IN THE WASHINGTON STATE DEPARTMENT OF ECOLOGY STORMWATER MANAGEMENT MANUAL FOR WESTERN WASHINGTON FROM OCTOBER 1 TO APRIL 30. NO SOIL SHALL REMAIN EXPOSED FOR MORE THAN 2 DAYS. SEE WET SEASON SUPPLEMENTAL GRADING NOTES FOR ADDITIONAL BMP REQUIREMENTS.
- 11. WATER RESULTING FROM THE DEWATERING OF TRENCHES AND EXCAVATIONS SHALL BE FILTERED PRIOR TO DISCHARGE AS REQUIRED TO MEET TURBIDITY PERMITS. DISCHARGE OF SURFACE WATER FROM THE SITE SHALL BE SUBJECT TO MONITORING BY THE OWNER, AND TREATMENT AND/OR DIVERSION TO THE SANITARY SEWER SYSTEM WHERE APPROPRIATE, IN ACCORDANCE WITH THESE PLANS AND PROJECT SPECIFICATIONS. MAXIMUM ALLOWABLE TURBIDITY SHALL BE 5 NTU OVER BACKGROUND. DIVERSION OF STORM WATER DISCHARGE TO THE SANITARY SEWER SYSTEM SHALL BE SUBJECT TO OWNERS APPROVAL AND TO ANY PRE-TREATMENT REQUIREMENTS IMPOSED BY THE OWNER.
- 12. CONTRACTOR IS RESPONSIBLE FOR PREVENTING SURFACE WATER FROM RUNNING INTO EXCAVATIONS AND/OR PUMPING SURFACE RUN-OFF FROM EXCAVATION AND WORK AREA AS NEEDED.
- 13. FILTER FABRIC FENCE AND ALL OTHER TESC MEASURES SHALL BE CHECKED IMMEDIATELY AFTER EACH RAINFALL EVENT IN EXCESS OF 0.1 INCH AND DAILY DURING PROLONGED RAIN EVENTS. MAINTENANCE AND REPAIR OF TESC FACILITIES AND STRUCTURES SHALL BE CONDUCTED IMMEDIATELY UPON RECOGNITION OF A PROBLEM OR DAMAGE. SEE ALSO NOTES ON SILTATION BARRIER MAINTENANCE, THIS SHEET.
- 14. SEDIMENT DEPOSITS SHALL BE REMOVED FROM ALL TEMPORARY DRAINAGE FACILITIES AND STRUCTURES UPON REACHING A DEPTH OF 6 INCHES.
- 15. SUFFICIENT TEST BMP MATERIALS AND SUPPLIES TO PROTECT THE ENTIRE SITE SHALL BE STOCK PILED ON SITE.
- CONSTRUCTION ACCEPTANCE WILL BE SUBJECT TO PLACEMENT OF STRAW OR WOOD FIBER MULCH OR EROSION CONTROL BLANKETS THAT FULFILLS THE REQUIREMENT OF THE APPROVED CONSTRUCTION PLANS AND MASON COUNTY DRAINAGE STANDARDS.
- IMMEDIATELY FOLLOWING FINISH GRADING, PERMANENT VEGETATION SHALL BE APPLIED. ALL DISTURBED AREAS NOT DESIGNATED FOR OTHER SURFACE RESTORATION SHALL MULCHED WITH STRAW OR WOOD FIBER MATERIAL.
- 18. IF REQUIRED, SURFACE RUNOFF CONTROL MEASURES SUCH AS GRADIENT TERRACES, INTERCEPTOR DIKE/SWALES, LEVEL SPREADERS, AND SEDIMENT BASINS SHALL BE INSTALLED PRIOR TO MULCHING.
- TRANSPORT ALL EXCAVATED MATERIALS OFF SITE TO APPROVED STORAGE LOCATION, EXCEPT AS ALLOWED IN THE SPECIFICATIONS. LIMIT TRUCK ACTIVITY TO PAVED AND GRAVELED SURFACES ONLY. MAINTAIN TRUCK ACCESS AREAS WHERE CLEAR OF DIRT AND SEDIMENT DURING PERIODS OF TRUCK ACTIVITY BY SWEEPING.
- ADDITIONAL REQUIREMENTS FOR UTILITIES. THE INSTALLATION OF UNDERGROUND UTILITY LINES SHALL BE SUBJECT TO THE FOLLOWING ADDITIONAL REQUIRMENTS:
  - a) NO MORE THAN FIVE HUNDRED (300) FEET OF TRENCH MAY REMAIN OPEN AT ONE TIME:
  - b) EXCAVATED MATERIAL SHALL BE PLACED ON THE UPHILL SIDE OF THE TRENCHES, UNLESS INCONSISTENT WITH SAFETY OR SITE CONSTRAINTES

#### **CONSTRUCTION SEQUENCE:**

- ATTEND PRE-CONSTRUCTION MEETING.
- FLAG OR FENCE CLEARING LIMITS
- INSTALL PERIMETER PROTECTION (SILT FENCE, BRUSH BARRIER, ETC.)
- CONSTRUCT SURFACE WATER CONTROLS IF NEEDED (INTERCEPTOR DIKES, STRAW BALE BARRIERS, ETC.) SIMULTANEOUSLY WITH CLEARING AND GRADING FOR WATER MAIN CONSTRUCTION.
- MAINTAIN EROSION CONTROL MEASURES IN ACCORDANCE WITH COUNTY REQUIREMENTS AND MANUFACTURER'S RECOMMENDATIONS.
- RELOCATE SURFACE WATER CONTROLS OR EROSION CONTROL MEASURES, OR INSTALL NEW MEASURES SO THAT AS SITE CONDITIONS CHANGE, THE EROSION AND SEDIMENT CONTROL IS ALWAYS IN ACCORDANCE WITH COUNTY REQUIREMENTS.
- COVER ALL AREAS THAT WILL BE UNWORKED FOR MORE THAN TWO DAYS BETWEEN OCTOBER 1ST AND APRIL 30TH OR SEVEN DAYS BETWEEN MAY 1ST AND SEPTEMBER 30TH WITH STRAW, WOOD FIBER MULCH, COMPOST, PLASTIC SHEETING OR EQUIVALENT.
- STABILIZE ALL AREAS WITHIN SEVEN DAYS OF REACHING FINAL GRADE.
- PLACE STRAW OR FIBER MULCH ON ANY AREAS TO REMAIN UNWORKED FOR MORE THAN 30 DAYS.
- 10. UPON COMPLETION OF THE PROJECT, STABILIZE ALL DISTURBED AREAS AND REMOVE BMPS WHEN APPROPRIATE.

#### WET SEASON SUPPLEMENTAL GRADING NOTES (OCTOBER 1 THROUGH JUNE 30)

- CONSTRUCTION SEQUENCE SHALL BE MODIFIED TO MINIMIZE THE AREA OF UNSTABILIZED SOIL, WITH A MAXIMUM OF 1,000 SQUARE FEET EXPOSED AT ANY TIME.
- EARTHEN AREAS WITH THE POTENTIAL TO CONTRIBUTE SEDIMENTS DURING STORM EVENTS AND WHERE EARTH MOVEMENT IS NOT ANTICIPATED WITHIN 48-HOURS SHALL BE STABILIZED USING ONE OR MORE OF THE FOLLOWING BMPS INSTALLED IN ACCORDANCE WITH THE CURRENT MASON COUNTY DRAINAGE MANUAL: STRAW MULCH OF 4" THICKNESS, PLASTIC SHEETING, EROSION CONTROL BLANKETS.
- WET SEASON TEST MEASURES SHALL BE EXPANDED TO INCLUDE:
  - A) IMPLEMENT A PLAN TO PUMP TURBID WATER TO THE SANITARY SEWER SYSTEM OR TO PUMP TO ON SITE TANKS AND TREAT PRIOR TO DISCHARGE TO THE STORM SYSTEM. THE PLAN SHALL BE PRE-APPROVED BY THE OWNER PRIOR TO START OF WET SEASON GRADING AND SHALL BE SUBJECT TO MONITORING BY THE OWNER AS DESCRIBED IN THE SPECIFICATIONS. PUMPING TO THE SANITARY SEWER SYSTEM SHALL REQUIRE OWNERS APPROVAL AND SHALL BE SUBJECT TO SUCH CONDITIONS AS THE OWNER MAY IMPOSE, AS DESCRIBED IN THE SPECIFICATIONS.
  - B) STOCKPILE BUILDING MATERIALS ON PAVED AND/OR GRAVELED SURFACES TO MINIMIZE TRAFFIC ON ERODABLE SURFACES.
- 4. SLOPES WITHOUT ESTABLISHED GROUND COVER SHALL BE STABILIZED WITH PLASTIC SHEETING, 6 MIL. MINIMUM. SHEETING SHALL BE ANCHORED WITH SANDBAGS LOCATED 5 FEET APART ON THE PERIMETER AND 10 FEET ON CENTER ELSEWHERE ON THE SHEETING. A MINIMUM OF 2 FEET OVERLAP IS REQUIRED FOR OVERLAPPING SHEETS.
- WHEN RAINFALL IS HEAVY (DEFINED AS SUFFICIENT TO PRODUCE SEDIMENT RUNOFF FROM EXPOSED DIRT). ALL EXPOSED EARTHWORK SHALL BE COVERED. NO OTHER CONSTRUCTION ACTIVITY SHALL OCCUR ON PERVIOUS SURFACES DURING THESE PERIODS OF HEAVY RAINFALL.
- ALL DRAINAGE SWALES AND AREAS WITH 2:1 OR GREATER SLOPES SHALL BE LINED WITH STAKED EROSION CONTROL BLANKETS.

#### **CLEAR PLASTIC COVERINGS:**


- CLEAR PLASTIC COVERINGS SHALL HAVE A MINIMUM THICKNESS OF 6 MIL AND MEET THE REQUIREMENTS OF WSDOT/APWA SECTION 9-14.5.
- COVERING SHALL BE INSTALLED AND MAINTAINED TIGHTLY IN PLACE BY USING SANDBAGS OR TIRES OR ROPES WITH A MAXIMUM 10 FOOT GRID SPACING IN ALL DIRECTIONS. ALL SEAMS SHALL BE TAPED OR WEIGHTED DOWN FULL LENGTH AND THERE SHALL BE AT LEAST A 1 TO 2 FOOT OVERLAP OF ALL SEAMS. SEAMS SHOULD THEN BE ROLLED AND STAKED OR TIED.
- WHEN THE COVERING IS USED ON BARE SOIL SLOPES, IT SHALL BE LEFT IN PLACE UNTIL STRAW OR WOOD FIBER MULCH IS APPLIED.
- SHEETING SHOULD BE TOED IN AT THE TOP OF THE SLOPE TO PREVENT SURFACE FLOW BENEATH THE PLASTIC.
- SHEETING SHOULD BE REMOVED AS SOON AS IS POSSIBLE TO PREVENT BURNING THE VEGETATION.
- CHECK SHEETING REGULARLY FOR RIPS AND PLACES WHERE THE PLASTIC MAY BE DISLODGED. CONTACT BETWEEN THE PLASTIC AND THE GROUND SHOULD ALWAYS BE MAINTAINED. ANY AIR BUBBLES FOUND SHOULD BE REMOVED IMMEDIATELY OR THE PLASTIC MAY RIP DURING THE NEXT WINDY PERIOD. RE-ANCHOR OR REPLACE THE PLASTIC AS NECESSARY.

#### **FILTER FENCE:**

- THE FILTER FABRIC SHALL BE PURCHASED IN A CONTINUOUS ROLL CUT TO THE LENGTH OF THE BARRIER TO AVOID USE OF JOINTS. WHEN JOINTS ARE NECESSARY, FILTER CLOTH SHALL BE SPLICED TOGETHER ONLY AT A SUPPORT POST, WITH A MINIMUM 6 INCH OVERLAP. AND BOTH ENDS SECURELY FASTENED TO THE POST.
- 2. POSTS SHALL BE SPACED A MAXIMUM OF 6 FEET APART AND DRIVEN SECURELY INTO THE GROUND A MINIMUM OF 30 INCHES (WHERE PHYSICALLY POSSIBLE).
- A TRENCH SHALL BE EXCAVATED APPROXIMATELY 8 INCHES WIDE AND 8 INCHES DEEP ALONG THE LINE OF POSTS AND UPSLOPE FROM THE BARRIER. THE TRENCH SHALL BE CONSTRUCTED TO FOLLOW THE CONTOUR.
- WHEN SILT FILM FILTER FABRIC IS USED, A WIRE MESH SUPPORT FENCE SHALL BE FASTENED SECURELY TO THE UPSLOPE SIDE OF THE POSTS USING TIE WIRES, HOG RINGS, OR HEAVY-DUTY WIRE STAPLES AT LEAST 1 INCH LONG. THE WIRE SHALL EXTEND INTO THE TRENCH A MINIMUM OF 4 INCHES AND SHALL NOT EXTEND MORE THAN 36 INCHES ABOVE THE ORIGINAL GROUND SURFACE.
- SILT FILM FILTER FABRIC SHALL BE WIRED TO THE FENCE, AND 20 INCHES OF THE FABRIC SHALL EXTEND INTO THE TRENCH. THE FABRIC SHALL NOT EXTEND MORE THAN 36 INCHES ABOVE THE ORIGINAL GROUND SURFACE. FILTER FABRIC SHALL NOT BE STAPLED TO EXISTING TREES. OTHER TYPES OF FABRIC MAY BE STAPLED TO THE
- WHEN EXTRA-STRENGTH OR MONOFILAMENT FABRIC AND CLOSER POST SPACING ARE USED, THE WIRE MESH SUPPORT FENCE MAY BE ELIMINATED. IN SUCH A CASE THE FILTER FABRIC IS STAPLED OR WIRED DIRECTLY TO THE POSTS WITH ALL OTHER PROVISIONS OF FILTER FENCE NOTE 5 APPLYING. EXTRA CARE SHOULD BE USED WHEN JOINING OR OVERLAPPING THESE STIFFER FABRICS.
- THE BASE OF THE SILT FENCE SHALL BE SECURED WITH COMPACTED NATIVE SOIL OR 3/4" MIN DIA WASHED GRAVEL. THE MATERIAL SHALL BE WELL BEDDED TO ENSURE GOOD CONTACT BETWEEN THE FABRIC AND THE TRENCH BOTTOM.
- FILTER FABRIC FENCES SHALL BE REMOVED WHEN THEY HAVE SERVED THEIR USEFUL PURPOSE, BUT NOT BEFORE THE UPSLOPE AREA HAS BEEN PERMANENTLY STABILIZED. RETAINED SEDIMENT MUST BE REMOVED AND PROPERLY DISPOSED OF AND MULCHED.

#### FILTER FENCE MAINTENANCE

- INSPECT IMMEDIATELY AFTER EACH RAINFALL, AND AT LEAST DAILY DURING PROLONGED RAINFALL. REPAIR AS NECESSARY.
- SEDIMENT MUST BE REMOVED WHEN IT REACHES APPROXIMATELY ONE THIRD THE HEIGHT OF THE FENCE, ESPECIALLY IF HEAVY RAINS ARE EXPECTED.
- ANY SEDIMENT DEPOSITS REMAINING IN PLACE AFTER THE FILTER FENCE IS NO LONGER REQUIRED SHALL BE DRESSED TO CONFORM WITH THE EXISTING GRADE. PREPARED AND SEEDED.
- 4. ALL TEMPORARY EROSION AND SEDIMENT CONTROL MEASURES SHALL BE REMOVED WITHIN 30 DAYS AFTER FINAL SITE STABILIZATION IS ACHIEVED OR AFTER THE TEMPORARY "BEST MANAGEMENT PRACTICES" ARE NO LONGER NEEDED. TRAPPED SEDIMENT SHALL BE REMOVED OR STABILIZED ON SITE. DISTURBED SOIL AREAS RESULTING FROM REMOVAL SHALL BE PERMANENTLY STABILIZED.

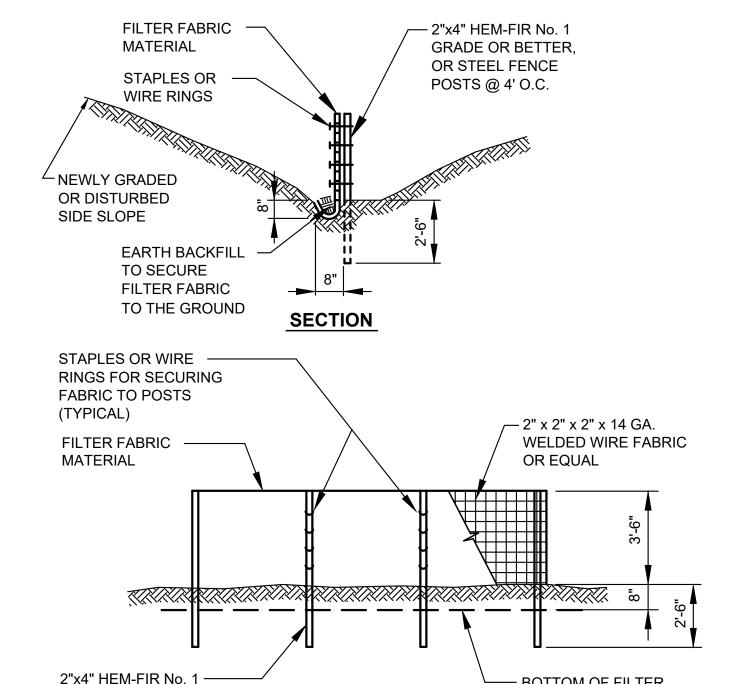




**ELEVATION** 


GRADE OR BETTER,

OR STEEL FENCE

POSTS @ 4' O.C.

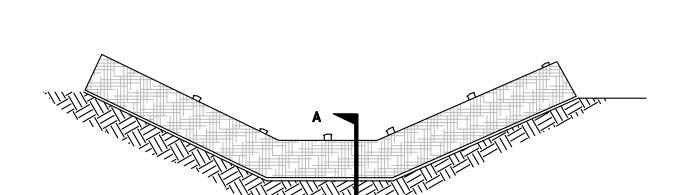

PLACEMENT OF STRAW WATTLE

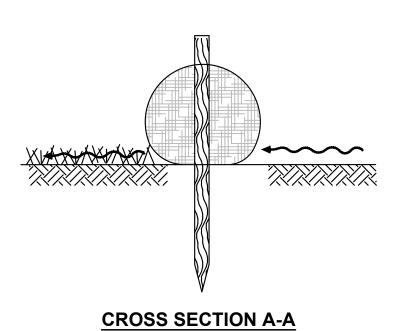



#### NOTES:

- BOTTOM OF FILTER


8" x 8" DITCH

FABRIC MATERIAL IN

- 1. WHERE POSSIBLE, MAINTAIN NATURAL **VEGETATION FOR SILT CONTROL**
- 2. TEMPORARY SILTATION CONTROL SHALL BE CONSTRUCTED BY PLACING FILTER FABRIC FENCES ACROSS SWALES UTILIZING FILTER SYSTEM PRIOR TO DISCHARGE
- BE MAINTAINED IN A SATISFACTORY CONDITION UNTIL SUCH TIME THAT CLEARING AND/OR CONSTRUCTION IS COMPLETED AND SURFACE RESTORATION HAS BEEN COMPLETED
- 4. RETURN SILTATION CONTROL AREAS TO ORIGINAL GROUND CONDITIONS, **UNLESS SPECIFICALLY DIRECTED** OTHERWISE BY THE ENGINEER



1130 RAINIER AVENUE SOUTH SUITE 300 SEATTLE. WASHINGTON 98144 (206) 284-0860

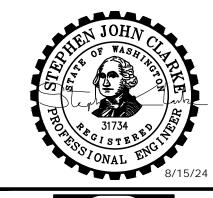



PUD 1 LAKE ARROWHEAD **WATER MAIN** REPLACEMENT

160 W SATSOP CLOQUALLUM RD., ELMA, WA 98541

REVISION No. DATE

ISSUED FOR: **ISSUE DATE:** AUG 2024 APPROVED BY: S. CLARKE CHECKED BY: M. JOHNSON DRAWN BY: P. SMILEY **DESIGNER:** P. SMILEY

22249

DETAILS.DWG

TWO INCHES AT FULL SCALE IF NOT, SCALE ACCORDINGLY

G & O JOB NO .:

**DETAILS** 

**TESC NOTES &** 


**DETAILS** 

DRAWING: **D-1** OF: **3** 


NOTE:

1. MINIMUM COLD BEND RADIUS FOR 6" HDPE SDR 11 = 12.5' (25 x PIPE OD).




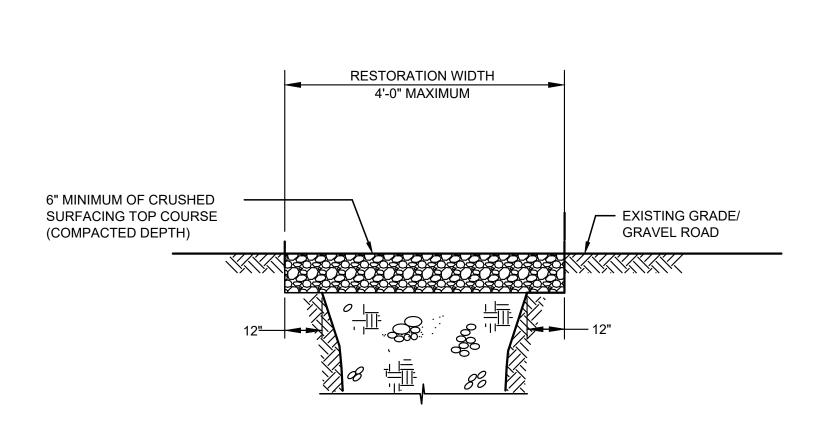



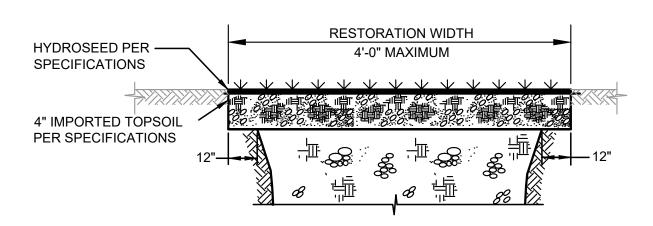




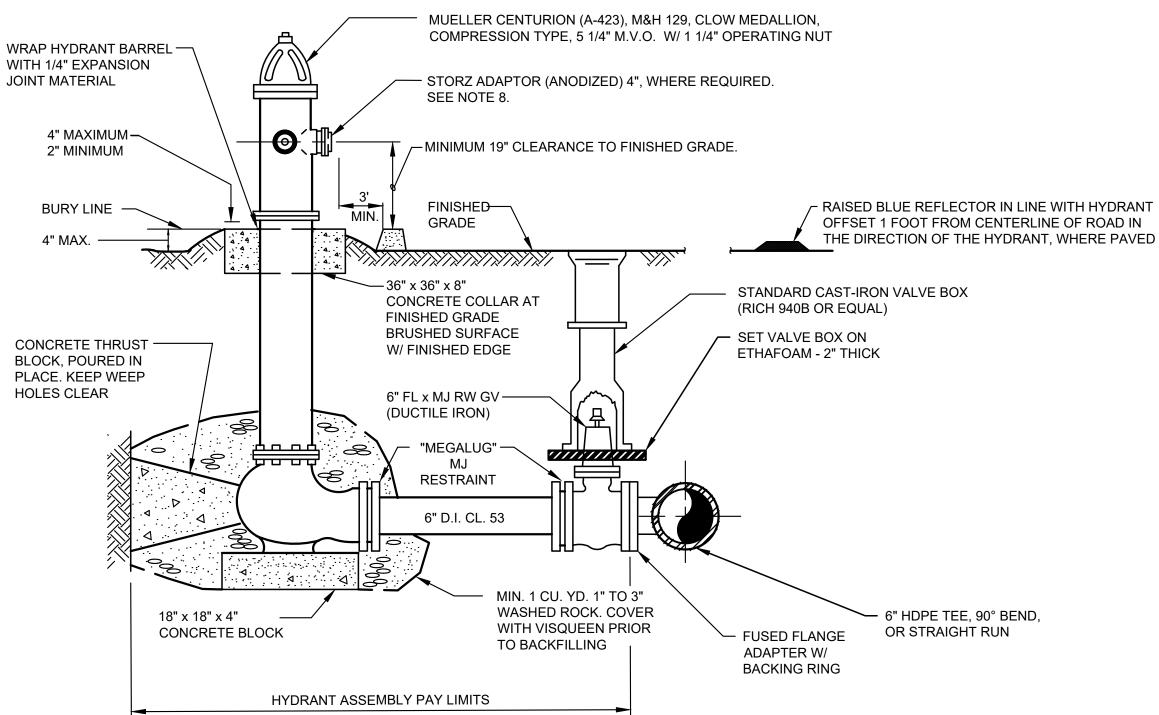

#### NOTES:

- 1. AFTER INSTALLATION, HYDRANT SHALL BE WIRE BRUSHED, PRIMED WITH RUST-OLEUM HIGH PERFORMANCE METAL PRIMER & FIELD PAINTED WITH TWO COATS OF RUST-OLEUM PROFESSIONAL OIL-BASED SAFETY YELLOW.
- 2. WHEN HYDRANT SPOOL EXCEEDS 18', USE FULL CIRCLE MJ REPAIR SLEEVE WITH MEGALUGS OR FIELD LOK GASKETS. MAXIMUM LENGTH IS 50'.
- 3. HYDRANTS SHALL BE BREAK-AWAY TYPE IN WHICH VALVE WILL REMAIN CLOSED IF BARREL IS BROKEN.
- 4. PROVIDE MINIMUM 3'-0" CLEARANCE AND LEVEL AREA AROUND HYDRANT
- 5. GUARD POSTS MAY BE REQUIRED AS SHOWN ON THE PLANS AND/OR DIRECTED BY THE ENGINEER.
- 6. DISTANCE IN FEET TO THE VALVE BOX SHALL BE PLACED AT THE BARREL, BELOW THE PUMPER PORT, WITH 2" HIGH DECALS DESIGNED FOR USE ON FIBERGLASS BOATS.
- 7. RAISED BLUE REFLECTOR IN ACCORDANCE WITH FIRE DISTRICT REQUIREMENTS.
- 8. FIRE HYDRANT SHALL HAVE A STANDARD 3 1/2" NST PUMPER PORT AND TWO 2 1/2" NST SIDE PORTS. ALL OPENING BY TURNING COUNTER CLOCKWISE WITH 1 1/2" OPERATING NUT. 4" STORZ ADAPTER AS REQUIRE BY THE LOCAL FIRE PROTECTION AUTHORITY.




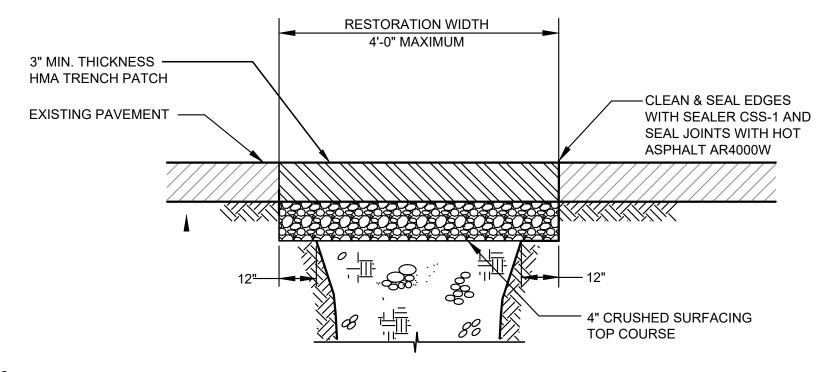

#### NOTE

- 1. ALL TRENCHES THROUGH ASPHALT PAVEMENT IN STREETS AND DRIVEWAYS THAT WILL RECEIVE TRAFFIC OR BE LEFT OVERNIGHT BEFORE FINAL RESTORATION SHALL BE TEMPORARILY REPAIRED WITH HOT MIX ASPHALT OR COLD MIX.
- 2. ASPHALT PAVEMENT REMOVAL MAY BE BY FULL DEPTH SAWCUT OR SHALL BE MADE BY EQUIPMENT THAT PRODUCES A STRAIGHT LINE.
- 3. PATCH SHALL BE MACHINE ROLLED AND FLUSH WITH EXISTING PAVEMENT. TRENCH PATCH TO BE PLACED PER SECTION 02740 OF THE SPECIFICATIONS.
- 4. CLEAN, TACK, AND SEAL ALL EDGES AND JOINTS PER MASON COUNTY STANDARDS.
- 5. TEMPORARY HMA TRENCH PATCHES OF 3" MINIMUM THICKNESS THAT MEET THE REQUIREMENTS OF THE SPECIFICATIONS FOR HMA TRENCH PATCH MAY SERVE AS THE PERMANENT TRENCH PATCH AS DETERMINED/APPROVED BY THE ENGINEER. TEMPORARY TRENCH PATCHES THAT DO NOT MEET THE REQUIREMENTS OF THE SPECIFICATIONS FOR HMA TRENCH PATCH SHALL BE REMOVED AND REPLACED W/ 3" MINIMUM OF HOT MIX ASPHALT.




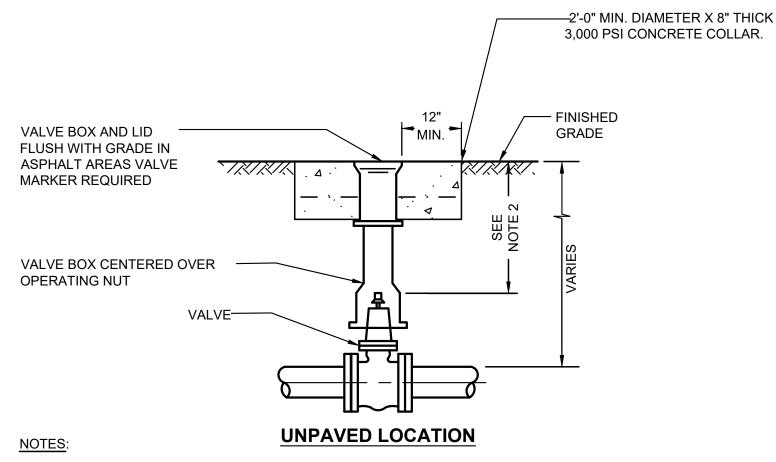

1. EACH VALVE SHALL BE PROVIDED WITH AND ADJUSTABLE CAST IRON VALVE BOX OF 5 INCHES (5") INSIDE DIAMETER. VALVE BOXES SHALL HAVE A TOP SECTION WITH AN EIGHTEEN INCH (18") MIN. LENGTH. THE VALVE BOX SHALL BE RICH No. 940 OR APPROVED EQUAL. VALVE BOX EARS SHALL BE PLACED IN LINE WITH PIPE IT SERVES.

2. 15" MINIMUM, 36" MAXIMUM FOR OPERATOR NUT. EXTENSION MAY BE REQUIRED.



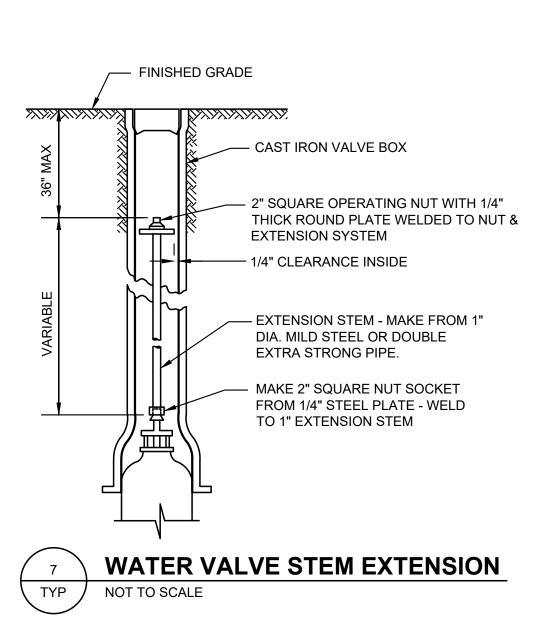

Gray & Osborne, Inc.

CONSULTING ENGINEERS

1130 RAINIER AVENUE SOUTH,

SUITE 300

SEATTLE, WASHINGTON 98144

(206) 284-0860

JOHN CLARING STATE RESIDENCE STONAL ENGINEERS TO NAL ENGI



WATER MAIN REPLACEMENT 160 W SATSOP CLOQUALLUM RD., ELMA, WA 98541

No. DATE REVISION

ISSUED FOR:

BID
ISSUE DATE: AUG 2024
APPROVED BY: S. CLARKE
CHECKED BY: M. JOHNSON
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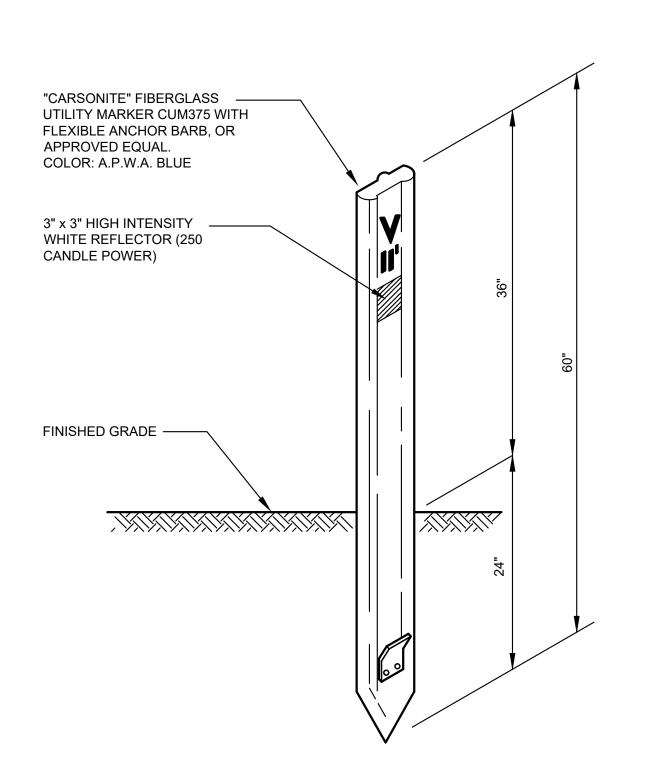
**DETAILS** 

**WATER MAIN DETAILS** 

DRAWING: D-2 OF: 3


son County PUD 1\22249.00 Lake Arrowhead Water Main Replacement\01 Desi





- 1. THE LETTER "V" AND THE DISTANCE IN FEET TO THE VALVE SHALL BE ON THE POST WITH 2" HIGH DECALS DESIGNED FOR USE ON FIBERGLASS BOATS.
- 2. EACH POST SHALL INCLUDE THE FOLLOWING DECAL: "CAUTION WATER VALVE, BEFORE DIGGING, CALL 1-800-424-5555, UTILITY UNDERGROUND LOCATION CENTER."



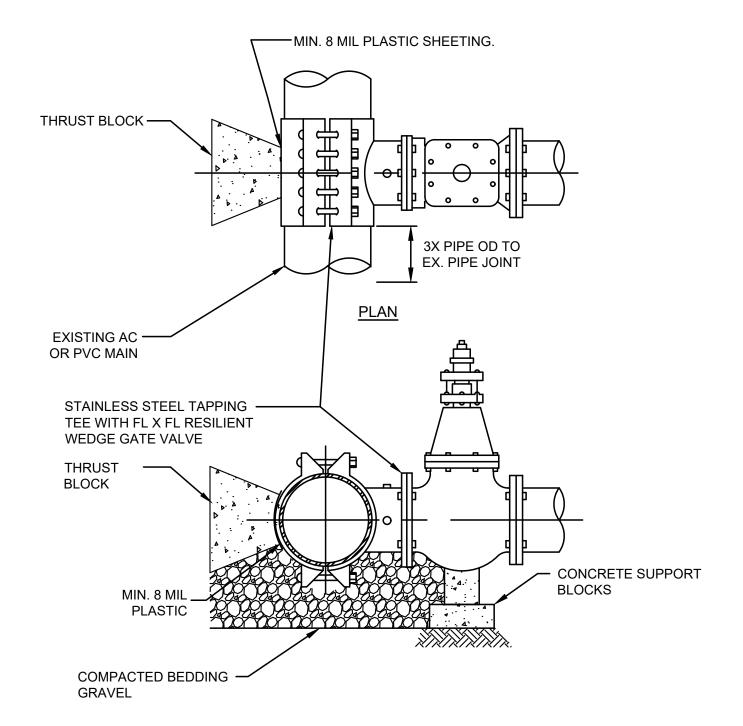


#### **ELEVATION**

#### NOTES:

- 1. ALL CONNECTIONS TO EXISTING MAIN SHALL BE MADE WITH IN PRESENCE OF AN AUTHORIZED DISTRICT REPRESENTATIVE AFTER REQUIRED TESTING.
- 2. STAINLESS STEEL TAPPING TEE SHALL BE ROMAC, SMITH BLAIR, OR JCM INDUSTRIES MODEL NO. 432 OR 462.
- 3. TAPPING TEES SHALL BE AIR PRESSURE TESTED TO 100 PSI PRIOR TO TAPPING MAIN.
- 4. VALVE MARKER SHALL BE INSTALLED PER DETAIL 2, THIS SHEET.
- 5. A 3'X3'X4' ASPHALT SURFACE COLLAR IS REQUIRED IF VALVE BOX IS SET IN GRAVEL OR UNPAVED SURFACE.
- 6. FOR SIZE ON SIZE, TAP HOLE WILL BE 1/2" MIN. LESS THAN NOMINAL PIPE OD.




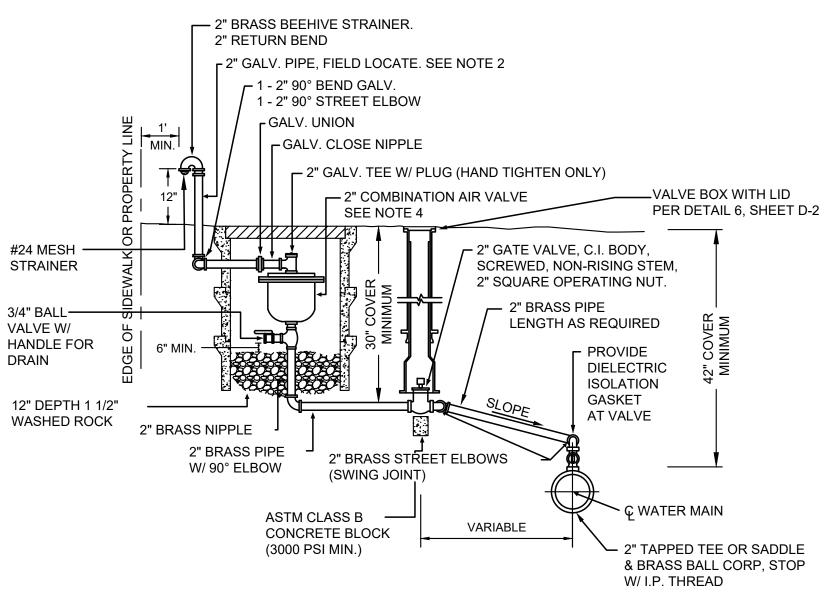


#### NOTES:

- 1. ALL PIPE AND FITTINGS FROM THE MAIN TO THE COMBINATION AIR VALVE SHALL BE BRASS WITH I.P. THREADS.
- 2. PAINT RISER WITH 2 COATS OF BLUE.
- 3. COMBINATION AIR VALVE ASSEMBLY MUST BE INSTALLED AT HIGHEST POINT IN LINE. IF HIGH POINT FALLS IN LOCATION WHERE ASSEMBLY CANNOT BE INSTALLED, PROVIDE ADDITIONAL DEPTH OF PIPE LINE TO CREATE HIGH POINT AT A LOCATION WHERE ASSEMBLY CAN BE INSTALLED.
- 4. COMBINATION AIR VALVE ASSEMBLY SHALL BE APCO MODEL 143C OR EQUAL.
- 5. BOX SHALL BE FOGTITE #1 D OR APPROVED EQUAL WITH TRAFFIC LID.
- 6. INSTALL BOX PERPENDICULAR TO CURB OR EDGE OF PAVEMENT.


### 2" COBMINATION AIR/VACUUM RELIEF ASSEMBLY NOT TO SCALE

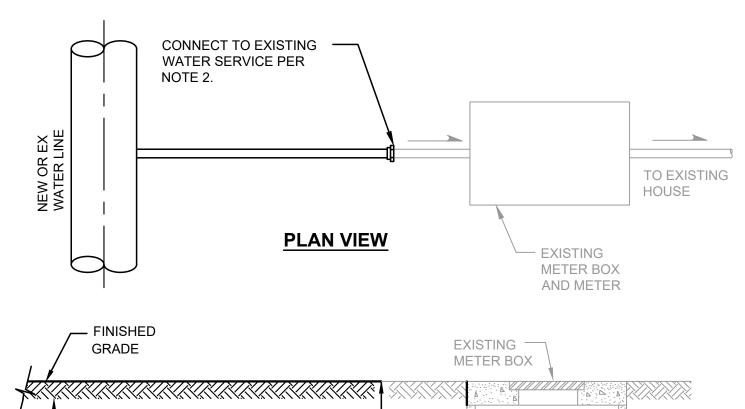

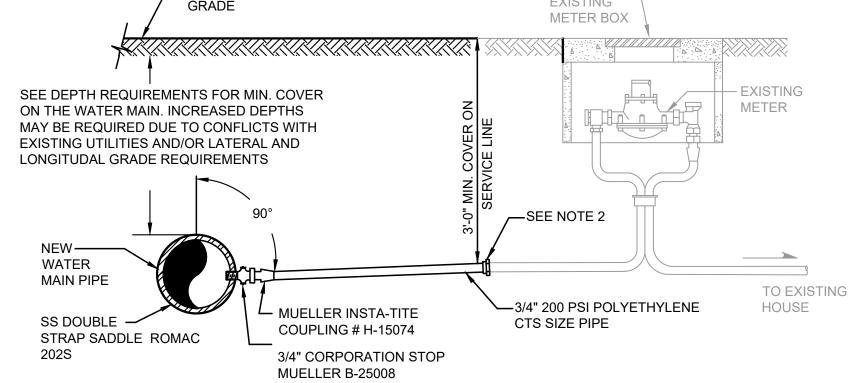

- 1. CONTRACTOR SHALL FIELD VERIFY EXISTING WATER SERVICE PIPE LOCATION, SIZE AND TYPE PRIOR TO CONSTRUCTION.
- 2. CONTRACTOR TO CONNECT TO EXISTING METER SETTER, ANGLE STOP OR AT EDGE OF PAVEMENT AS SHOWN ON PLANS WITH TRANSITION COUPLING COMPATIBLE WITH EXISTING PIPE MATERIALS.
- 3. CONNECT ALL EXISTING SERVICES IN PROJECT AREA TO NEW WATER MAIN, AS SHOWN ON PLANS AND/OR AS DIRECTED IN THE FIELD.



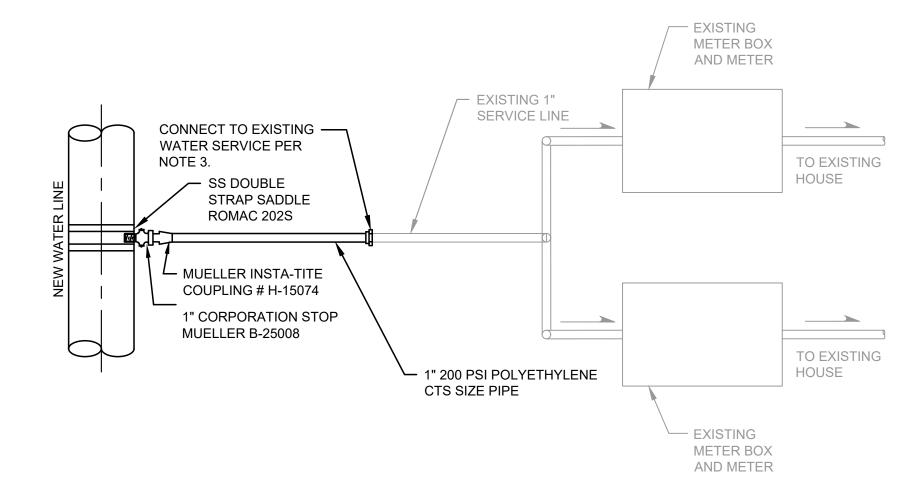

#### **PLAN VIEW**


#### NOTE:

- 1. FOR DUAL METER SERVICE LINE CONNECTIONS, THE DISTRICT WILL PROVIDE CONTRACTOR WITH 1" SERVICE SADDLE, 1" CORPORATION STOP AND FITTINGS, AND 1" POLYETHYLENE SERVICE LINE.
- 2. CONTRACTOR SHALL FIELD VERIFY EXISTING WATER SERVICE PIPE LOCATION, SIZE AND TYPE PRIOR TO CONSTRUCTION.
- 3. CONTRACTOR TO CONNECT TO EXISTING METER SETTER, ANGLE STOP OR AT EDGE OF PAVEMENT AS SHOWN ON PLANS WITH TRANSITION COUPLING COMPATIBLE WITH EXISTING PIPE MATERIALS.
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Gray & Osborne, Inc CONSULTING ENGINEERS

1130 RAINIER AVENUE SOUTH, SUITE 300 SEATTLE, WASHINGTON 98144 (206) 284-0860



MASON COUNTY PUD 1 LAKE ARROWHEAD

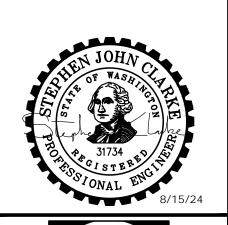**WATER MAIN** REPLACEMENT 160 W SATSOP CLOQUALLUM RD., ELMA, WA 98541

REVISION No. DATE ISSUED FOR: ISSUE DATE: AUG 2024

M. JOHNSON CHECKED BY: DRAWN BY: P. SMILEY P. SMILEY DESIGNER: G & O JOB NO .: 22249 DETAILS.DWG

S. CLARKE


APPROVED BY:

TWO INCHES AT FULL SCALE IF NOT, SCALE ACCORDINGLY

**DETAILS** 

WATER MAIN DETAILS

DRAWING: **D-3** OF: **3** 

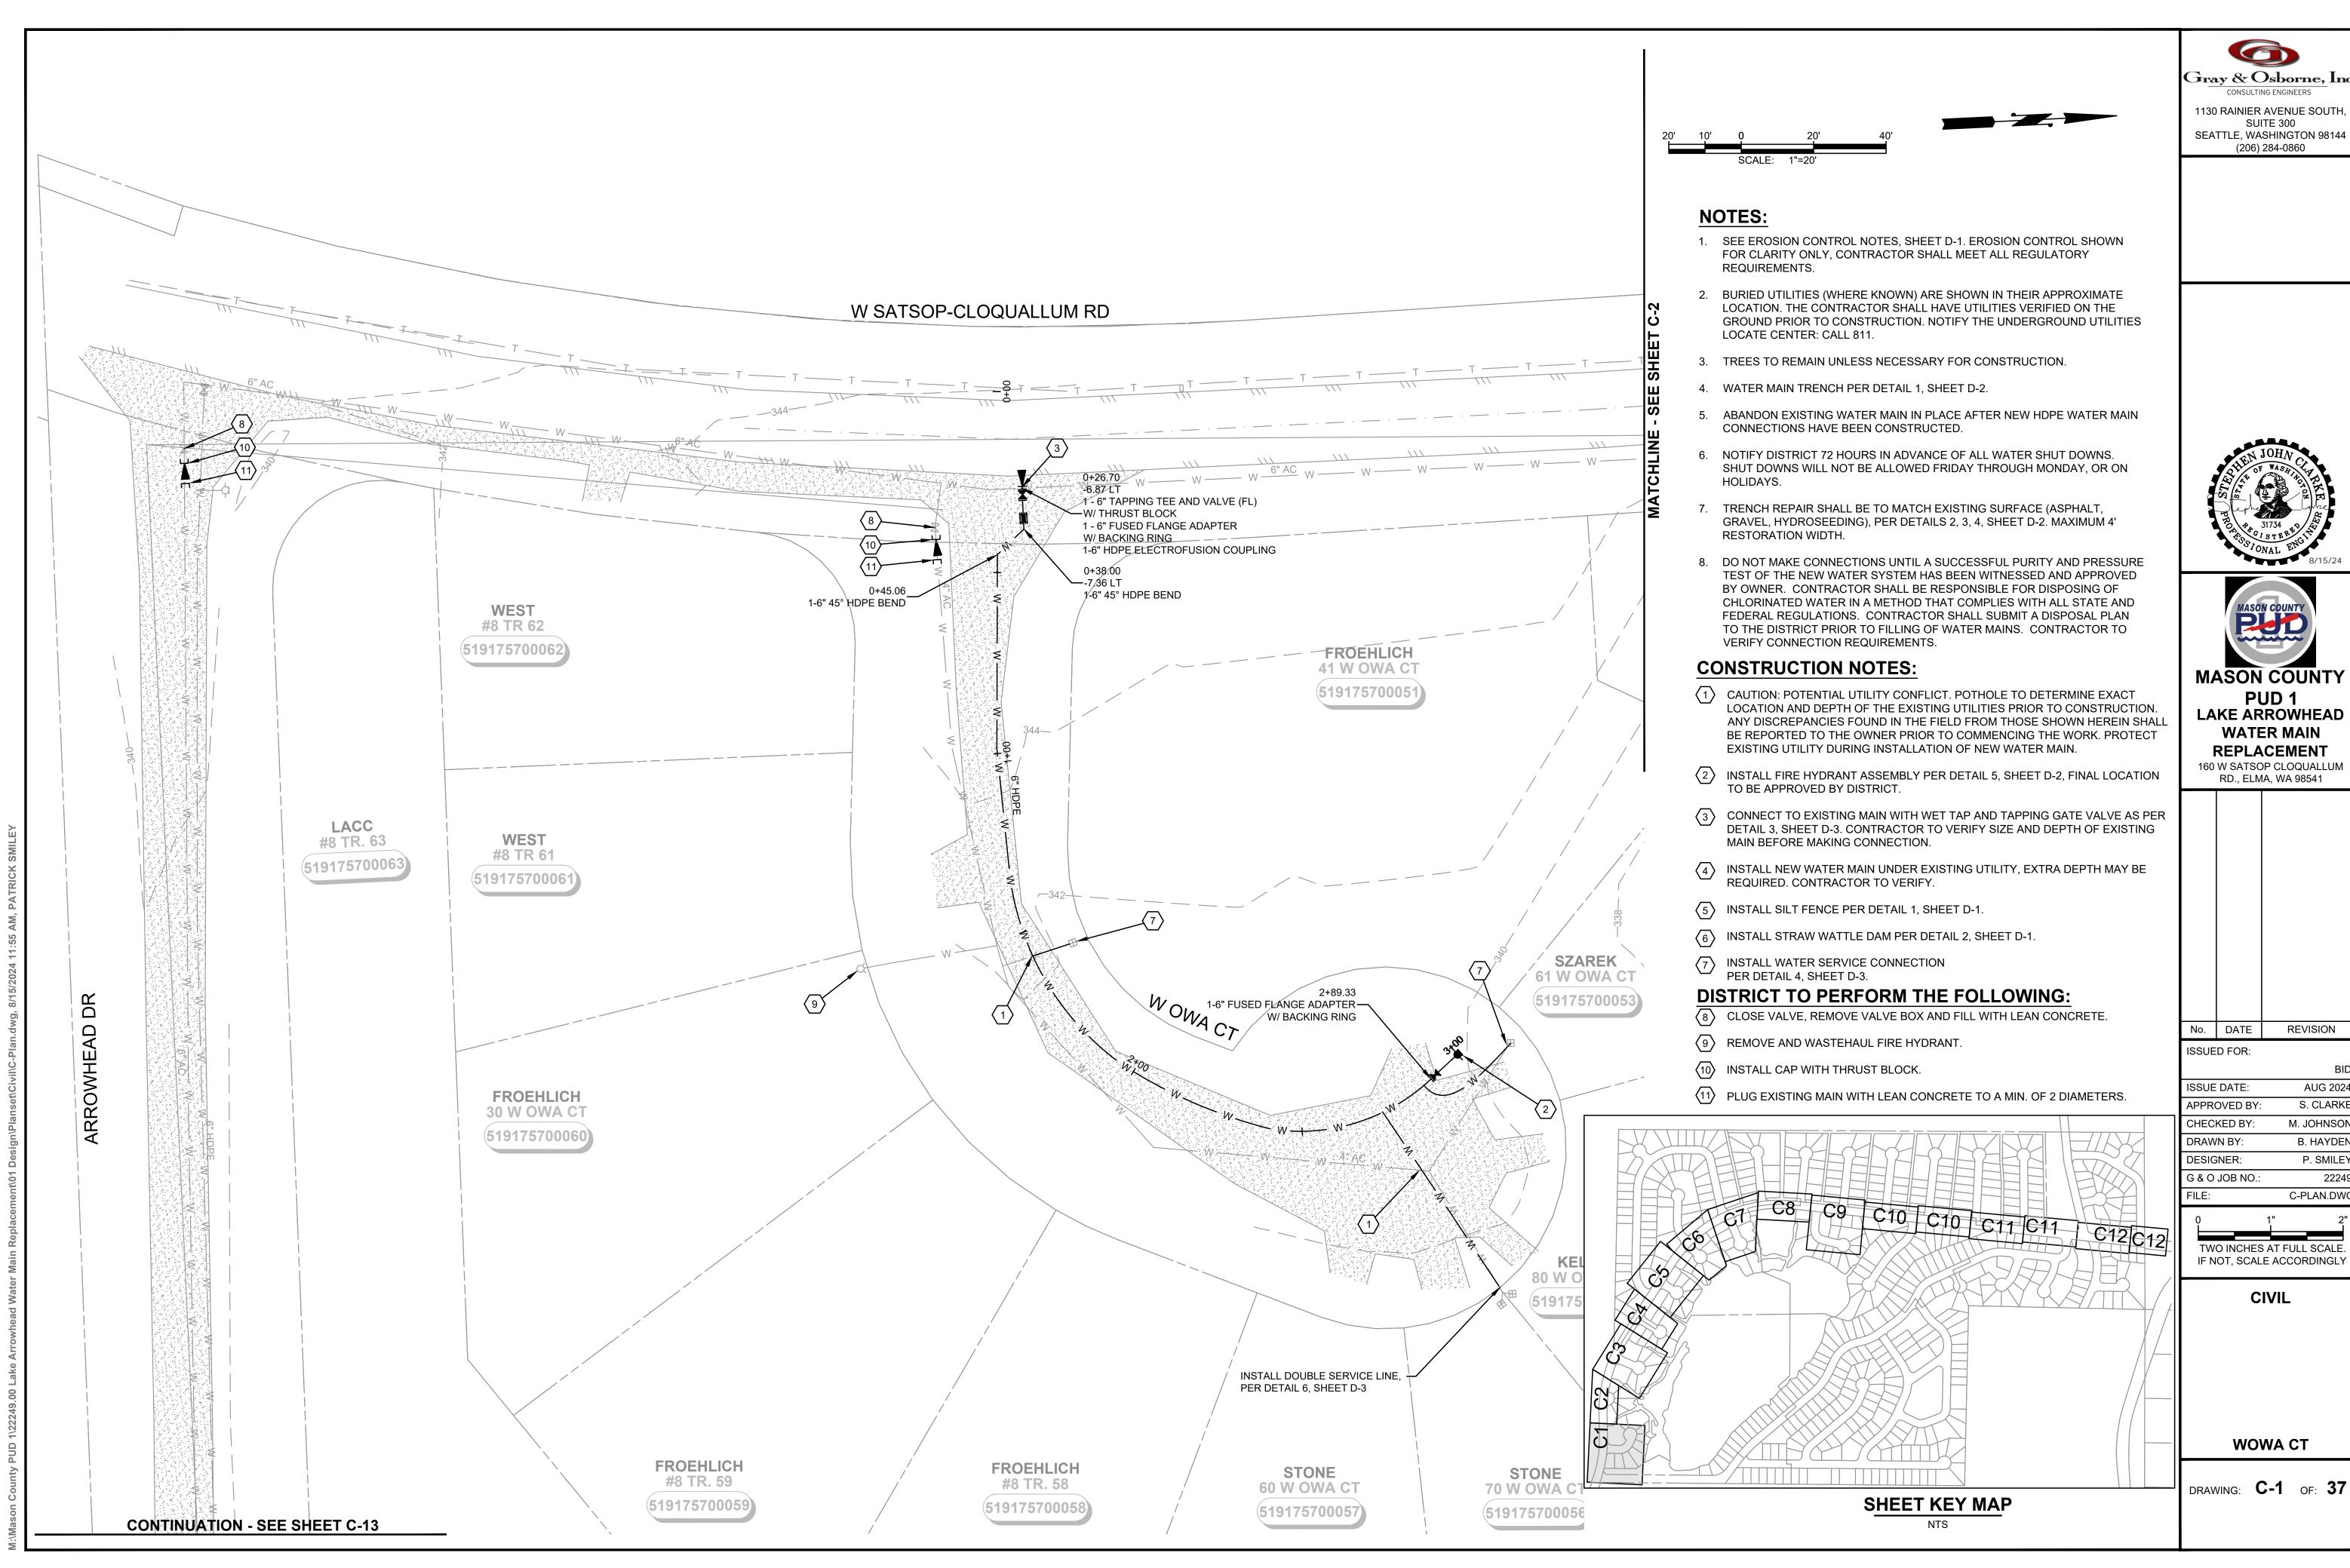


1130 RAINIER AVENUE SOUTH SEATTLE, WASHINGTON 98144

REVISION

AUG 2024 S. CLARKE M. JOHNSON B. HAYDEN

P. SMILEY C-PLAN.DWG

TWO INCHES AT FULL SCALE

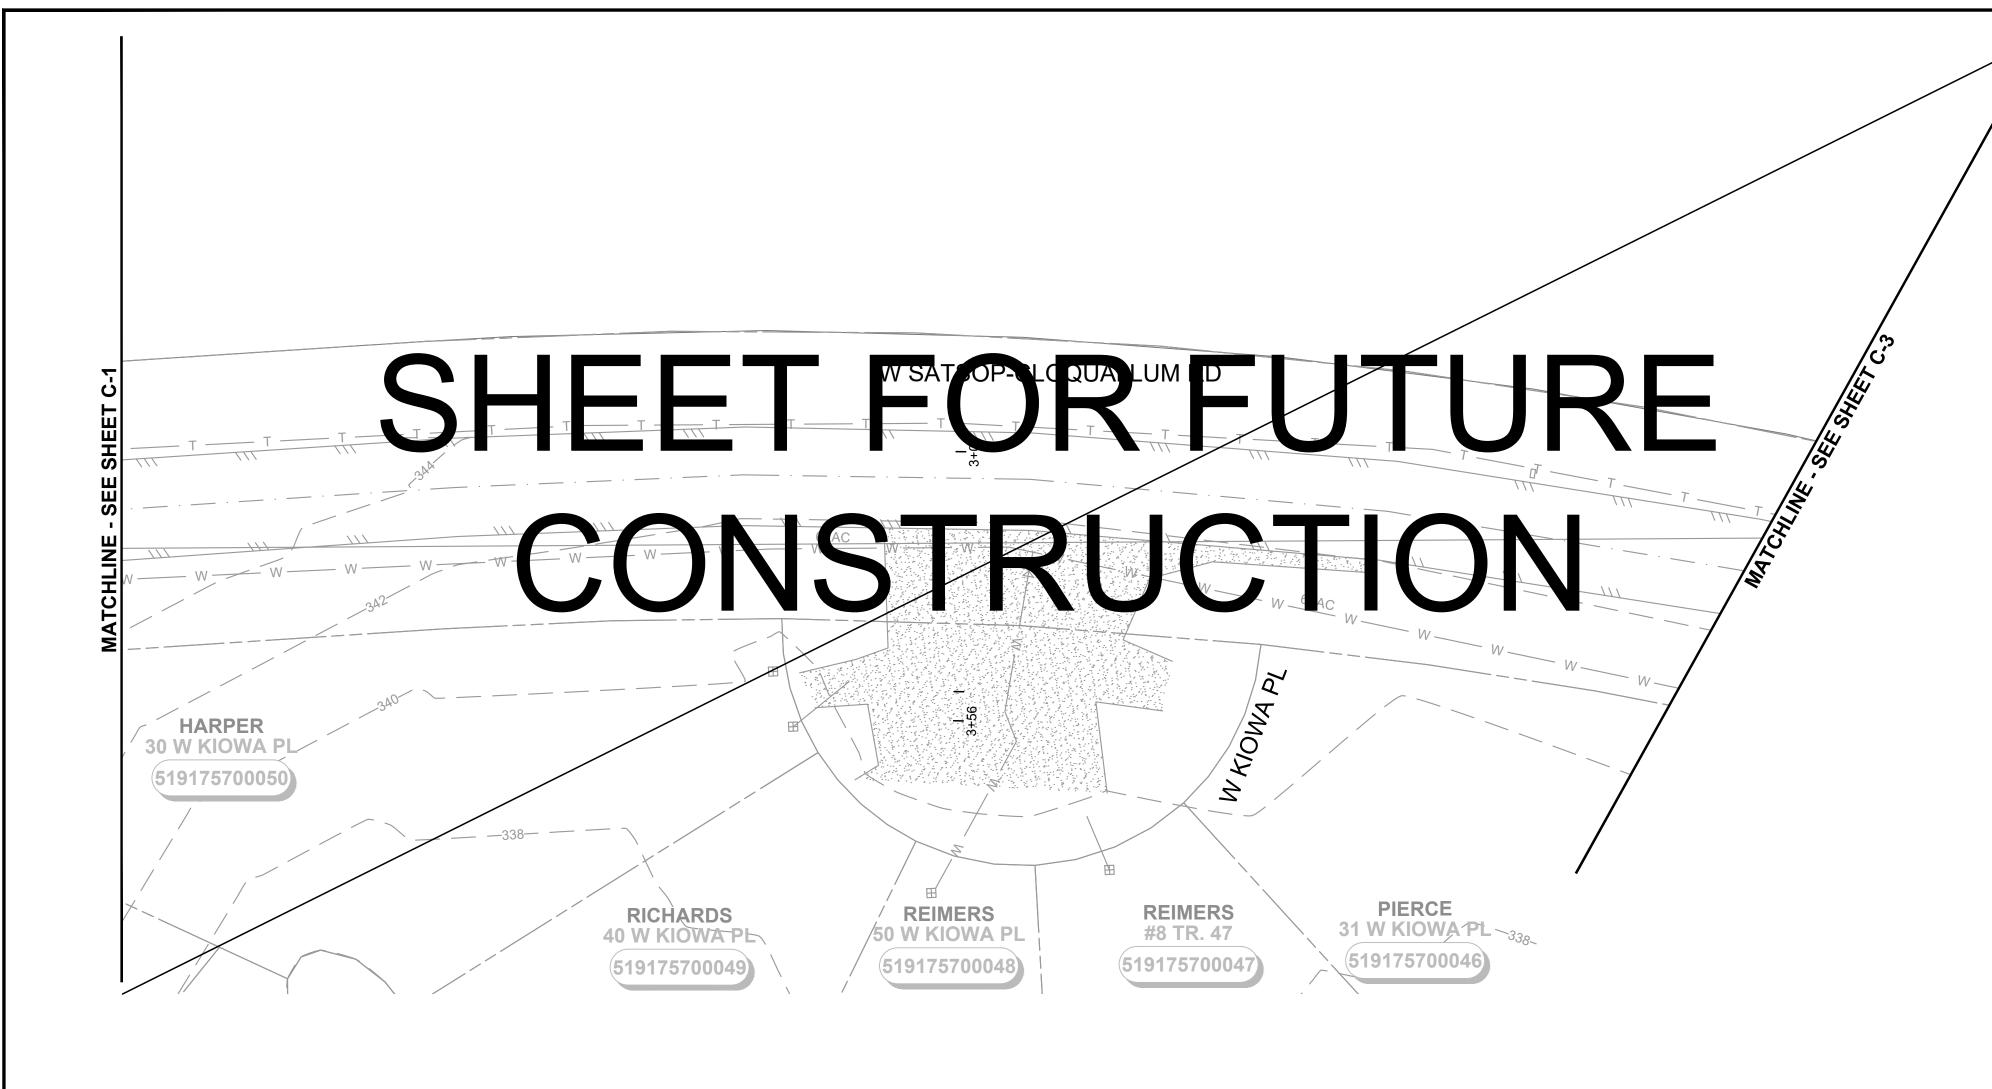



#### NOTES:


- 1. SEE EROSION CONTROL NOTES, SHEET D-1. EROSION CONTROL SHOWN FOR CLARITY ONLY, CONTRACTOR SHALL MEET ALL REGULATORY REQUIREMENTS.
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- 3. TREES TO REMAIN UNLESS NECESSARY FOR CONSTRUCTION
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- ABANDON EXISTING WATER MAIN IN PLACE AFTER NEW HDPE WATER MAIN CONNECTIONS HAVE BEEN CONSTRUCTED.
- 6. NOTIFY DISTRICT 72 HOURS IN ADVANCE OF ALL WATER SHUT DOWNS. SHUT DOWNS WILL NOT BE ALLOWED FRIDAY THROUGH MONDAY. OR ON HOLIDAYS.
- 7. TRENCH REPAIR SHALL BE TO MATCH EXISTING SURFACE (ASPHALT, GRAVEL, HYDROSEEDING), PER DETAILS 2, 3, 4, SHEET D-2. MAXIMUM 4' RESTORATION WIDTH.
- 8. DO NOT MAKE CONNECTIONS UNTIL A SUCCESSFUL PURITY AND PRESSURE TEST OF THE NEW WATER SYSTEM HAS BEEN WITNESSED AND APPROVED BY OWNER. CONTRACTOR SHALL BE RESPONSIBLE FOR DISPOSING OF CHLORINATED WATER IN A METHOD THAT COMPLIES WITH ALL STATE AND FEDERAL REGULATIONS. CONTRACTOR SHALL SUBMIT A DISPOSAL PLAN TO THE DISTRICT PRIOR TO FILLING OF WATER MAINS. CONTRACTOR TO VERIFY CONNECTION REQUIREMENTS.

#### **CONSTRUCTION NOTES:**

- (1) CAUTION: POTENTIAL UTILITY CONFLICT. POTHOLE TO DETERMINE EXACT LOCATION AND DEPTH OF THE EXISTING UTILITIES PRIOR TO CONSTRUCTION. ANY DISCREPANCIES FOUND IN THE FIELD FROM THOSE SHOWN HEREIN SHALL BE REPORTED TO THE OWNER PRIOR TO COMMENCING THE WORK. PROTECT EXISTING UTILITY DURING INSTALLATION OF NEW WATER MAIN.
- 2 INSTALL FIRE HYDRANT ASSEMBLY PER DETAIL 5, SHEET D-2, FINAL LOCATION TO BE APPROVED BY DISTRICT.
- (3) CONNECT TO EXISTING MAIN WITH WET TAP AND TAPPING GATE VALVE AS PER DETAIL 3, SHEET D-3. CONTRACTOR TO VERIFY SIZE AND DEPTH OF EXISTING MAIN BEFORE MAKING CONNECTION.
- $\overline{\langle 4 \rangle}$  INSTALL NEW WATER MAIN UNDER EXISTING UTILITY, EXTRA DEPTH MAY BE REQUIRED. CONTRACTOR TO VERIFY.
- (5) INSTALL SILT FENCE PER DETAIL 1, SHEET D-1.
- (6) INSTALL STRAW WATTLE DAM PER DETAIL 2, SHEET D-1.
- 7 INSTALL WATER SERVICE CONNECTION PER DETAIL 4, SHEET D-3.

#### DISTRICT TO PERFORM THE FOLLOWING:


- (8) CLOSE VALVE, REMOVE VALVE BOX AND FILL WITH LEAN CONCRETE.
- (9) REMOVE AND WASTEHAUL FIRE HYDRANT.
- (10) INSTALL CAP WITH THRUST BLOCK.
- PLUG EXISTING MAIN WITH LEAN CONCRETE TO A MIN. OF 2 DIAMETERS.

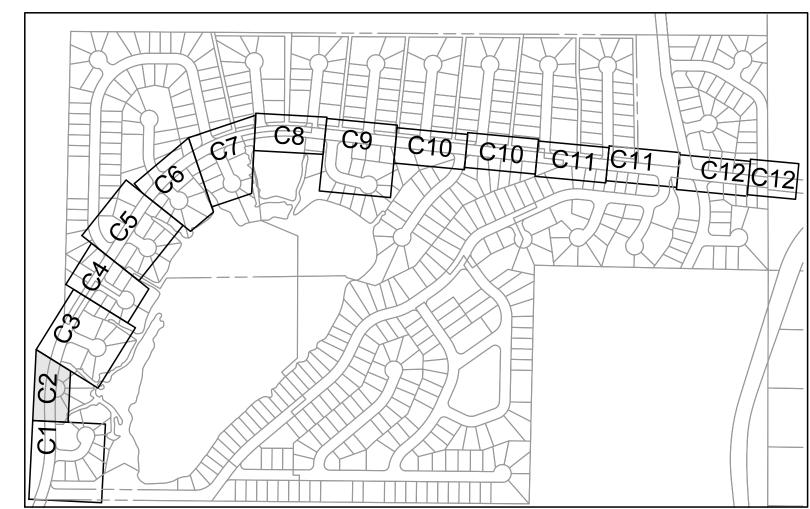

**SHEET KEY MAP** 



1130 RAINIER AVENUE SOUTH SUITE 300 SEATTLE, WASHINGTON 98144 (206) 284-0860

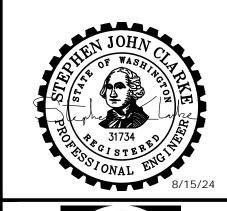



RD., ELMA, WA 98541

No. DATE REVISION

ISSUED FOR:

ISSUE DATE: AUG 2024 APPROVED BY: S. CLARKE M. JOHNSON CHECKED BY: **DRAWN BY** B. HAYDEN P. SMILEY DESIGNER:

G & O JOB NO.:

TWO INCHES AT FULL SCALE


C-PLAN.DWG


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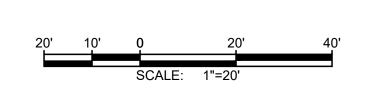
CIVIL


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DRAWING: C-2 OF: 37





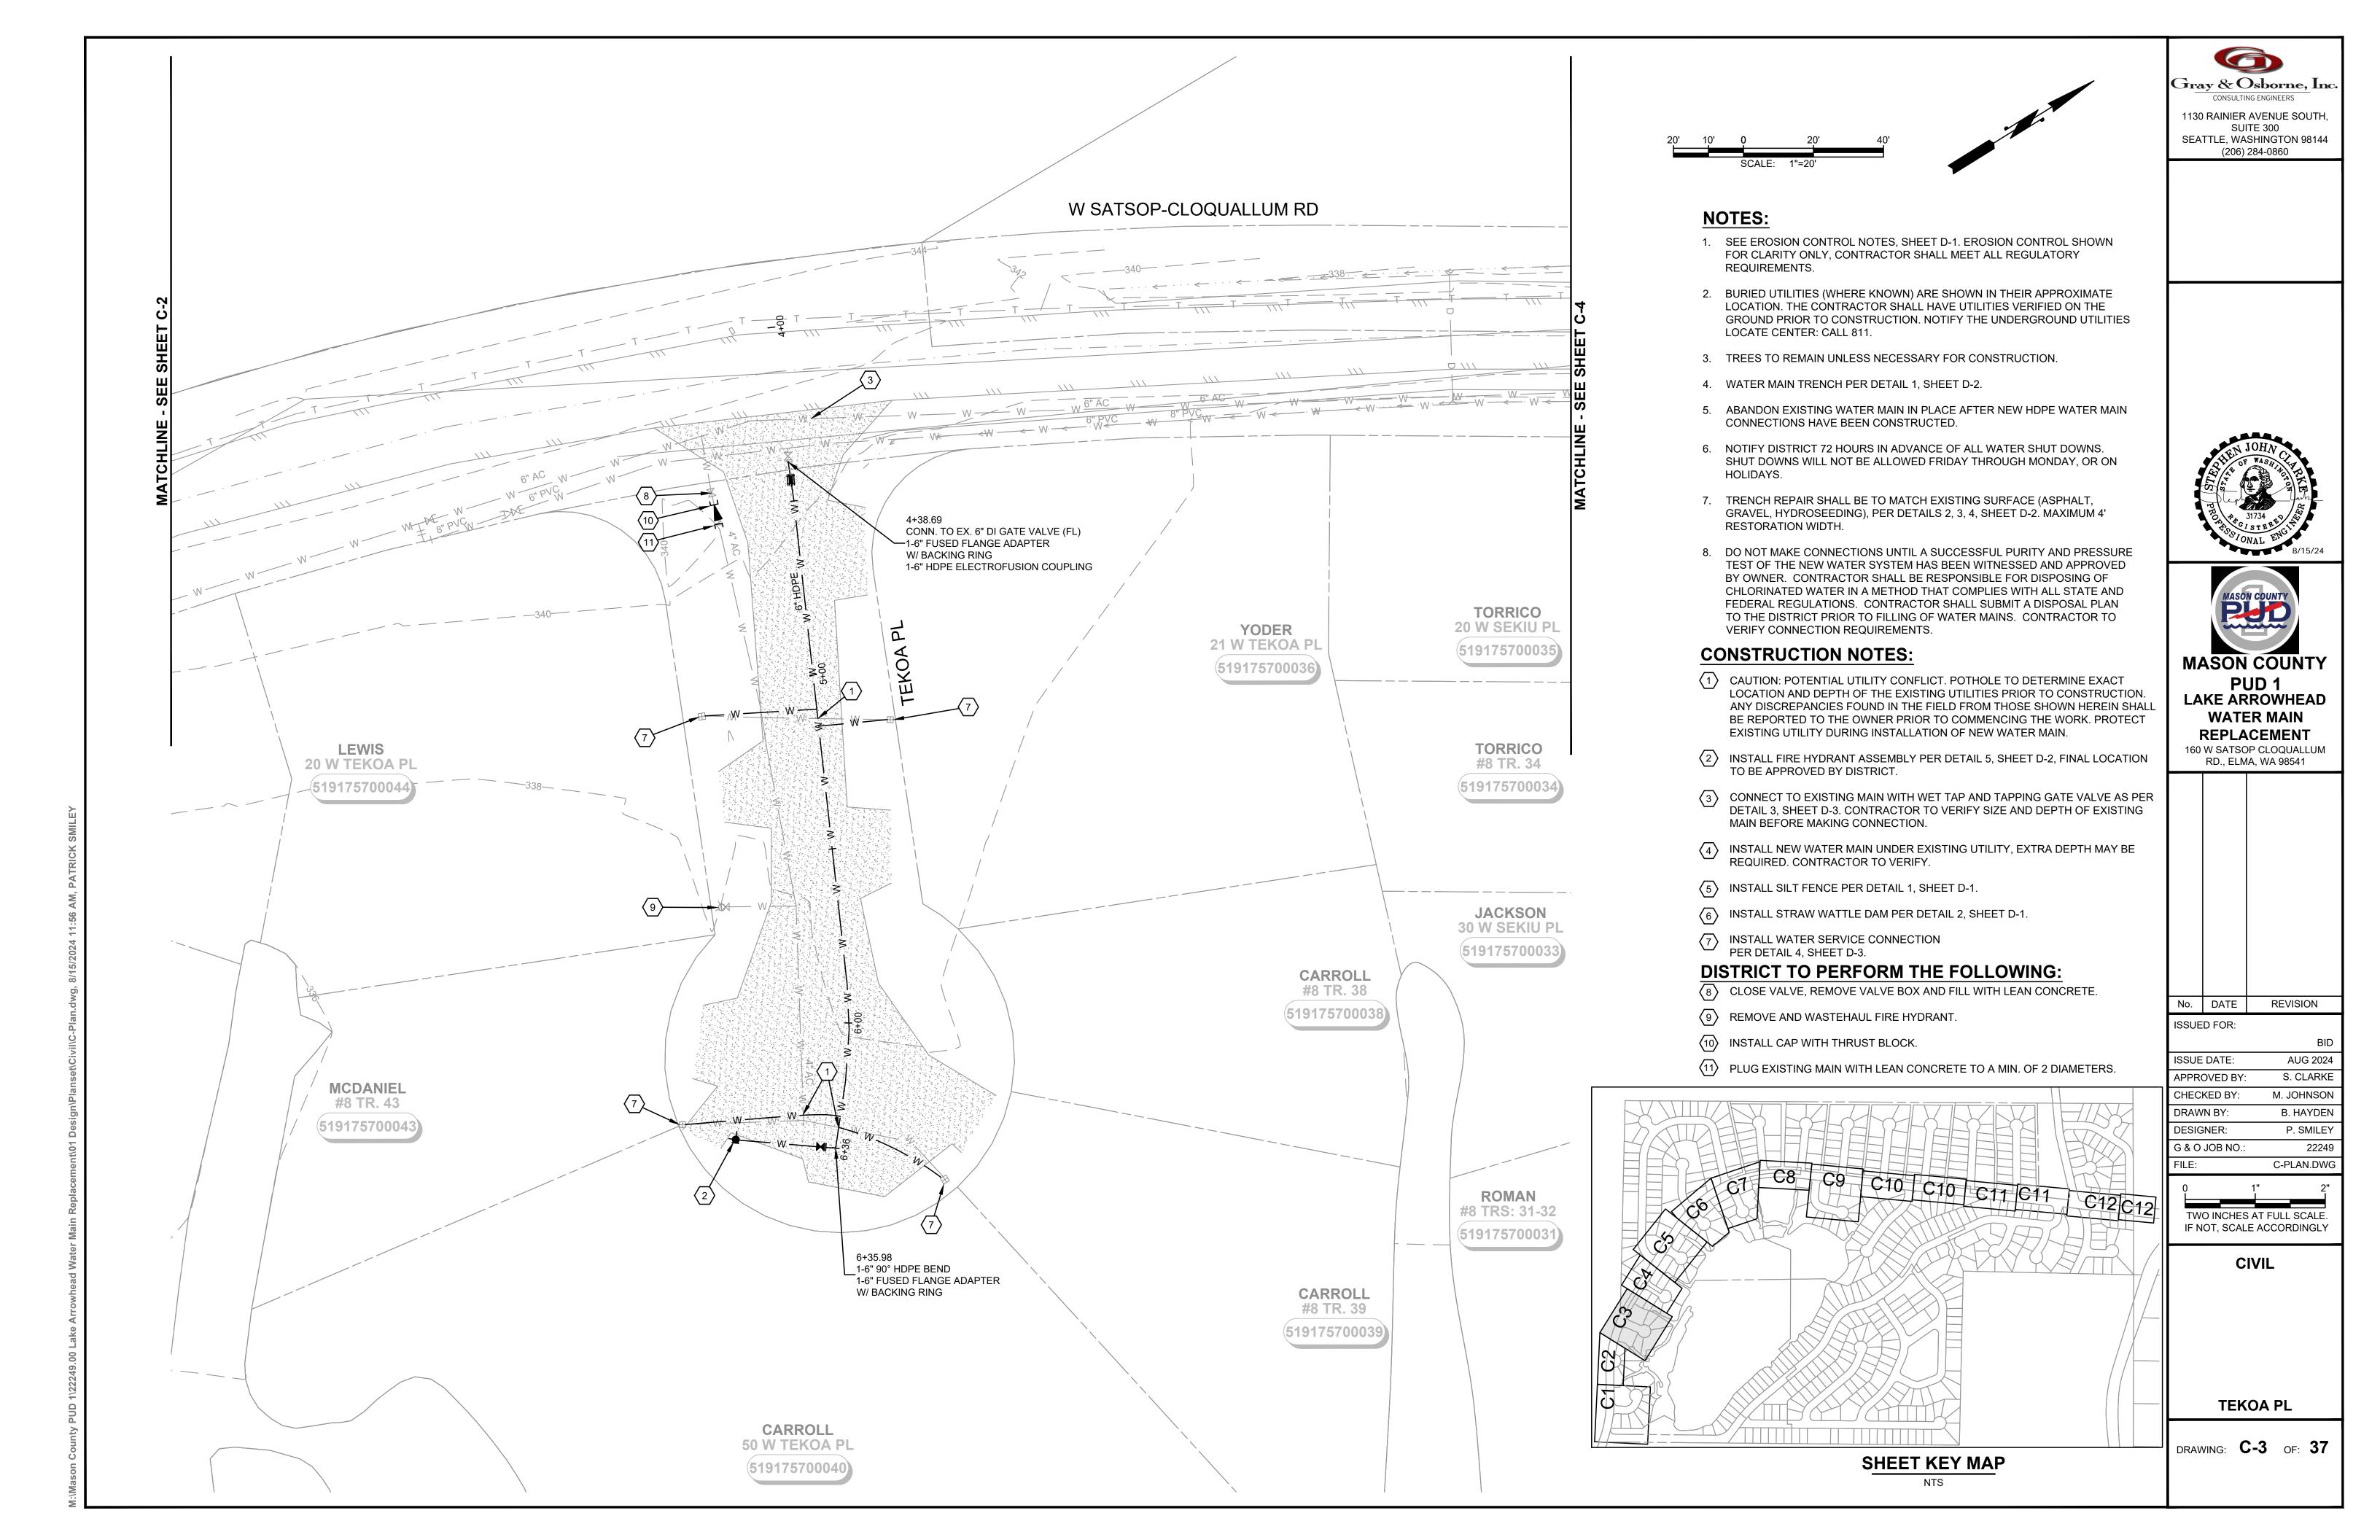

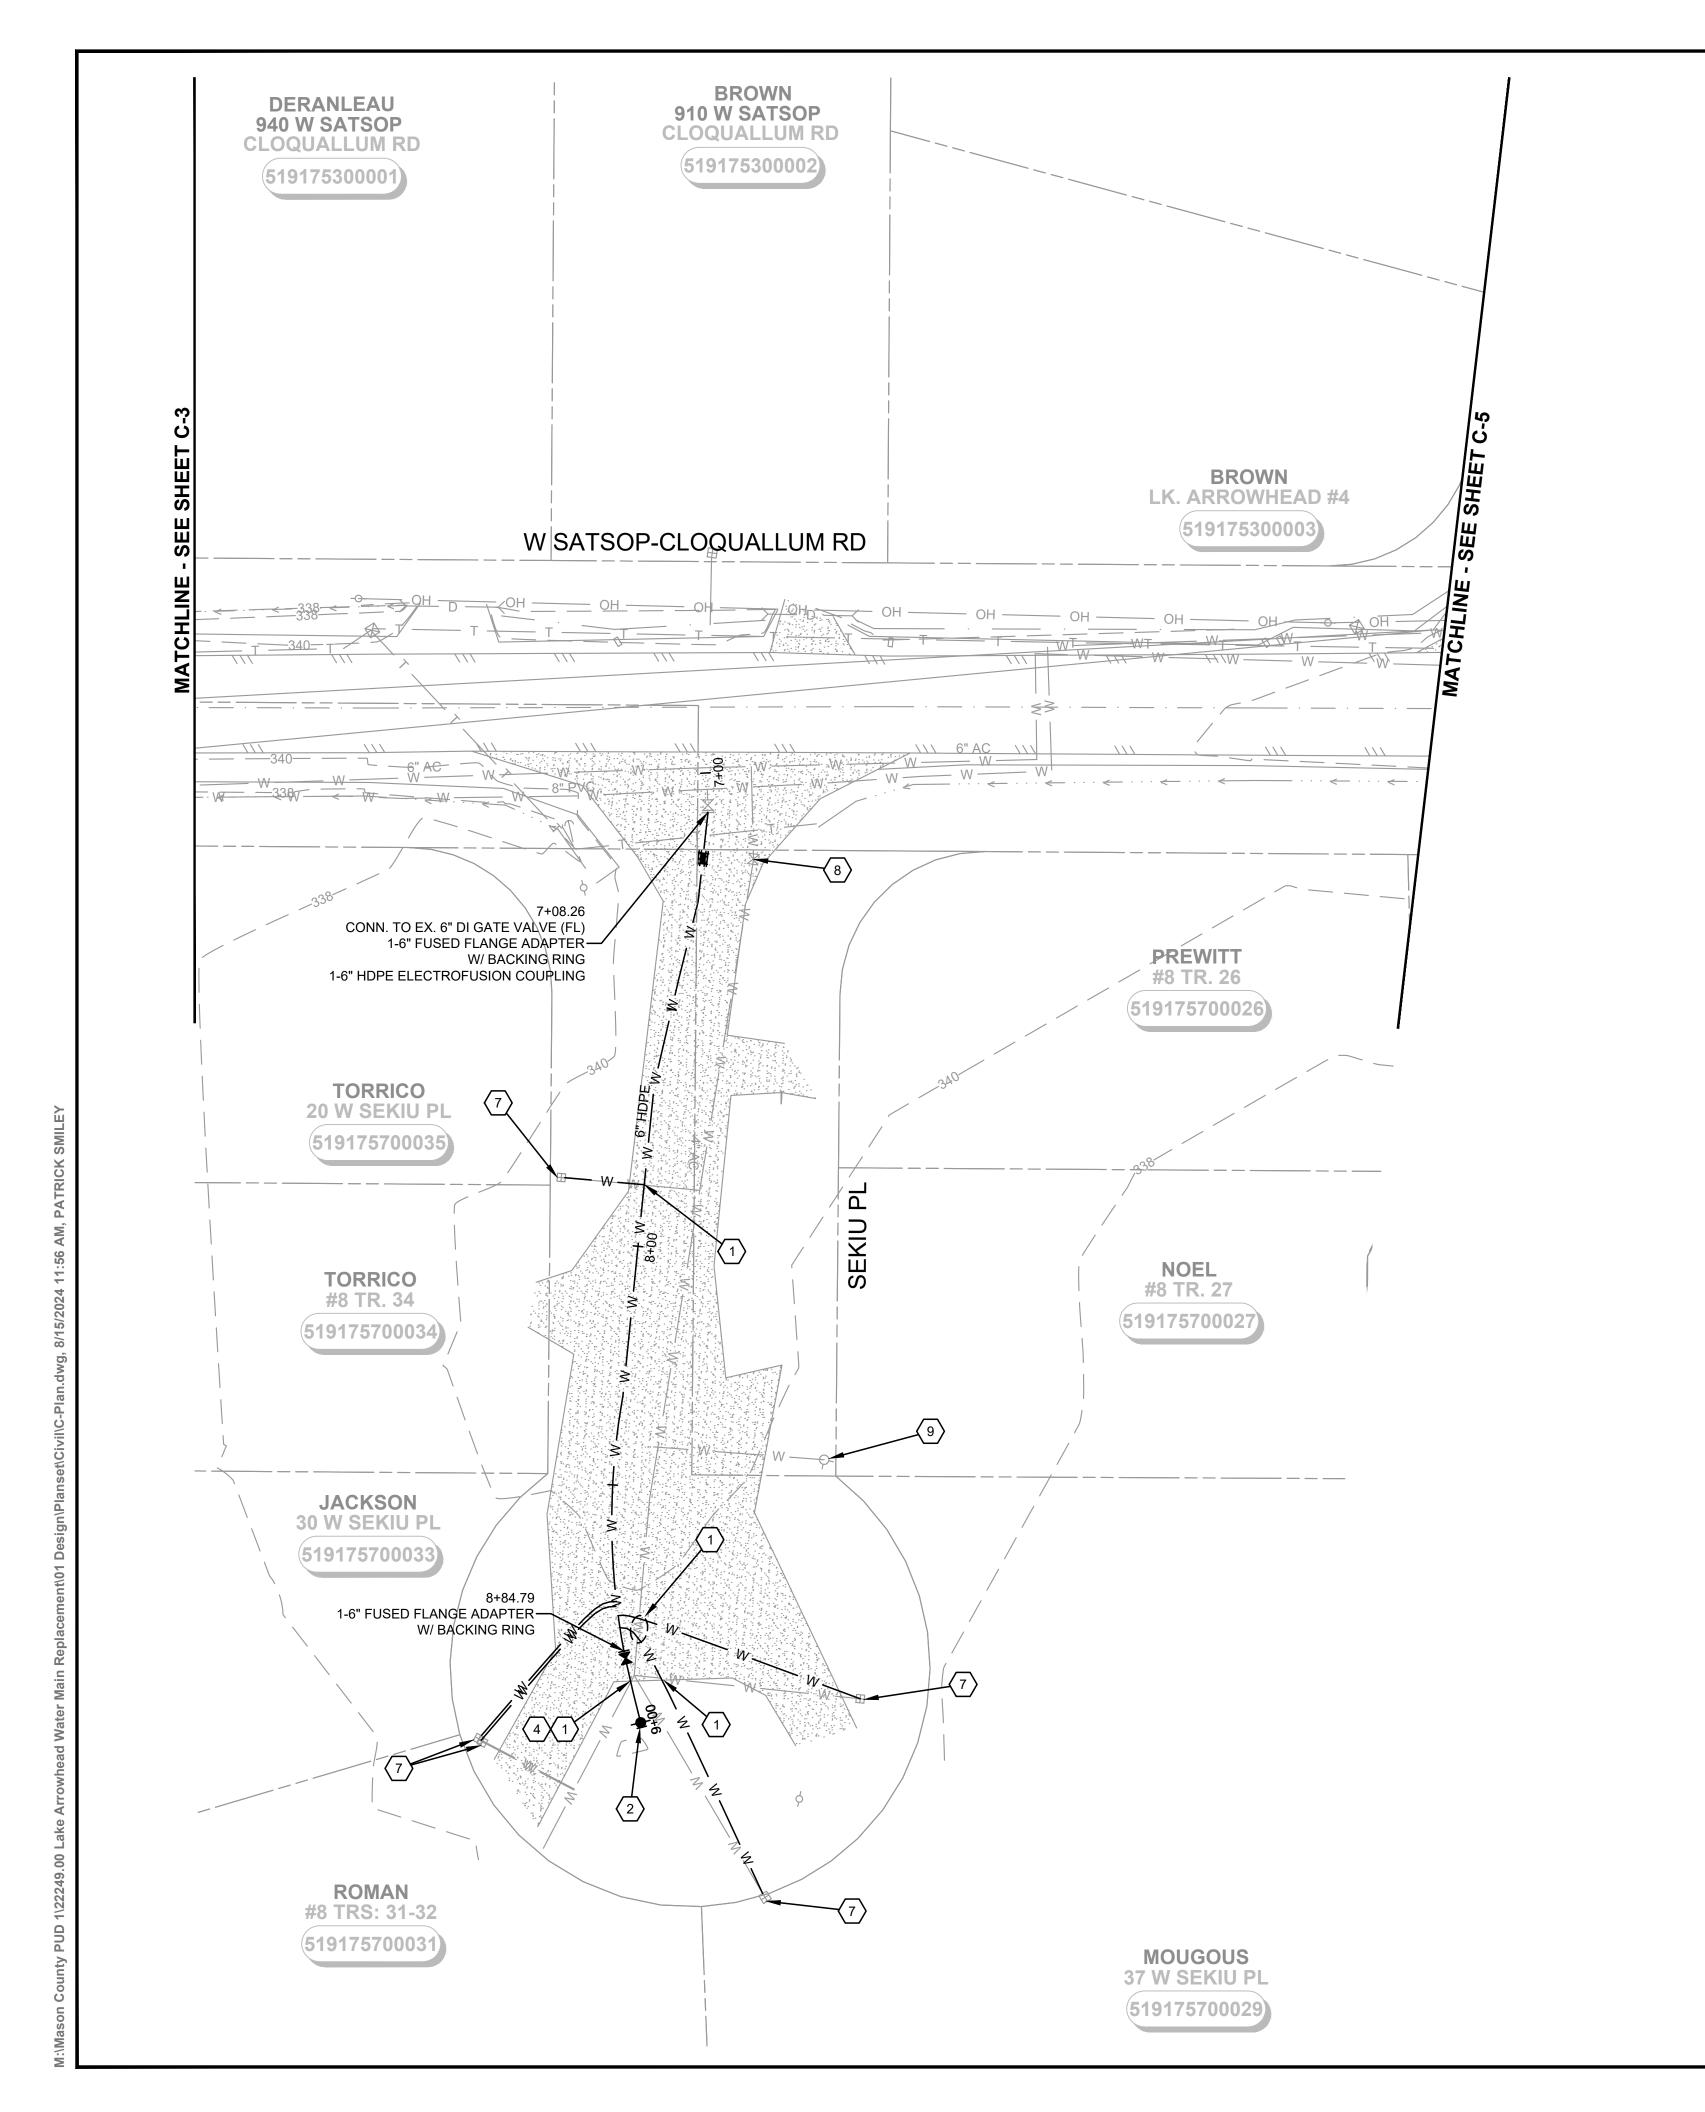

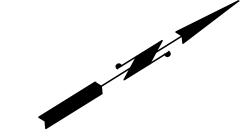Gray & Osborne, Inc.

CONSULTING ENGINEERS

1130 RAINIER AVENUE SOUTH, SUITE 300 SEATTLE, WASHINGTON 98144 (206) 284-0860

#### NOTES:

- SEE EROSION CONTROL NOTES, SHEET D-1. EROSION CONTROL SHOWN FOR CLARITY ONLY, CONTRACTOR SHALL MEET ALL REGULATORY REQUIREMENTS.
- 2. BURIED UTILITIES (WHERE KNOWN) ARE SHOWN IN THEIR APPROXIMATE LOCATION. THE CONTRACTOR SHALL HAVE UTILITIES VERIFIED ON THE GROUND PRIOR TO CONSTRUCTION. NOTIFY THE UNDERGROUND UTILITIES LOCATE CENTER: CALL 811.
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- 6. NOTIFY DISTRICT 72 HOURS IN ADVANCE OF ALL WATER SHUT DOWNS. SHUT DOWNS WILL NOT BE ALLOWED FRIDAY THROUGH MONDAY, OR ON HOLIDAYS.
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- CONNECT TO EXISTING MAIN WITH WET TAP AND TAPPING GATE VALVE AS PER DETAIL 3, SHEET D-3. CONTRACTOR TO VERIFY SIZE AND DEPTH OF EXISTING MAIN BEFORE MAKING CONNECTION.
- INSTALL NEW WATER MAIN UNDER EXISTING UTILITY, EXTRA DEPTH MAY BE REQUIRED. CONTRACTOR TO VERIFY.
- (5) INSTALL SILT FENCE PER DETAIL 1, SHEET D-1.
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- 7 INSTALL WATER SERVICE CONNECTION PER DETAIL 4, SHEET D-3.


### **DISTRICT TO PERFORM THE FOLLOWING:**

- 8 CLOSE VALVE, REMOVE VALVE BOX AND FILL WITH LEAN CONCRETE.
- 9 REMOVE AND WASTEHAUL FIRE HYDRANT.
- (10) INSTALL CAP WITH THRUST BLOCK.
- PLUG EXISTING MAIN WITH LEAN CONCRETE TO A MIN. OF 2 DIAMETERS.



SHEET KEY MAP

NTS

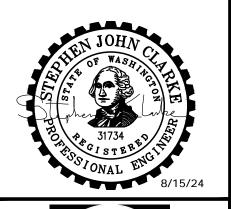



RD., ELMA, WA 98541

JO DATE REVISION

No. DATE REVISION
ISSUED FOR:

APPROVED BY: S. CLARKE
CHECKED BY: M. JOHNSON
DRAWN BY: B. HAYDEN
DESIGNER: P. SMILEY


D 1" 2"

TWO INCHES AT FULL SCALE.
IF NOT, SCALE ACCORDINGLY

CIVIL


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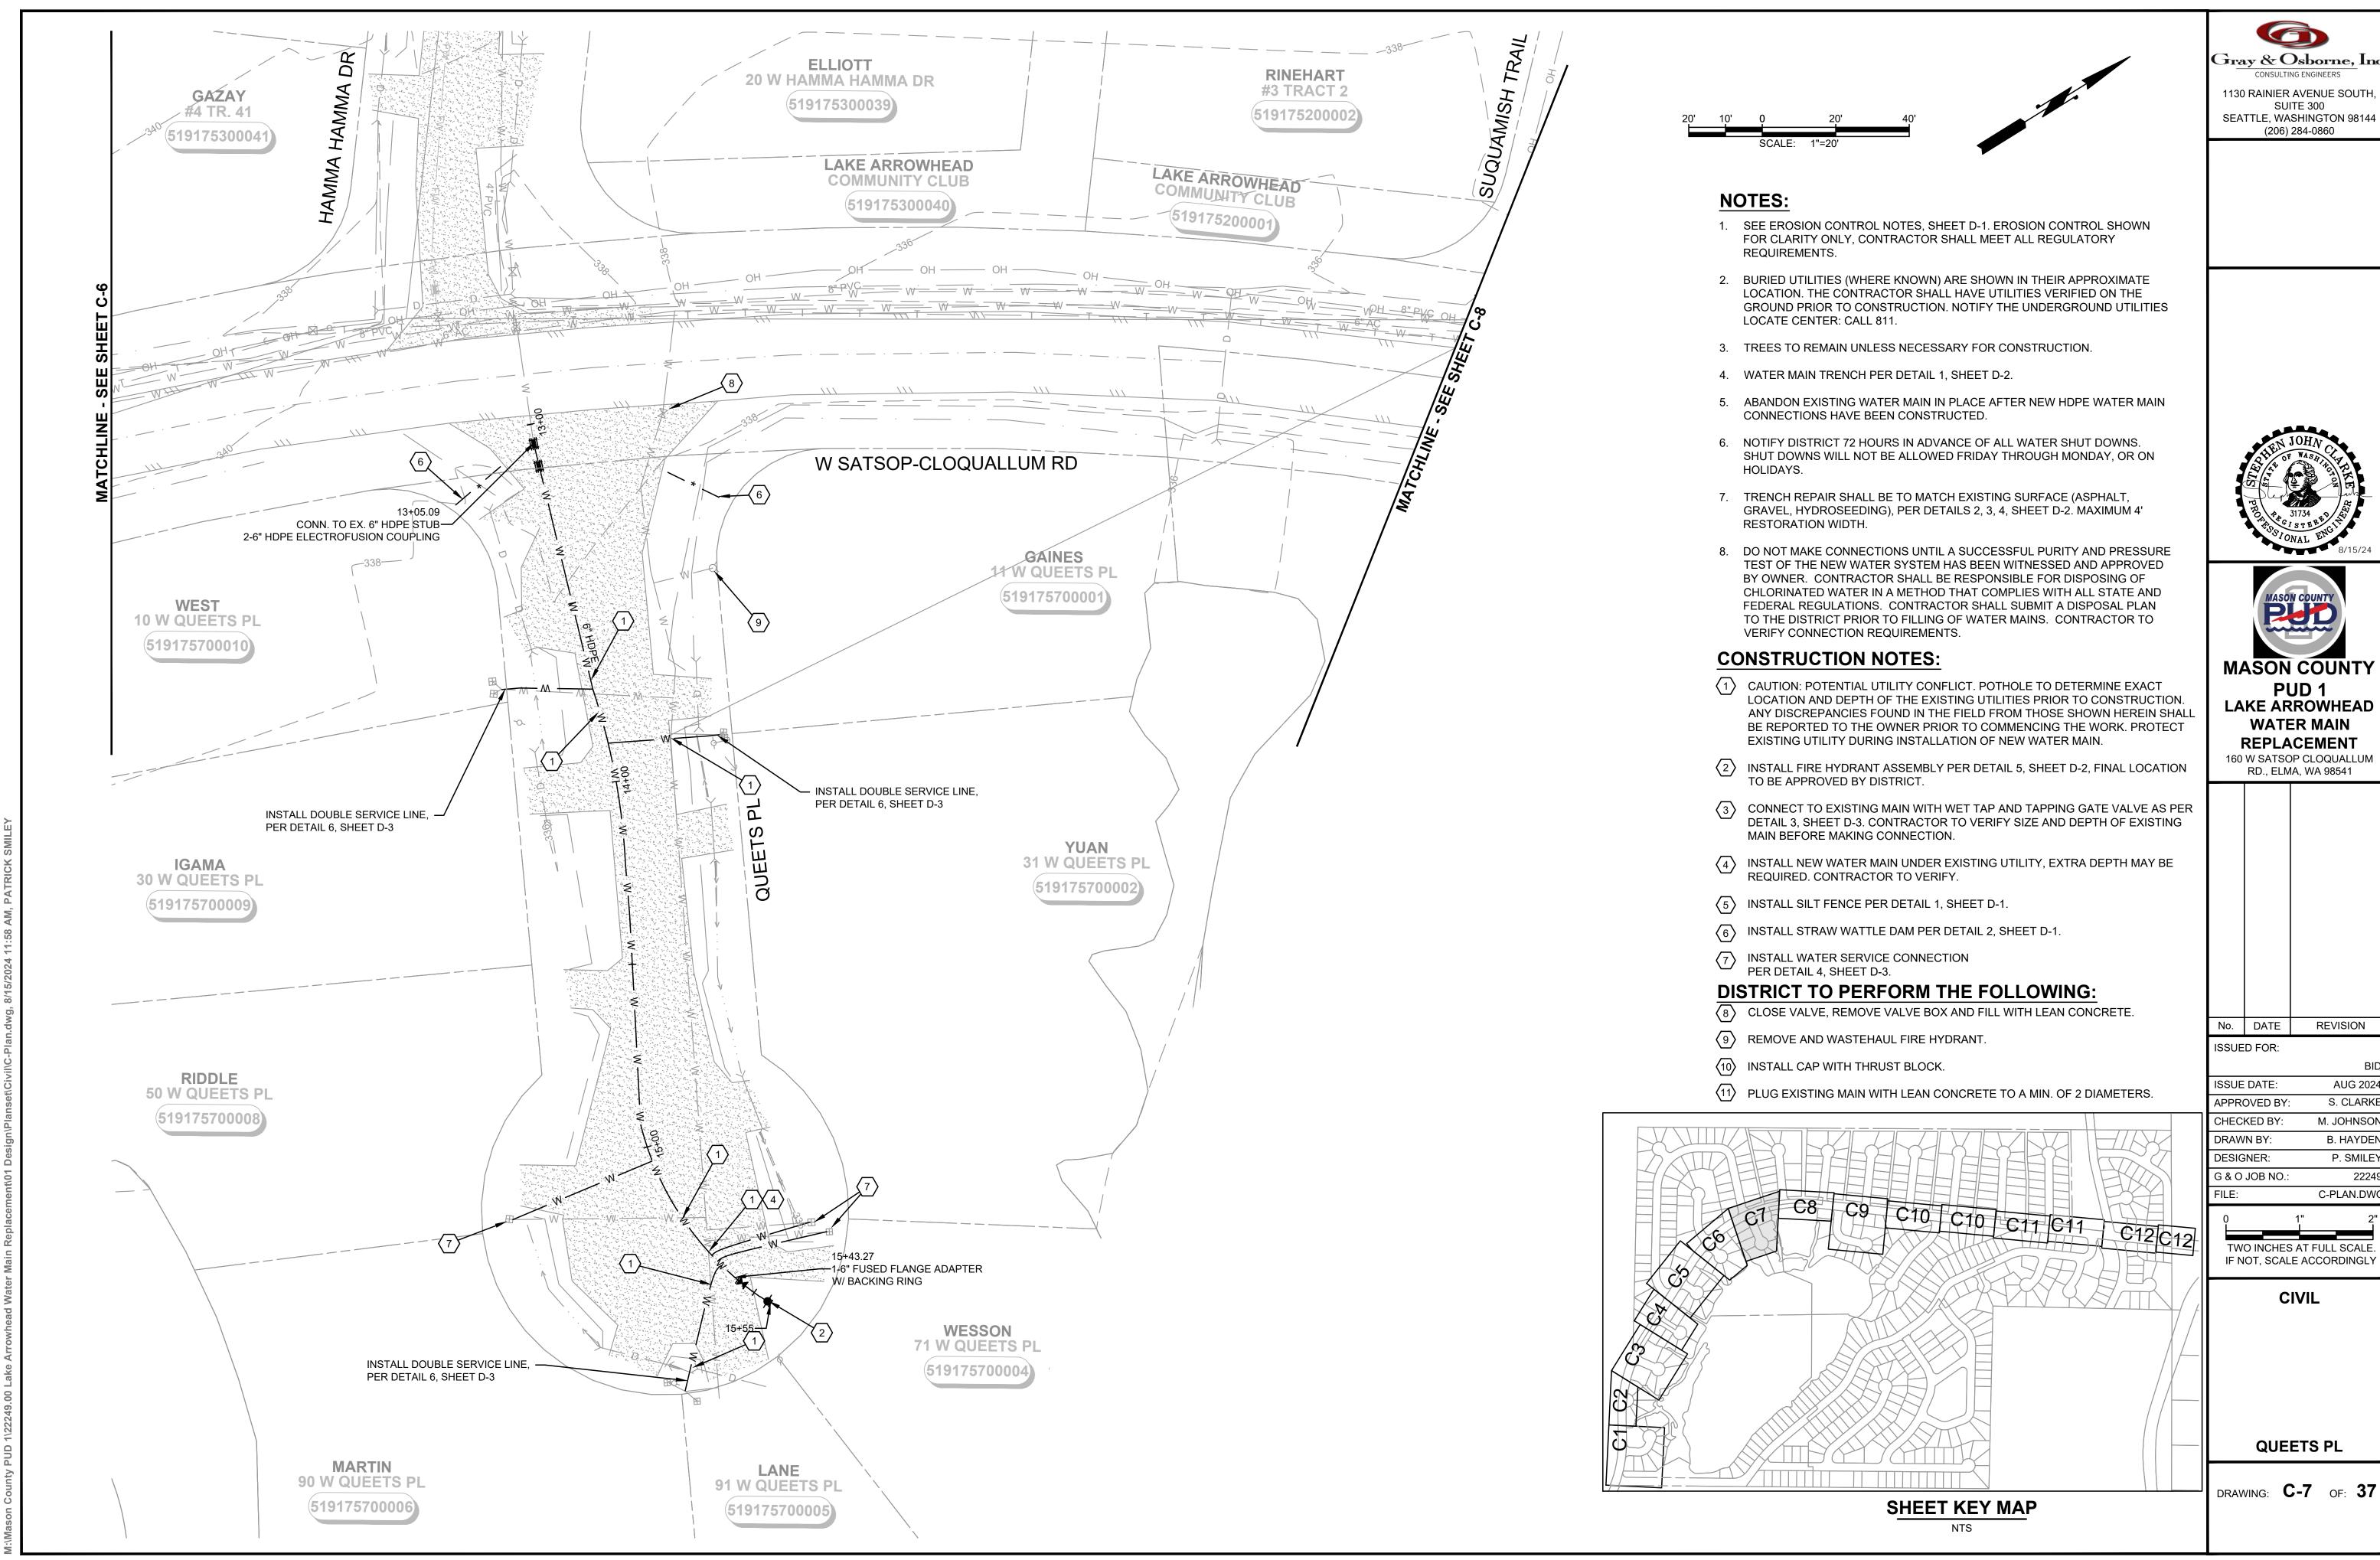
DRAWING: C-4 OF: 37

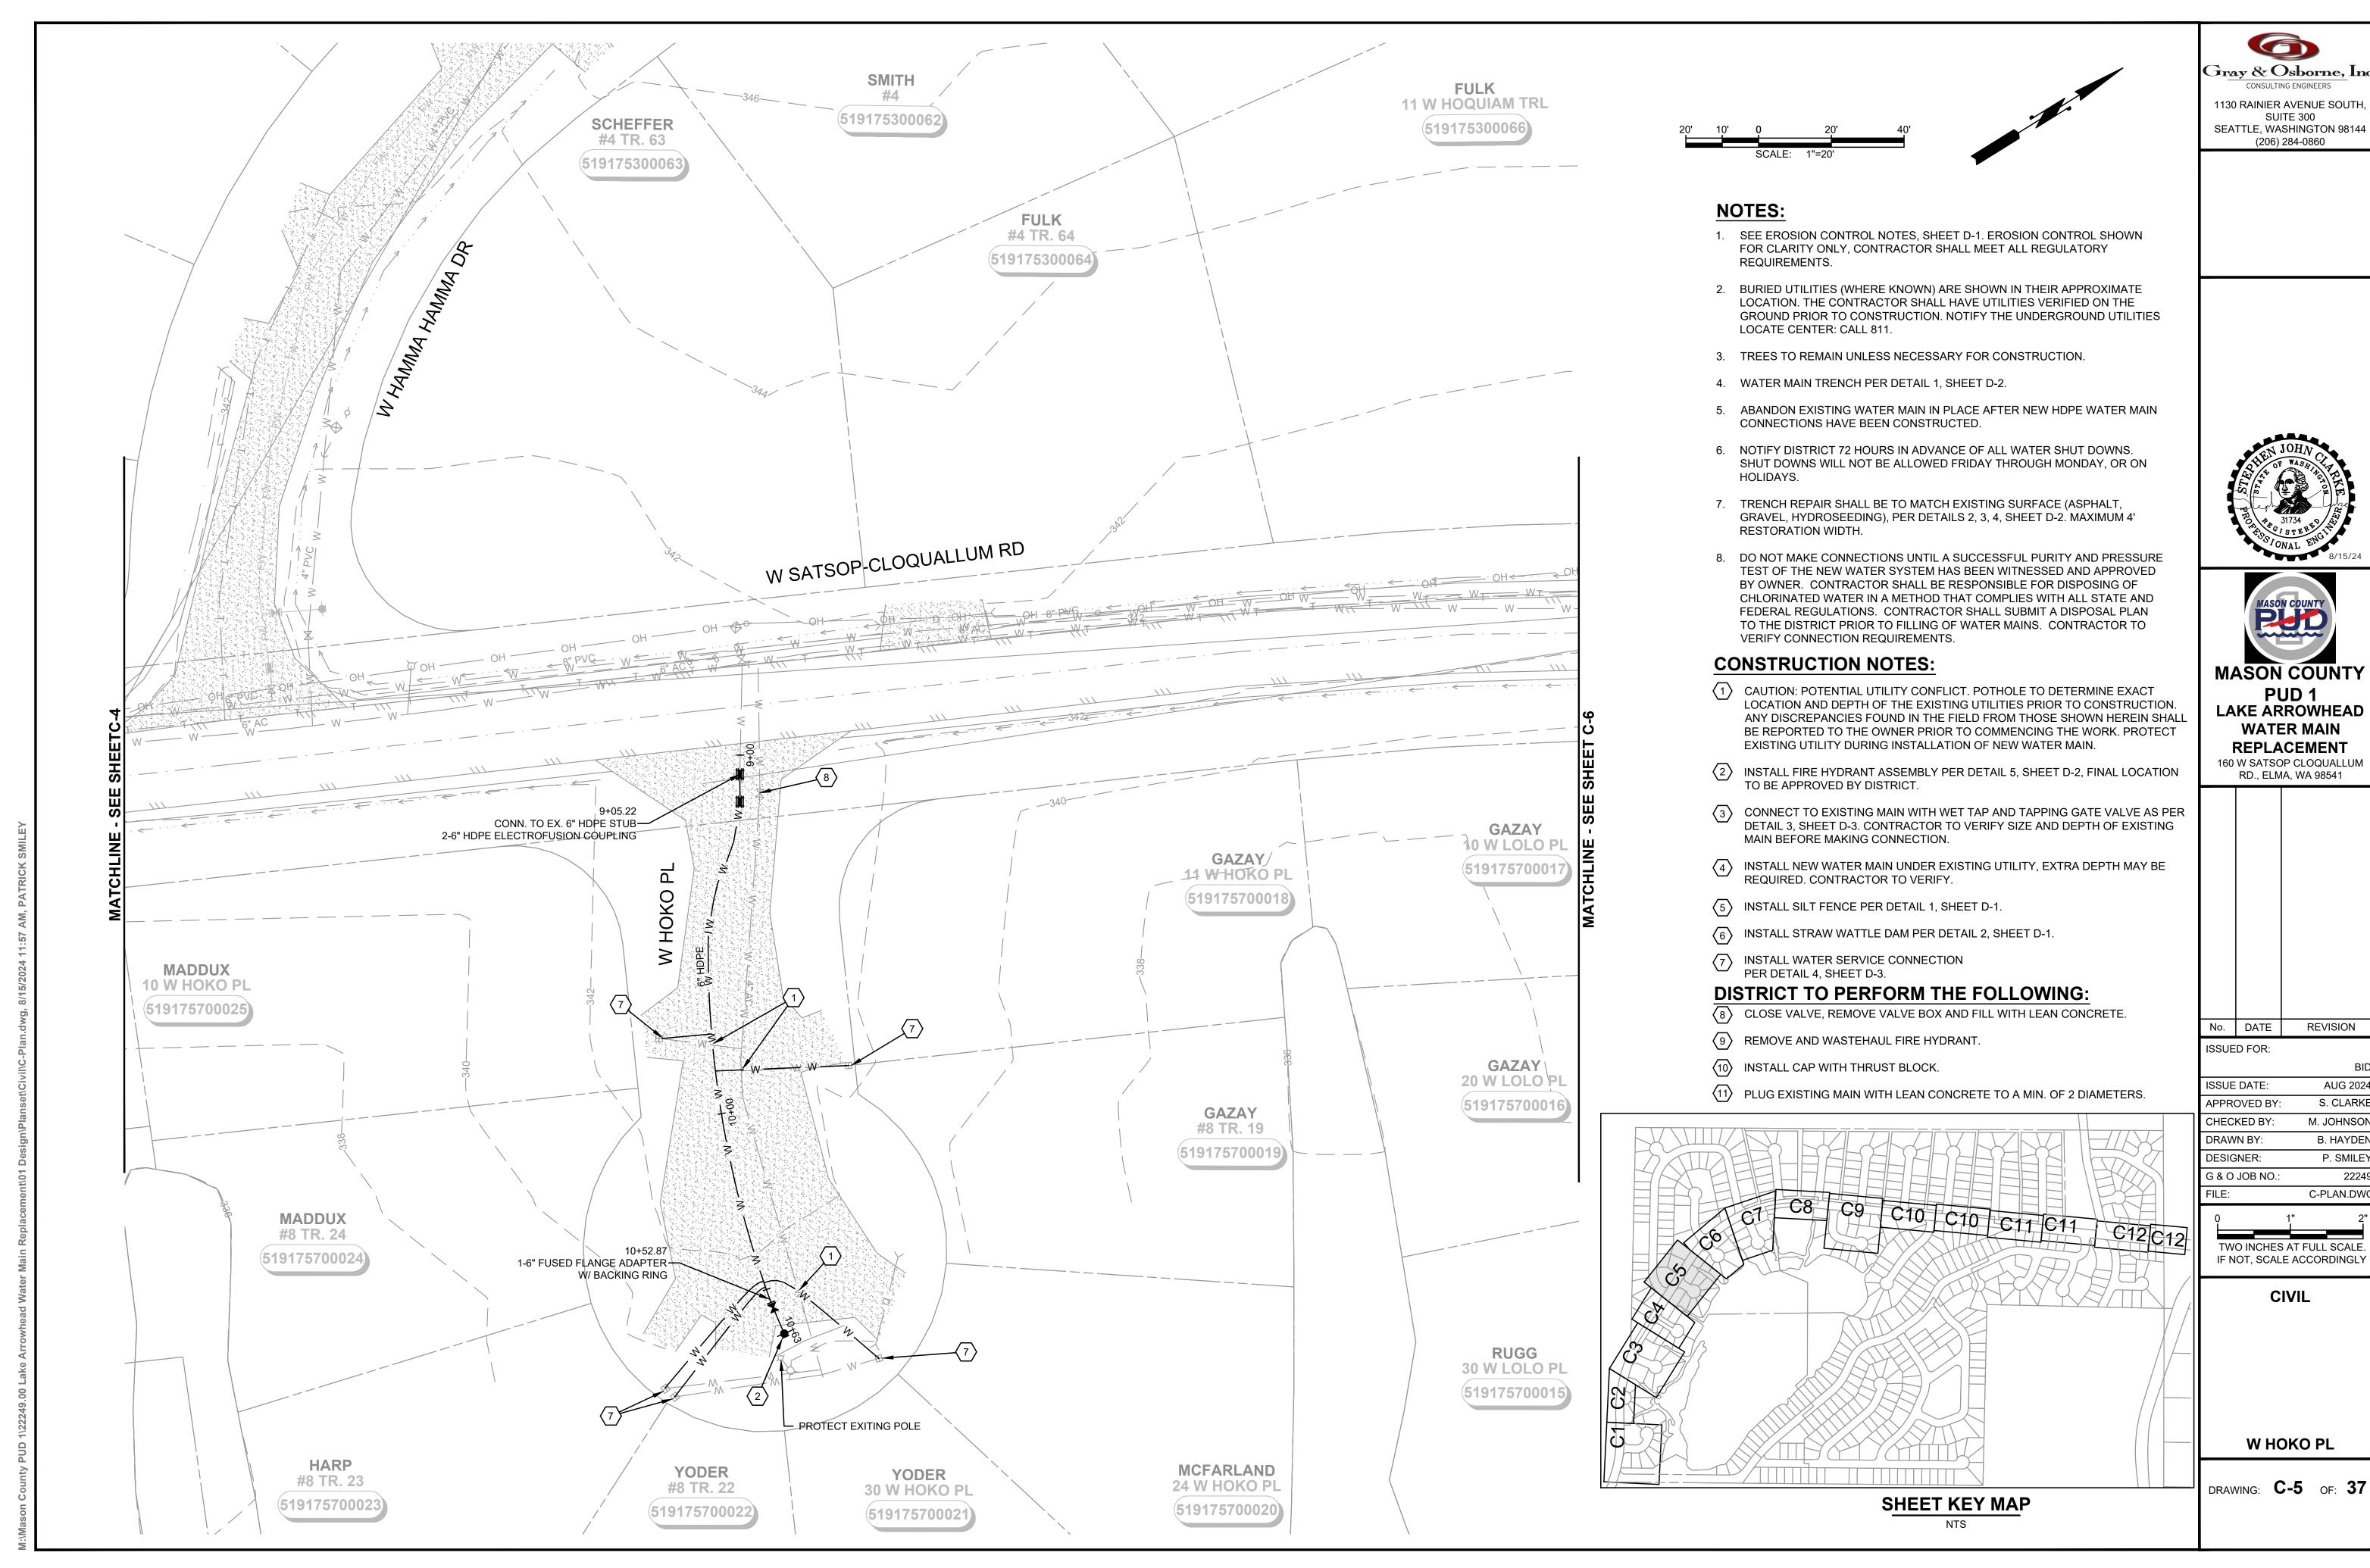

AUG 2024 S. CLARKE M. JOHNSON B. HAYDEN

P. SMILEY C-PLAN.DWG



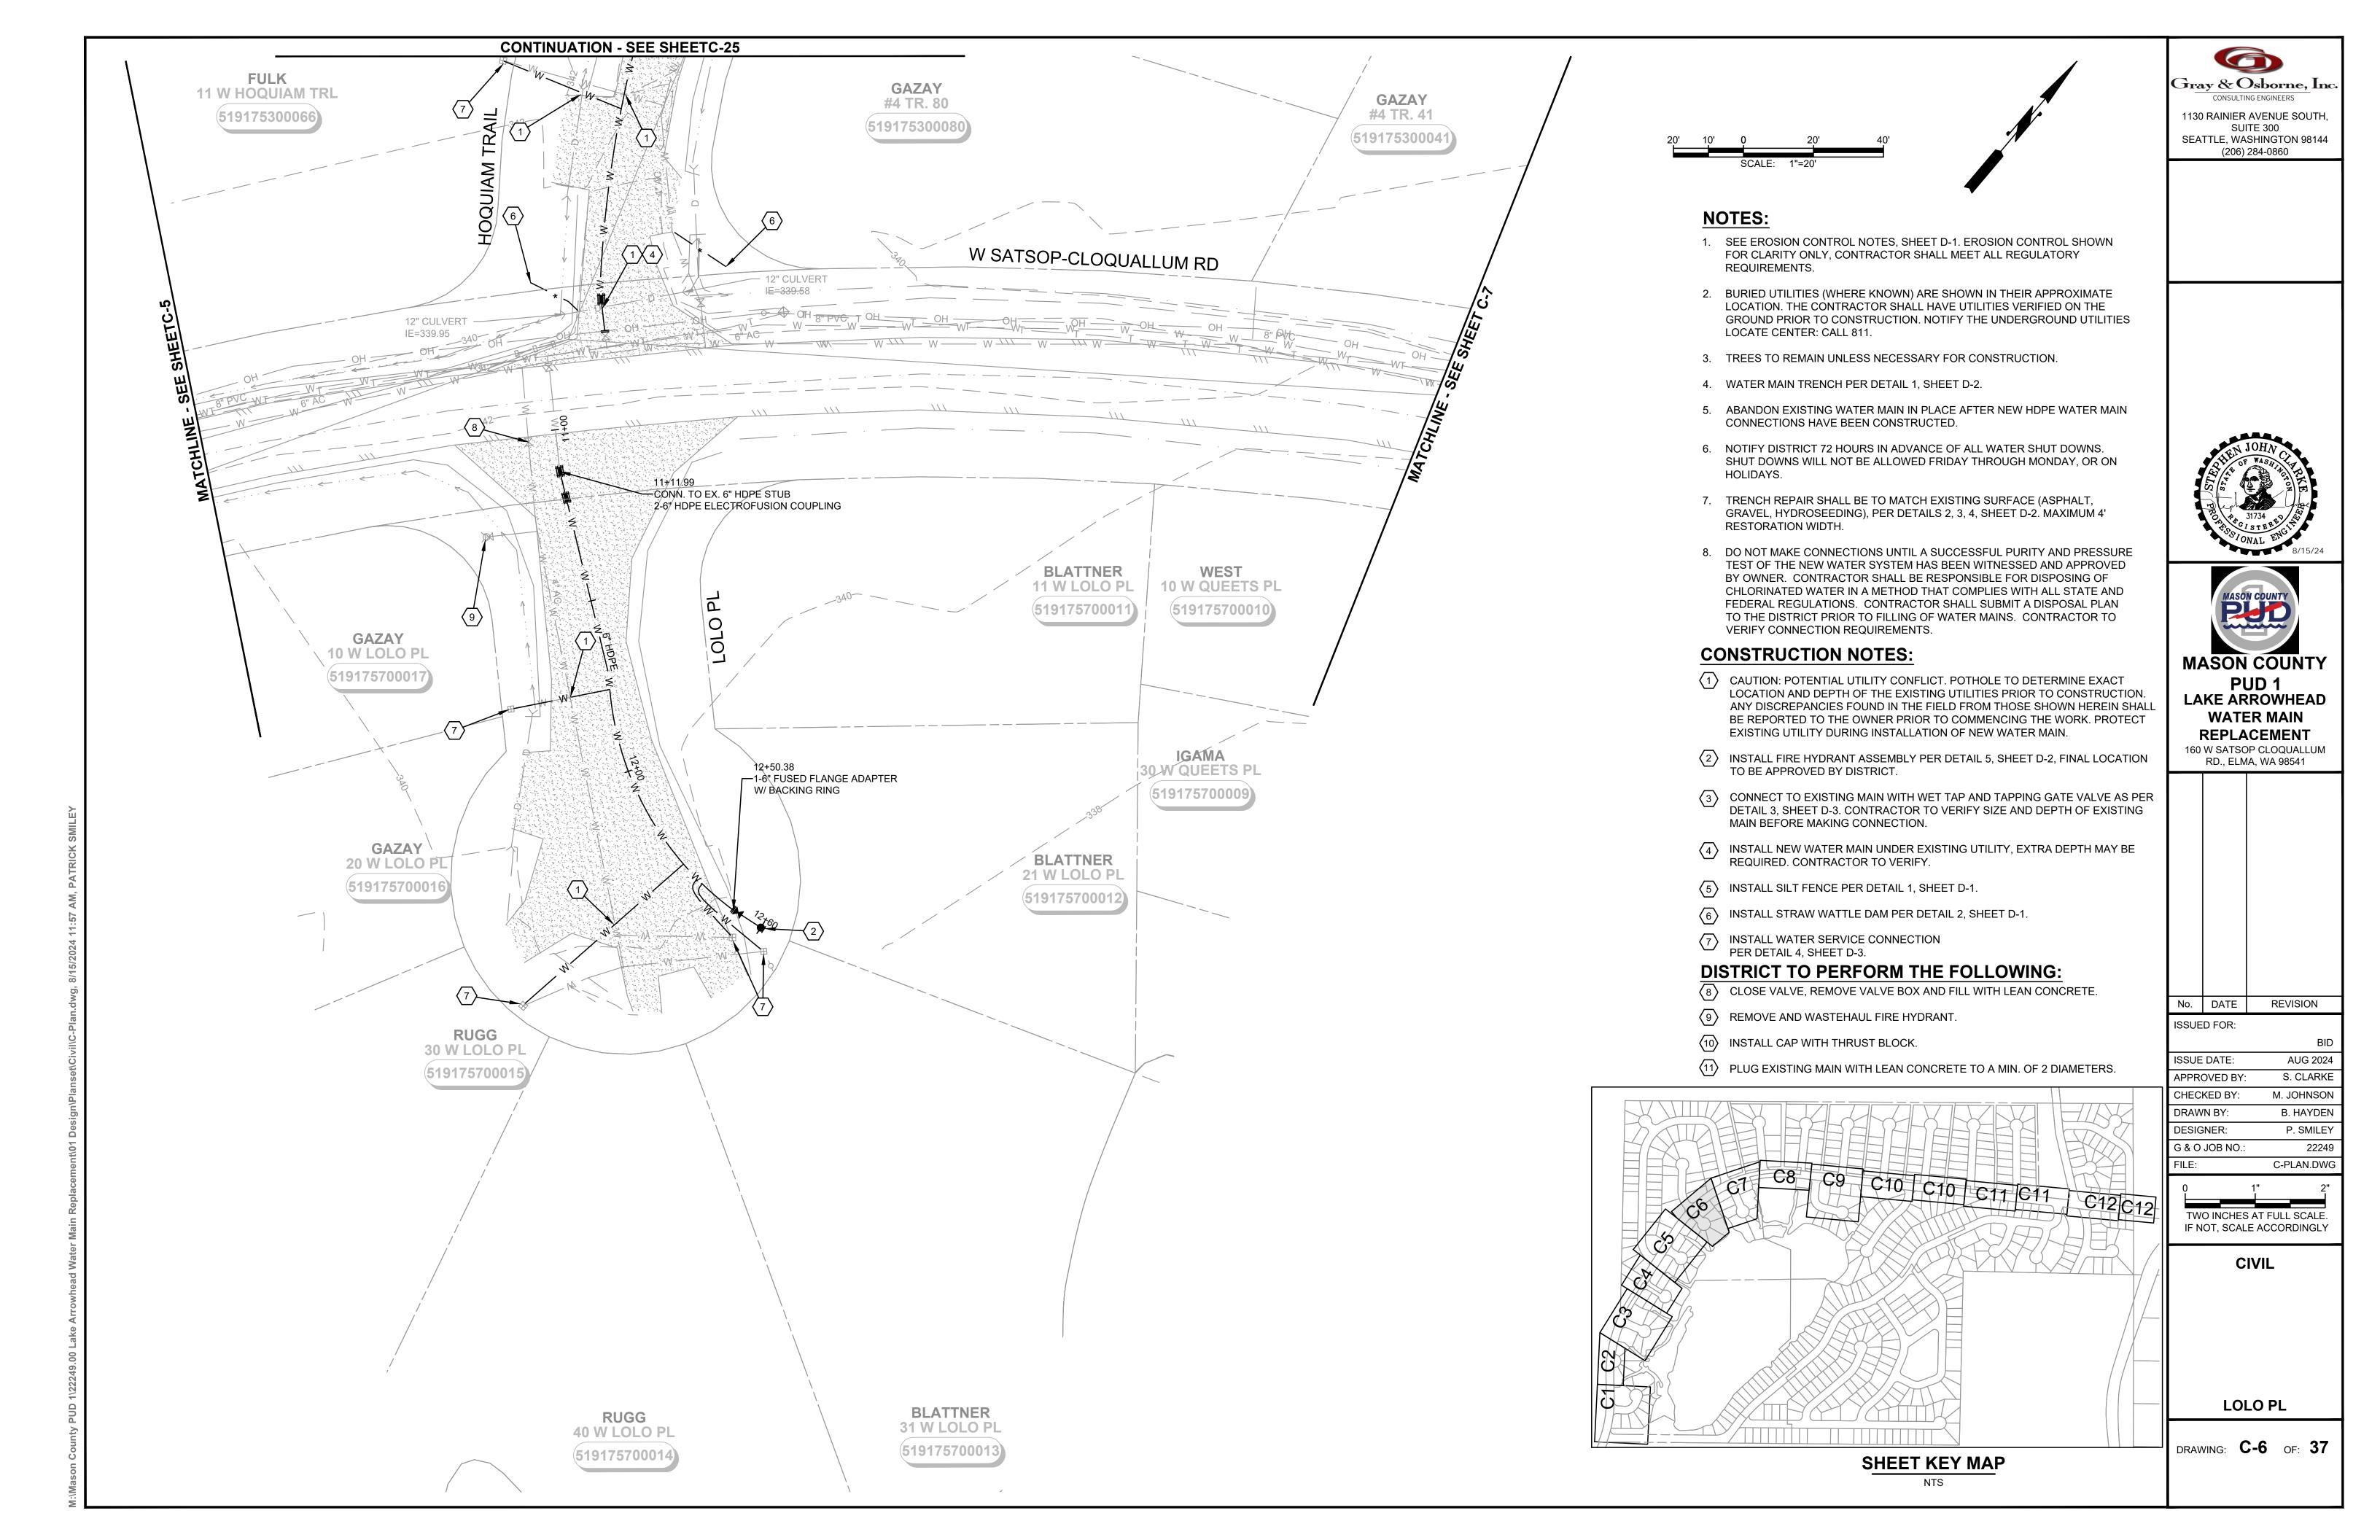




REVISION


AUG 2024 S. CLARKE M. JOHNSON B. HAYDEN

P. SMILEY C-PLAN.DWG

TWO INCHES AT FULL SCALE IF NOT, SCALE ACCORDINGLY

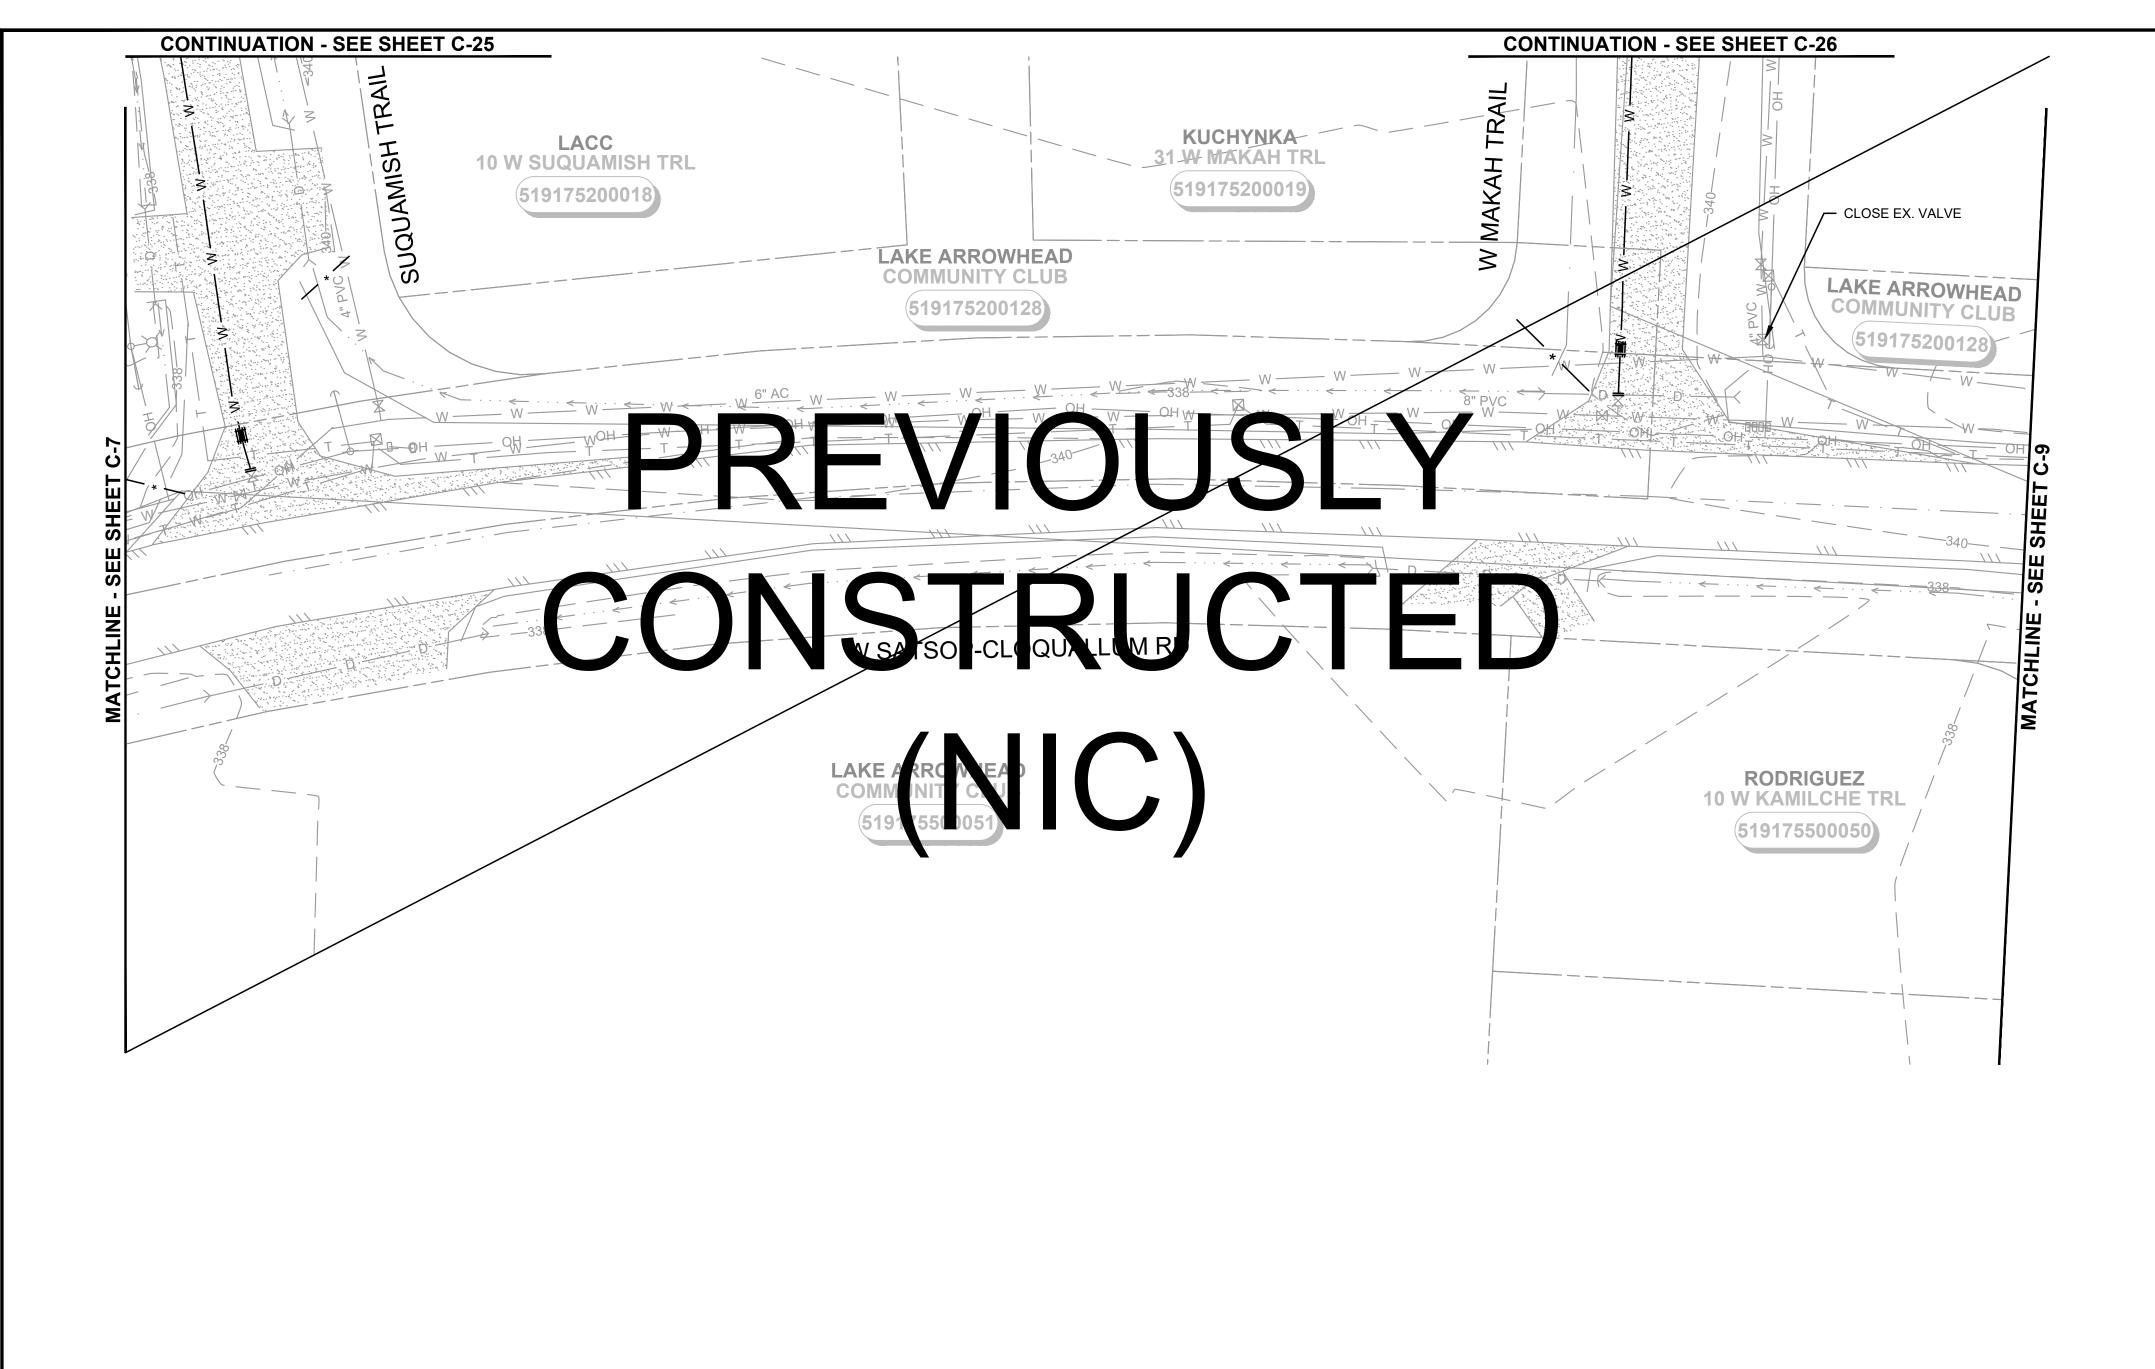



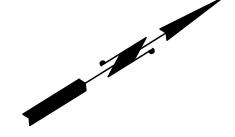

## Gray & Osborne, Inc. CONSULTING ENGINEERS 1130 RAINIER AVENUE SOUTH,

1130 RAINIER AVENUE SOUTH, SUITE 300 SEATTLE, WASHINGTON 98144 (206) 284-0860

### NOTES:


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- install new water main under existing utility, extra depth may be required. Contractor to verify.
- (5) INSTALL SILT FENCE PER DETAIL 1, SHEET D-1.
- (6) INSTALL STRAW WATTLE DAM PER DETAIL 2, SHEET D-1.
- 7 INSTALL WATER SERVICE CONNECTION PER DETAIL 4, SHEET D-3.


#### DISTRICT TO PERFORM THE FOLLOWING:

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SHEET KEY MAP

NT



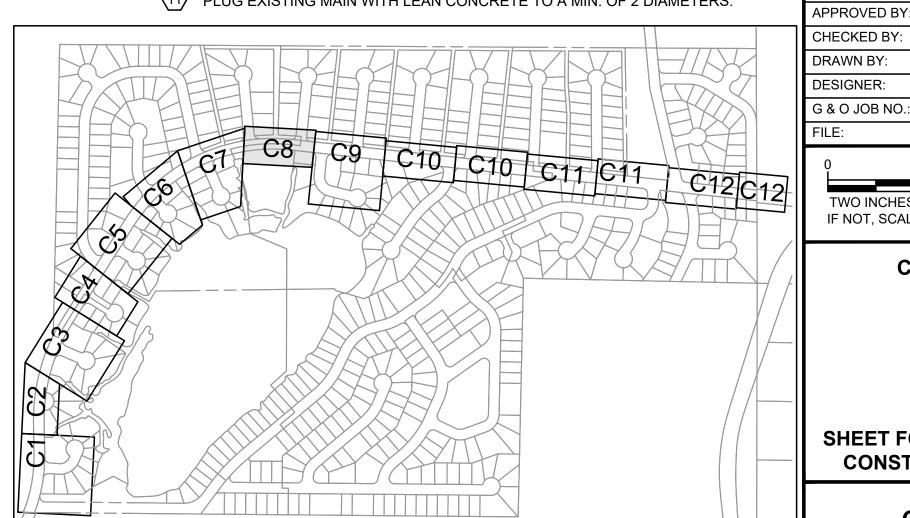

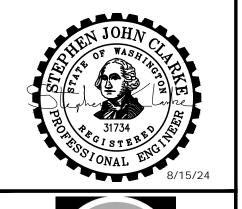RD., ELMA, WA 98541

No. DATE REVISION

ISSUED FOR:
BID
ISSUE DATE: AUG 2024

APPROVED BY: S. CLARKE
CHECKED BY: M. JOHNSON
DRAWN BY: B. HAYDEN
DESIGNER: P. SMILEY


0 1" 2"
TWO INCHES AT FULL SCALE.
IF NOT, SCALE ACCORDINGLY

C-PLAN.DWG

CIVIL

SHEET FOR FUTURE CONSTRUCTION


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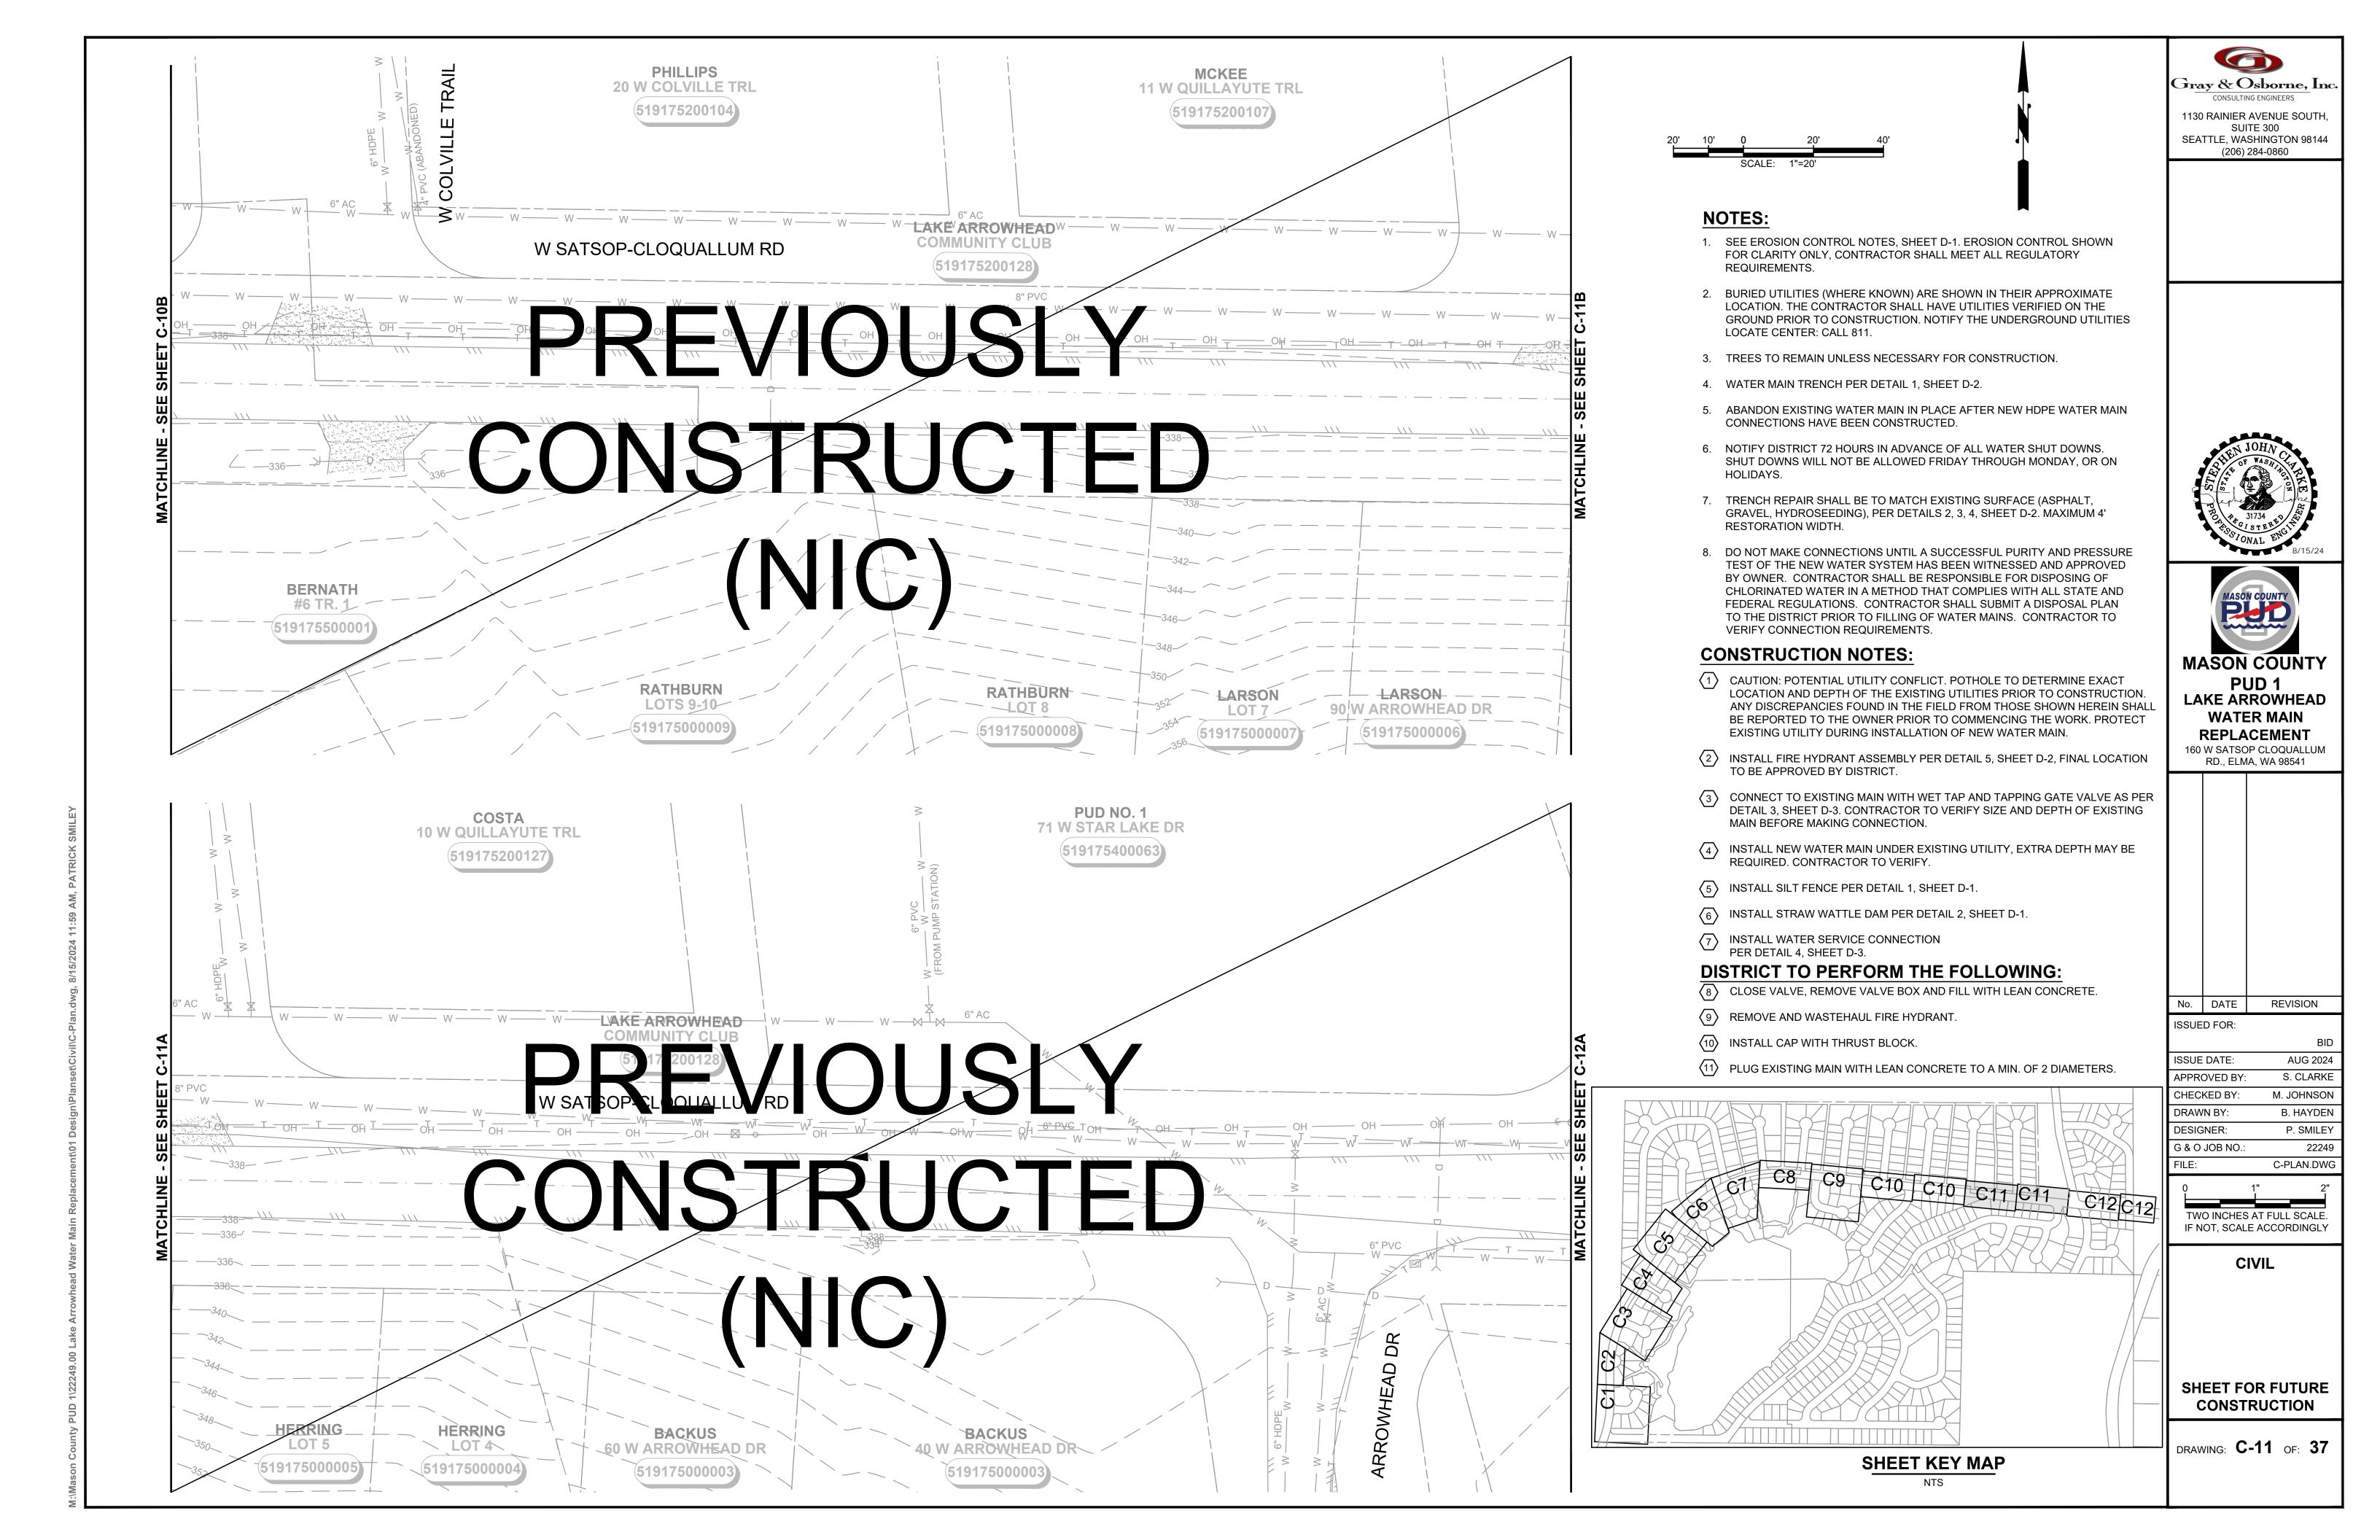


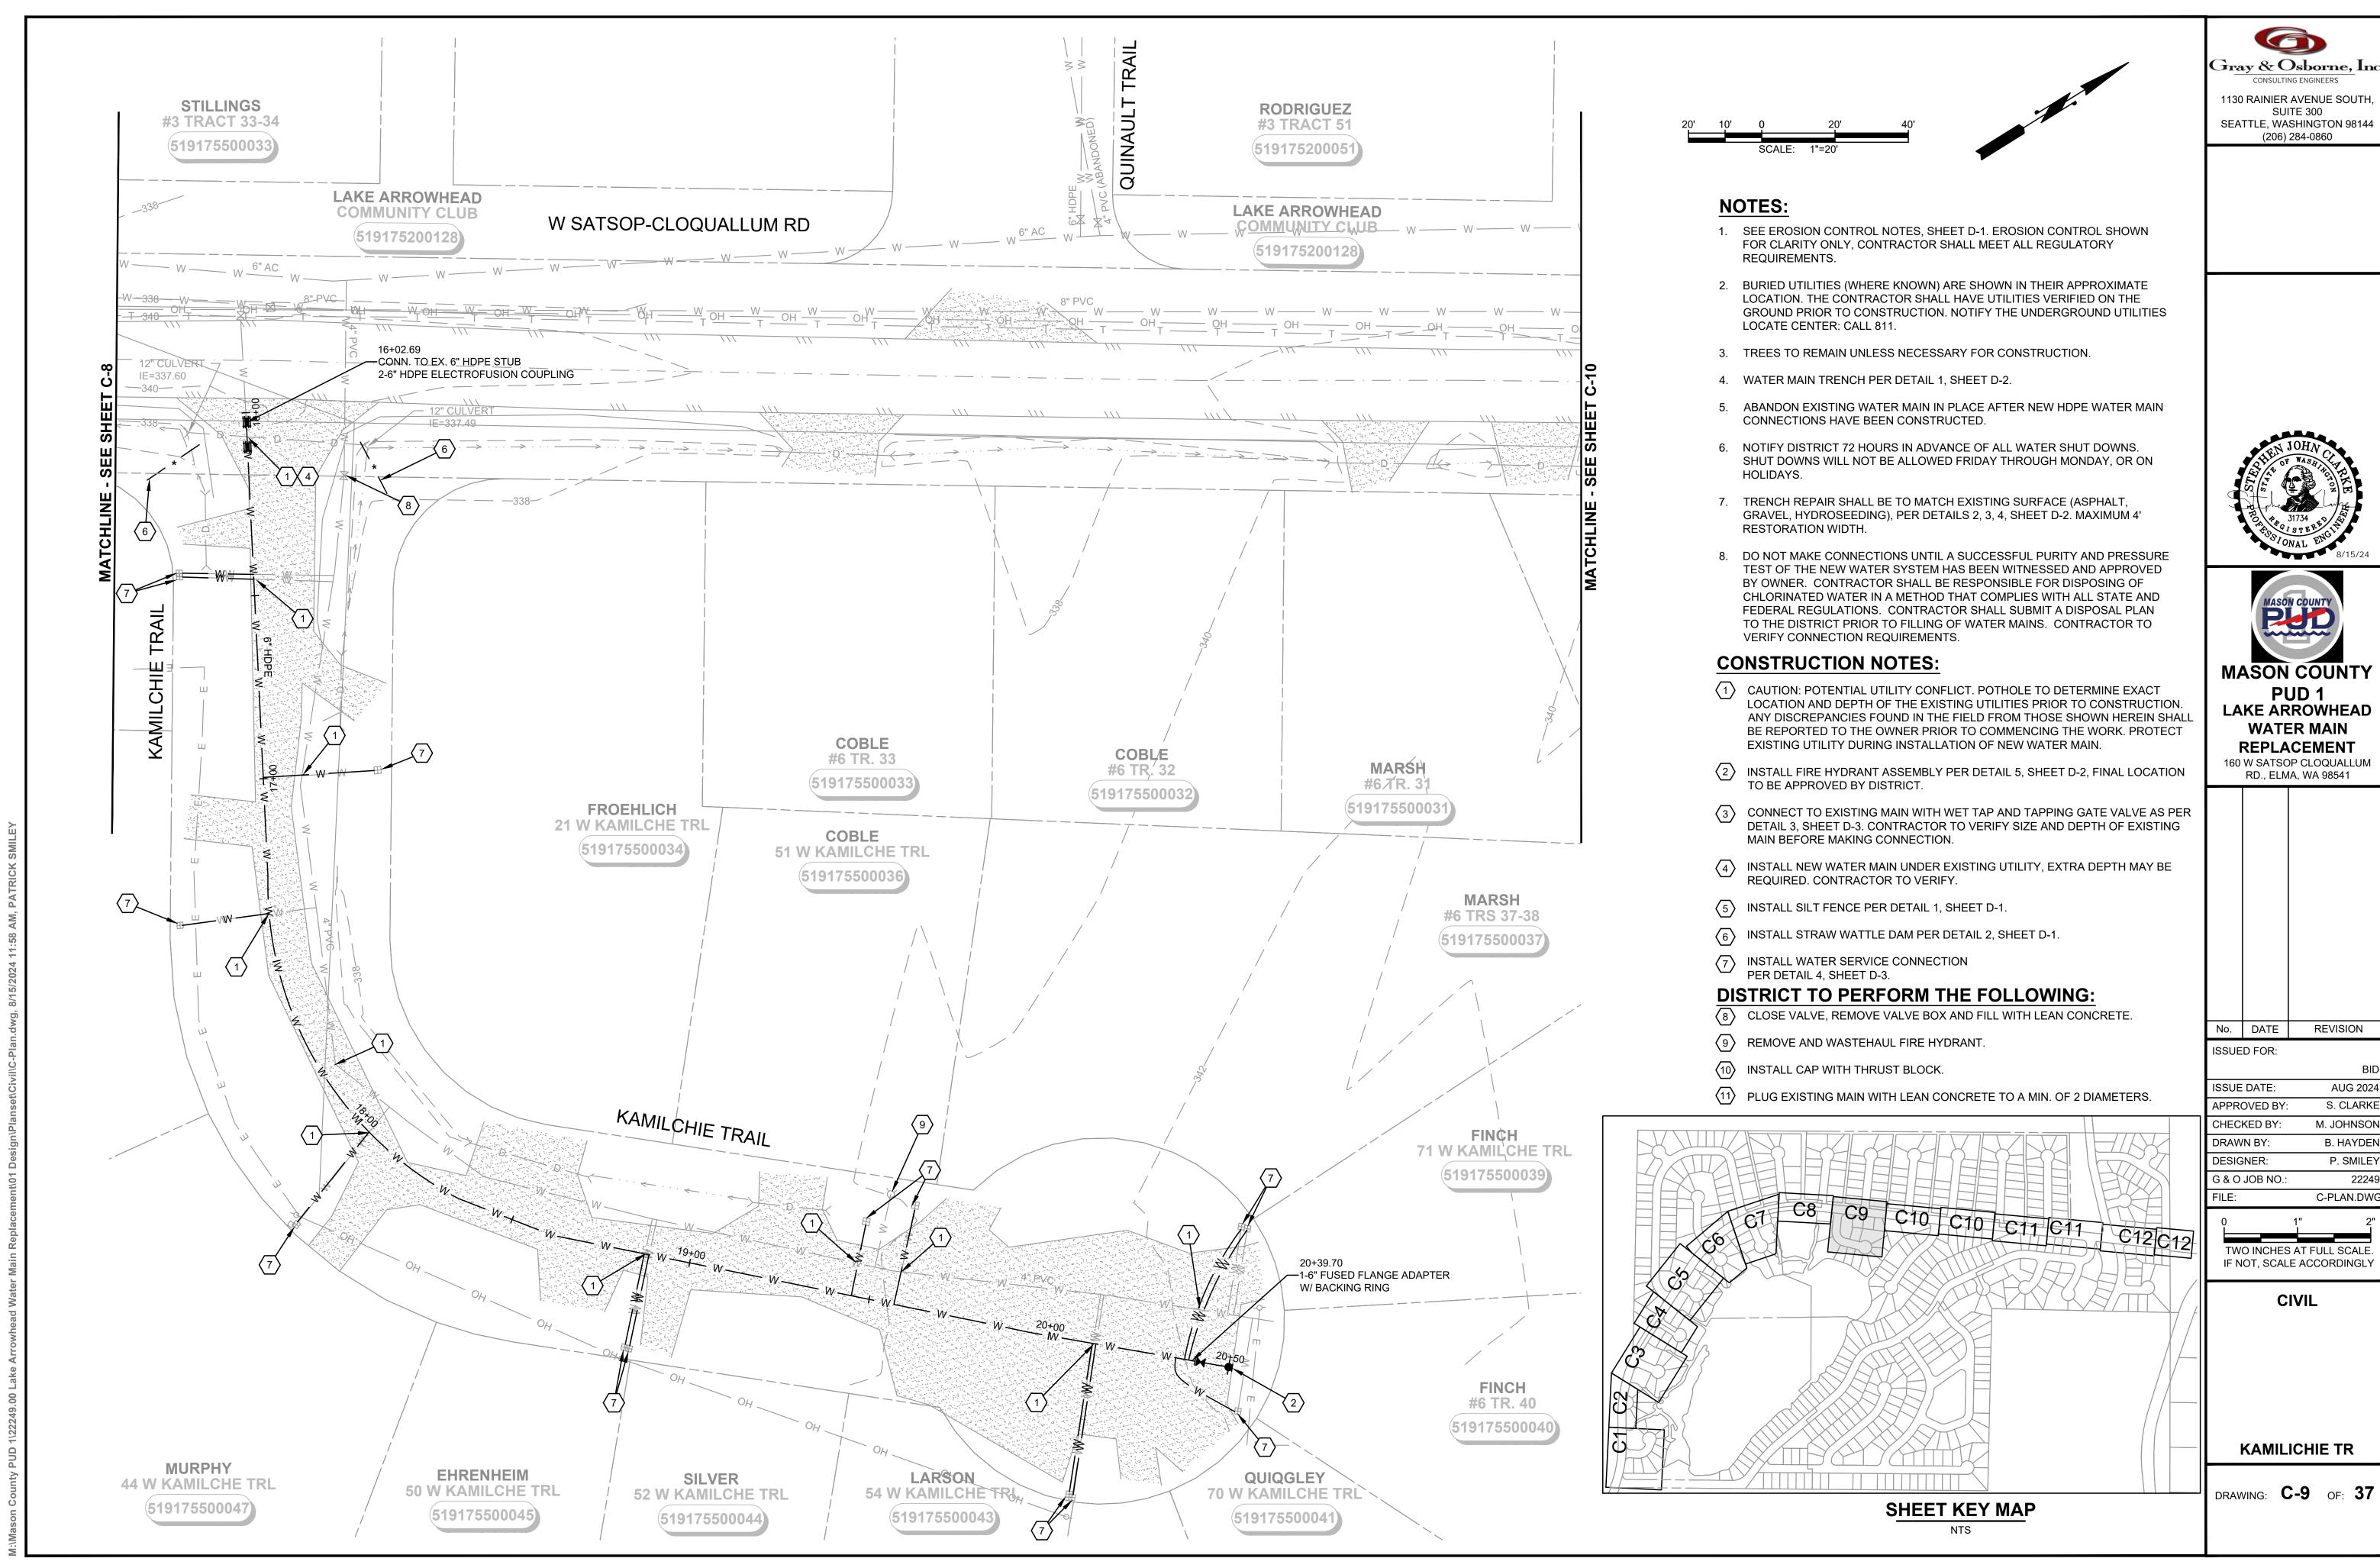



AUG 2024 S. CLARKE M. JOHNSON B. HAYDEN P. SMILEY

TWO INCHES AT FULL SCALE



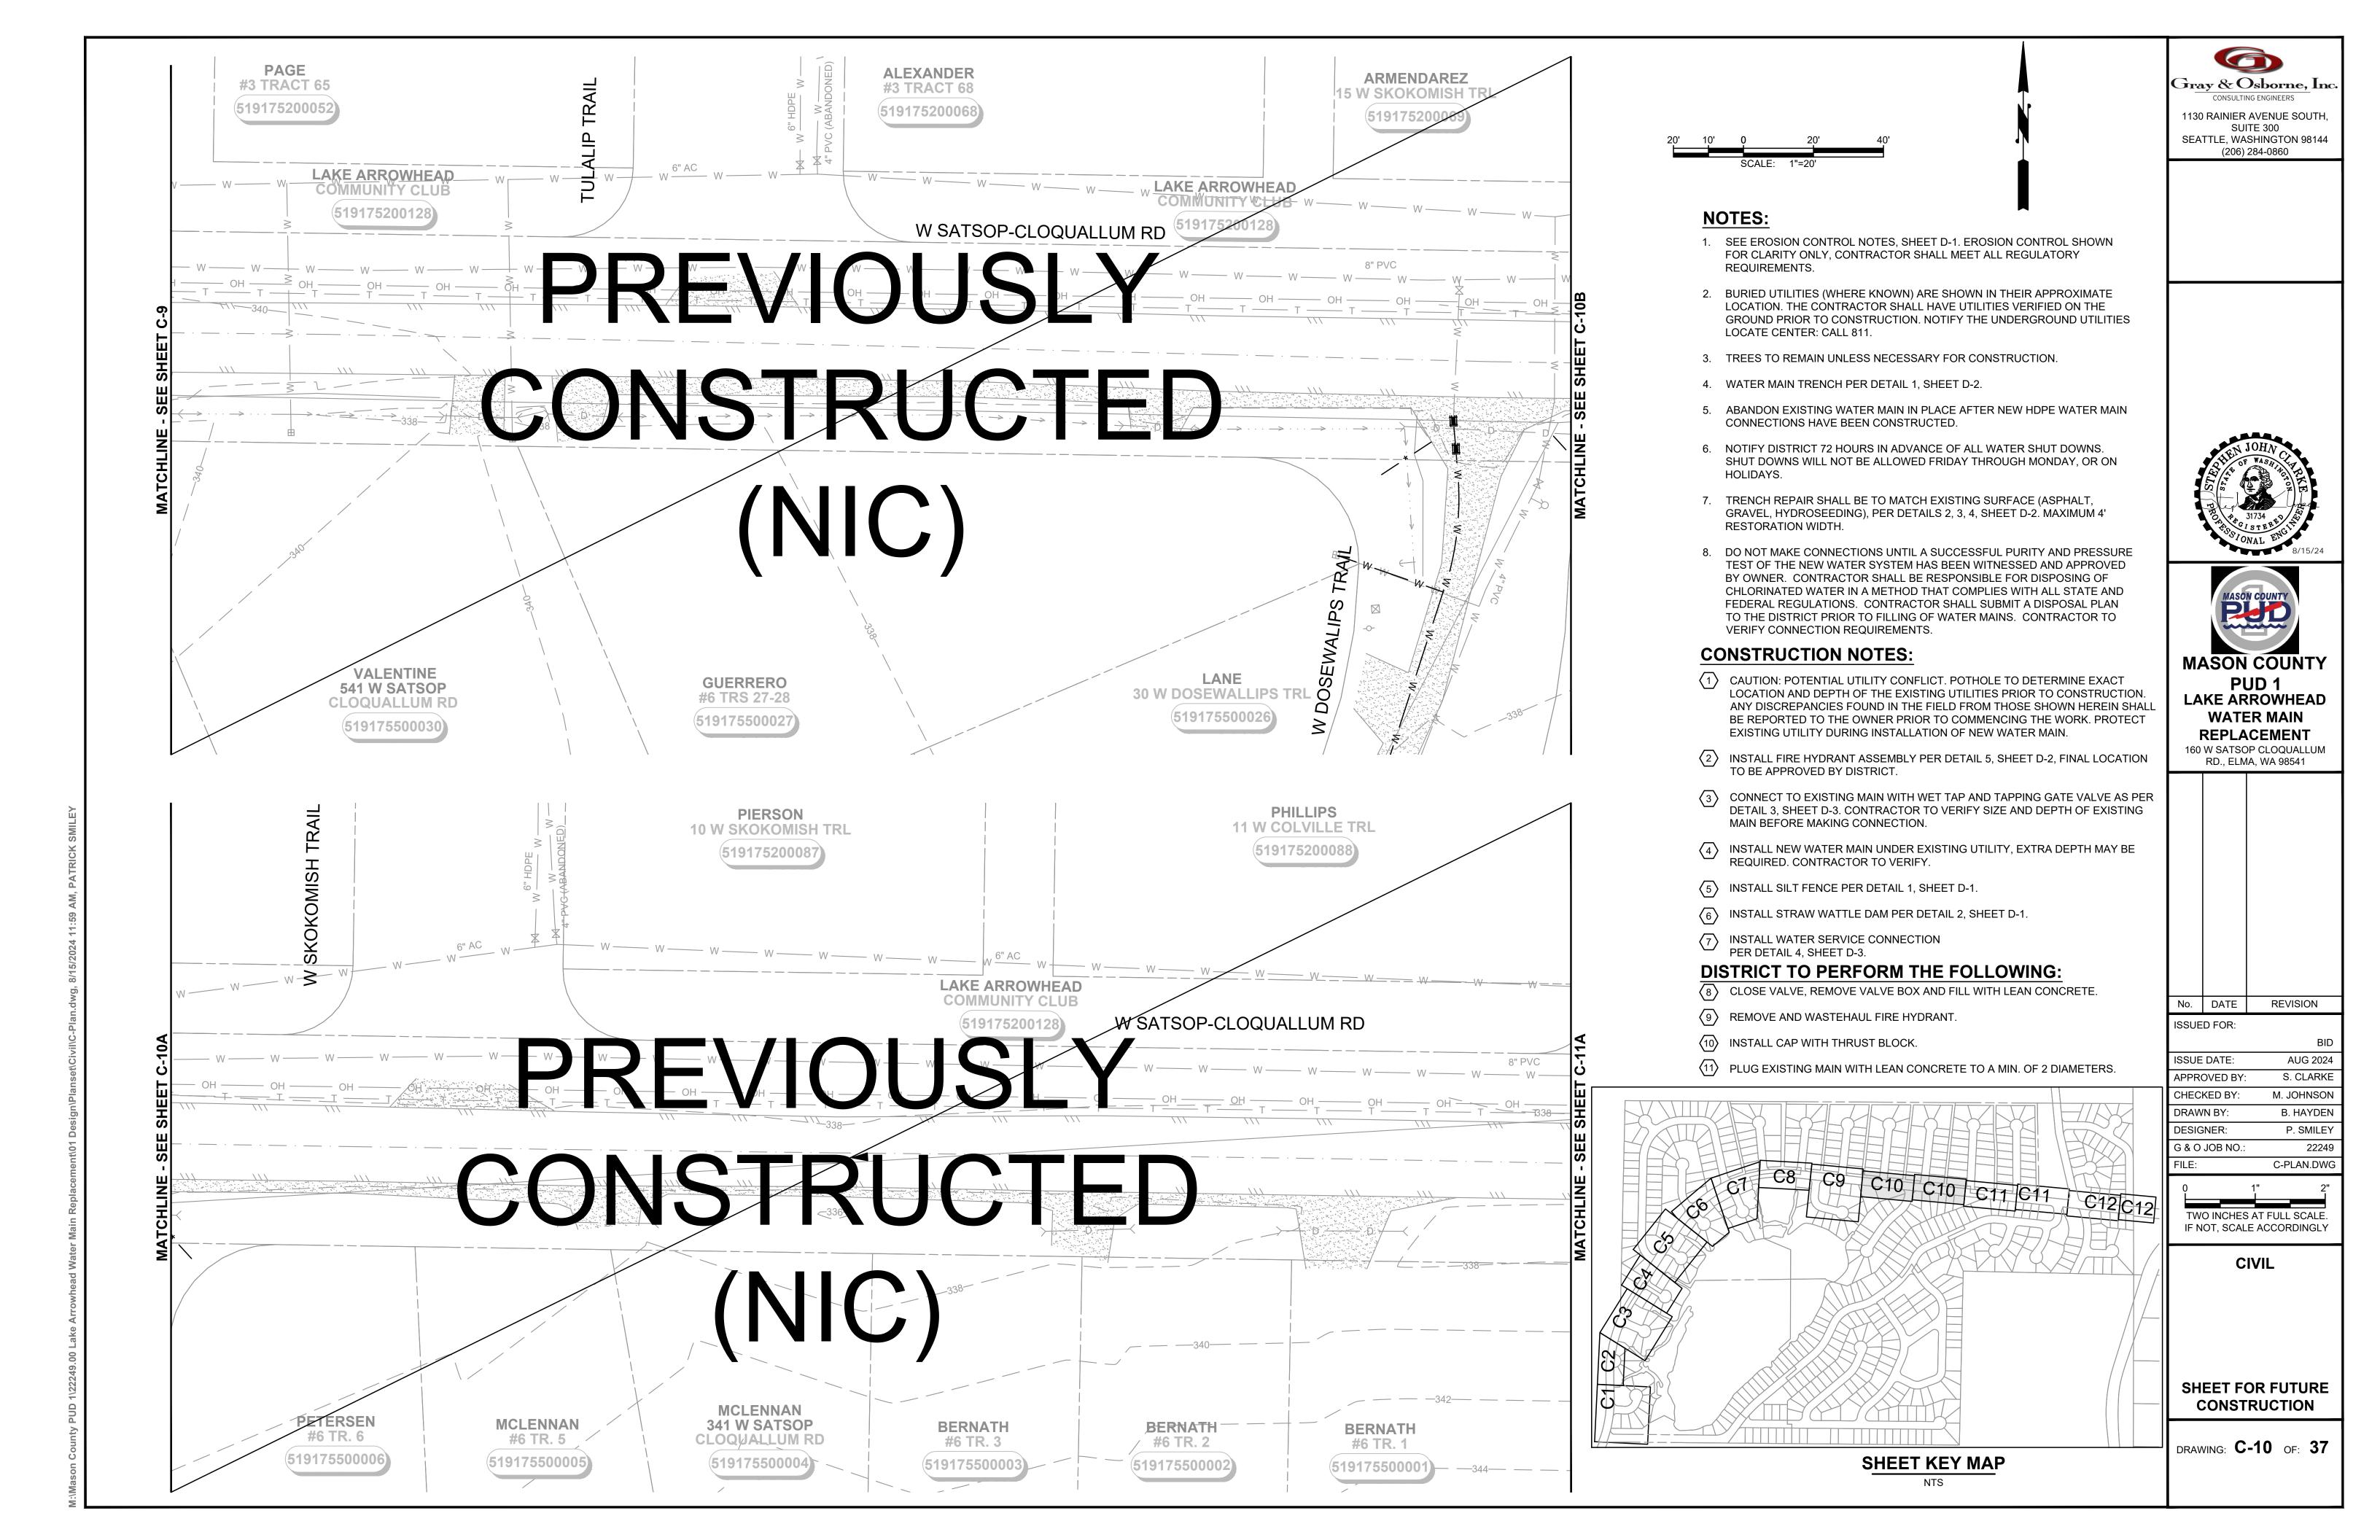

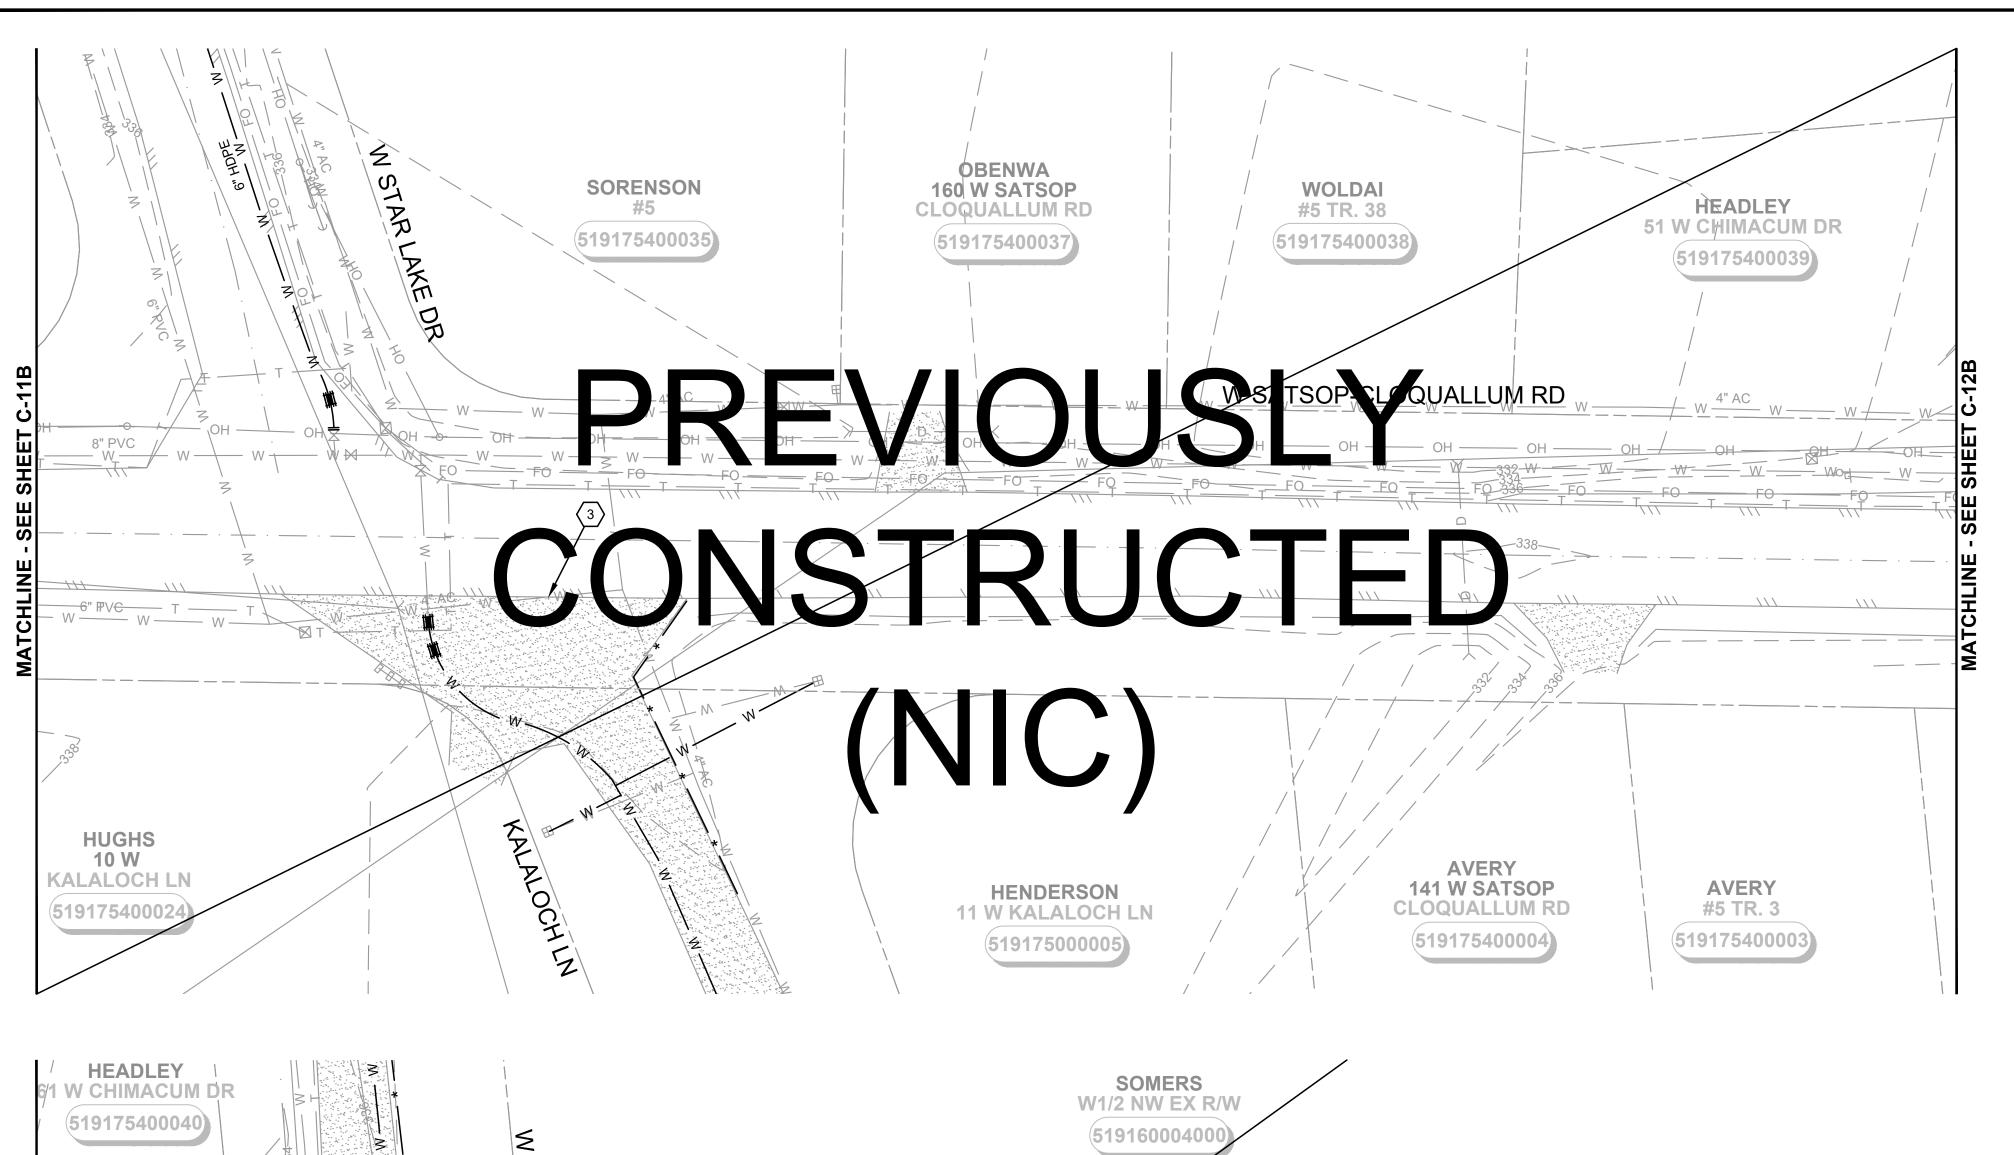

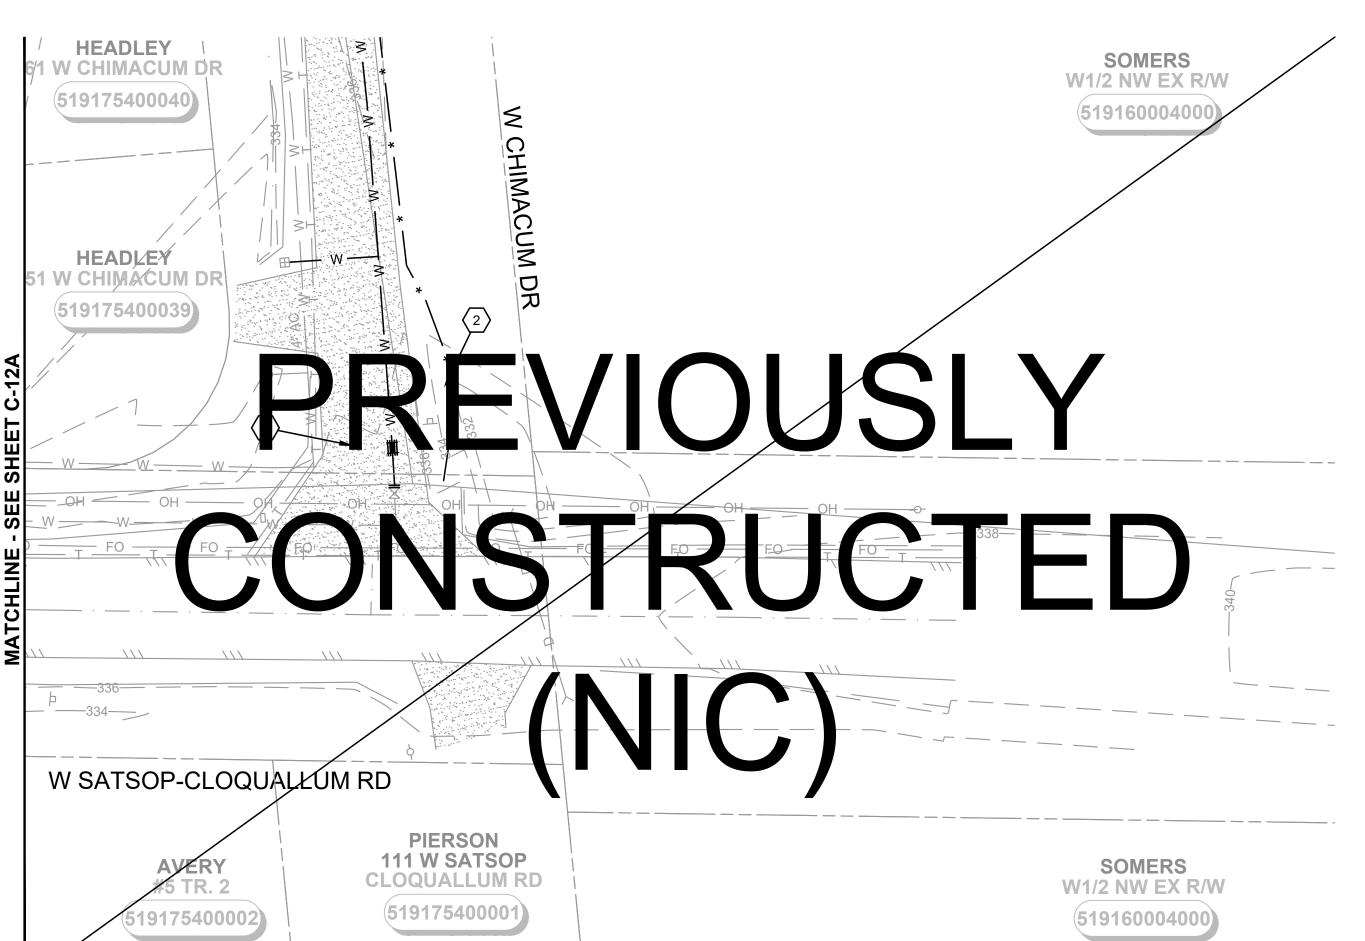





#### **NOTES:**


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- INSTALL STRAW WATTLE DAM PER DETAIL 2, SHEET D-1
- 7 INSTALL WATER SERVICE CONNECTION PER DETAIL 4, SHEET D-3.

#### DISTRICT TO PERFORM THE FOLLOWING:


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- PLUG EXISTING MAIN WITH LEAN CONCRETE TO A MIN. OF 2 DIAMETERS.



**SHEET KEY MAP** 

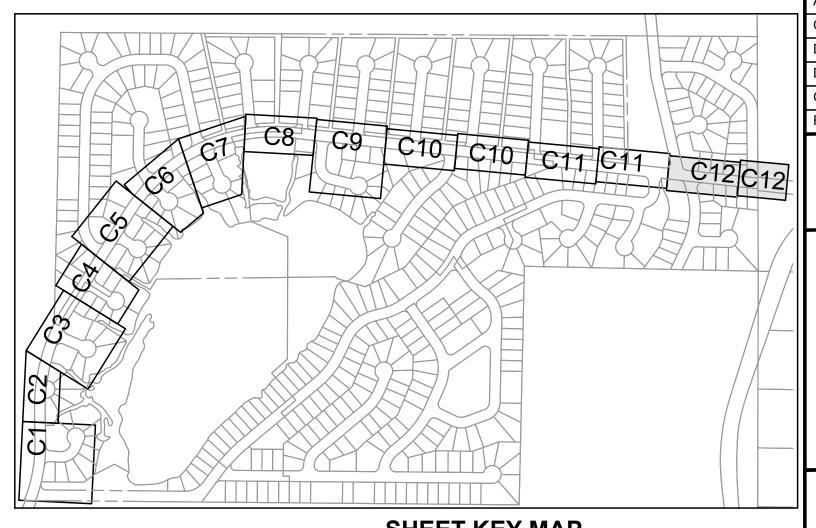

1130 RAINIER AVENUE SOUTH SUITE 300 SEATTLE, WASHINGTON 98144 (206) 284-0860

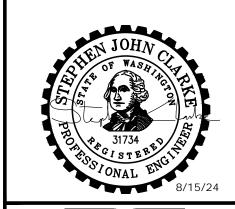



**WATER MAIN REPLACEMENT** 

160 W SATSOP CLOQUALLUM RD., ELMA, WA 98541

No. DATE REVISION

ISSUED FOR: ISSUE DATE: AUG 2024


APPROVED BY: S. CLARKE M. JOHNSON CHECKED BY: B. HAYDEN P. SMILEY G & O JOB NO. C-PLAN.DWC


TWO INCHES AT FULL SCALE IF NOT, SCALE ACCORDINGLY


CIVIL


SHEET FOR FUTURE CONSTRUCTION


DRAWING: C-12 OF: 37

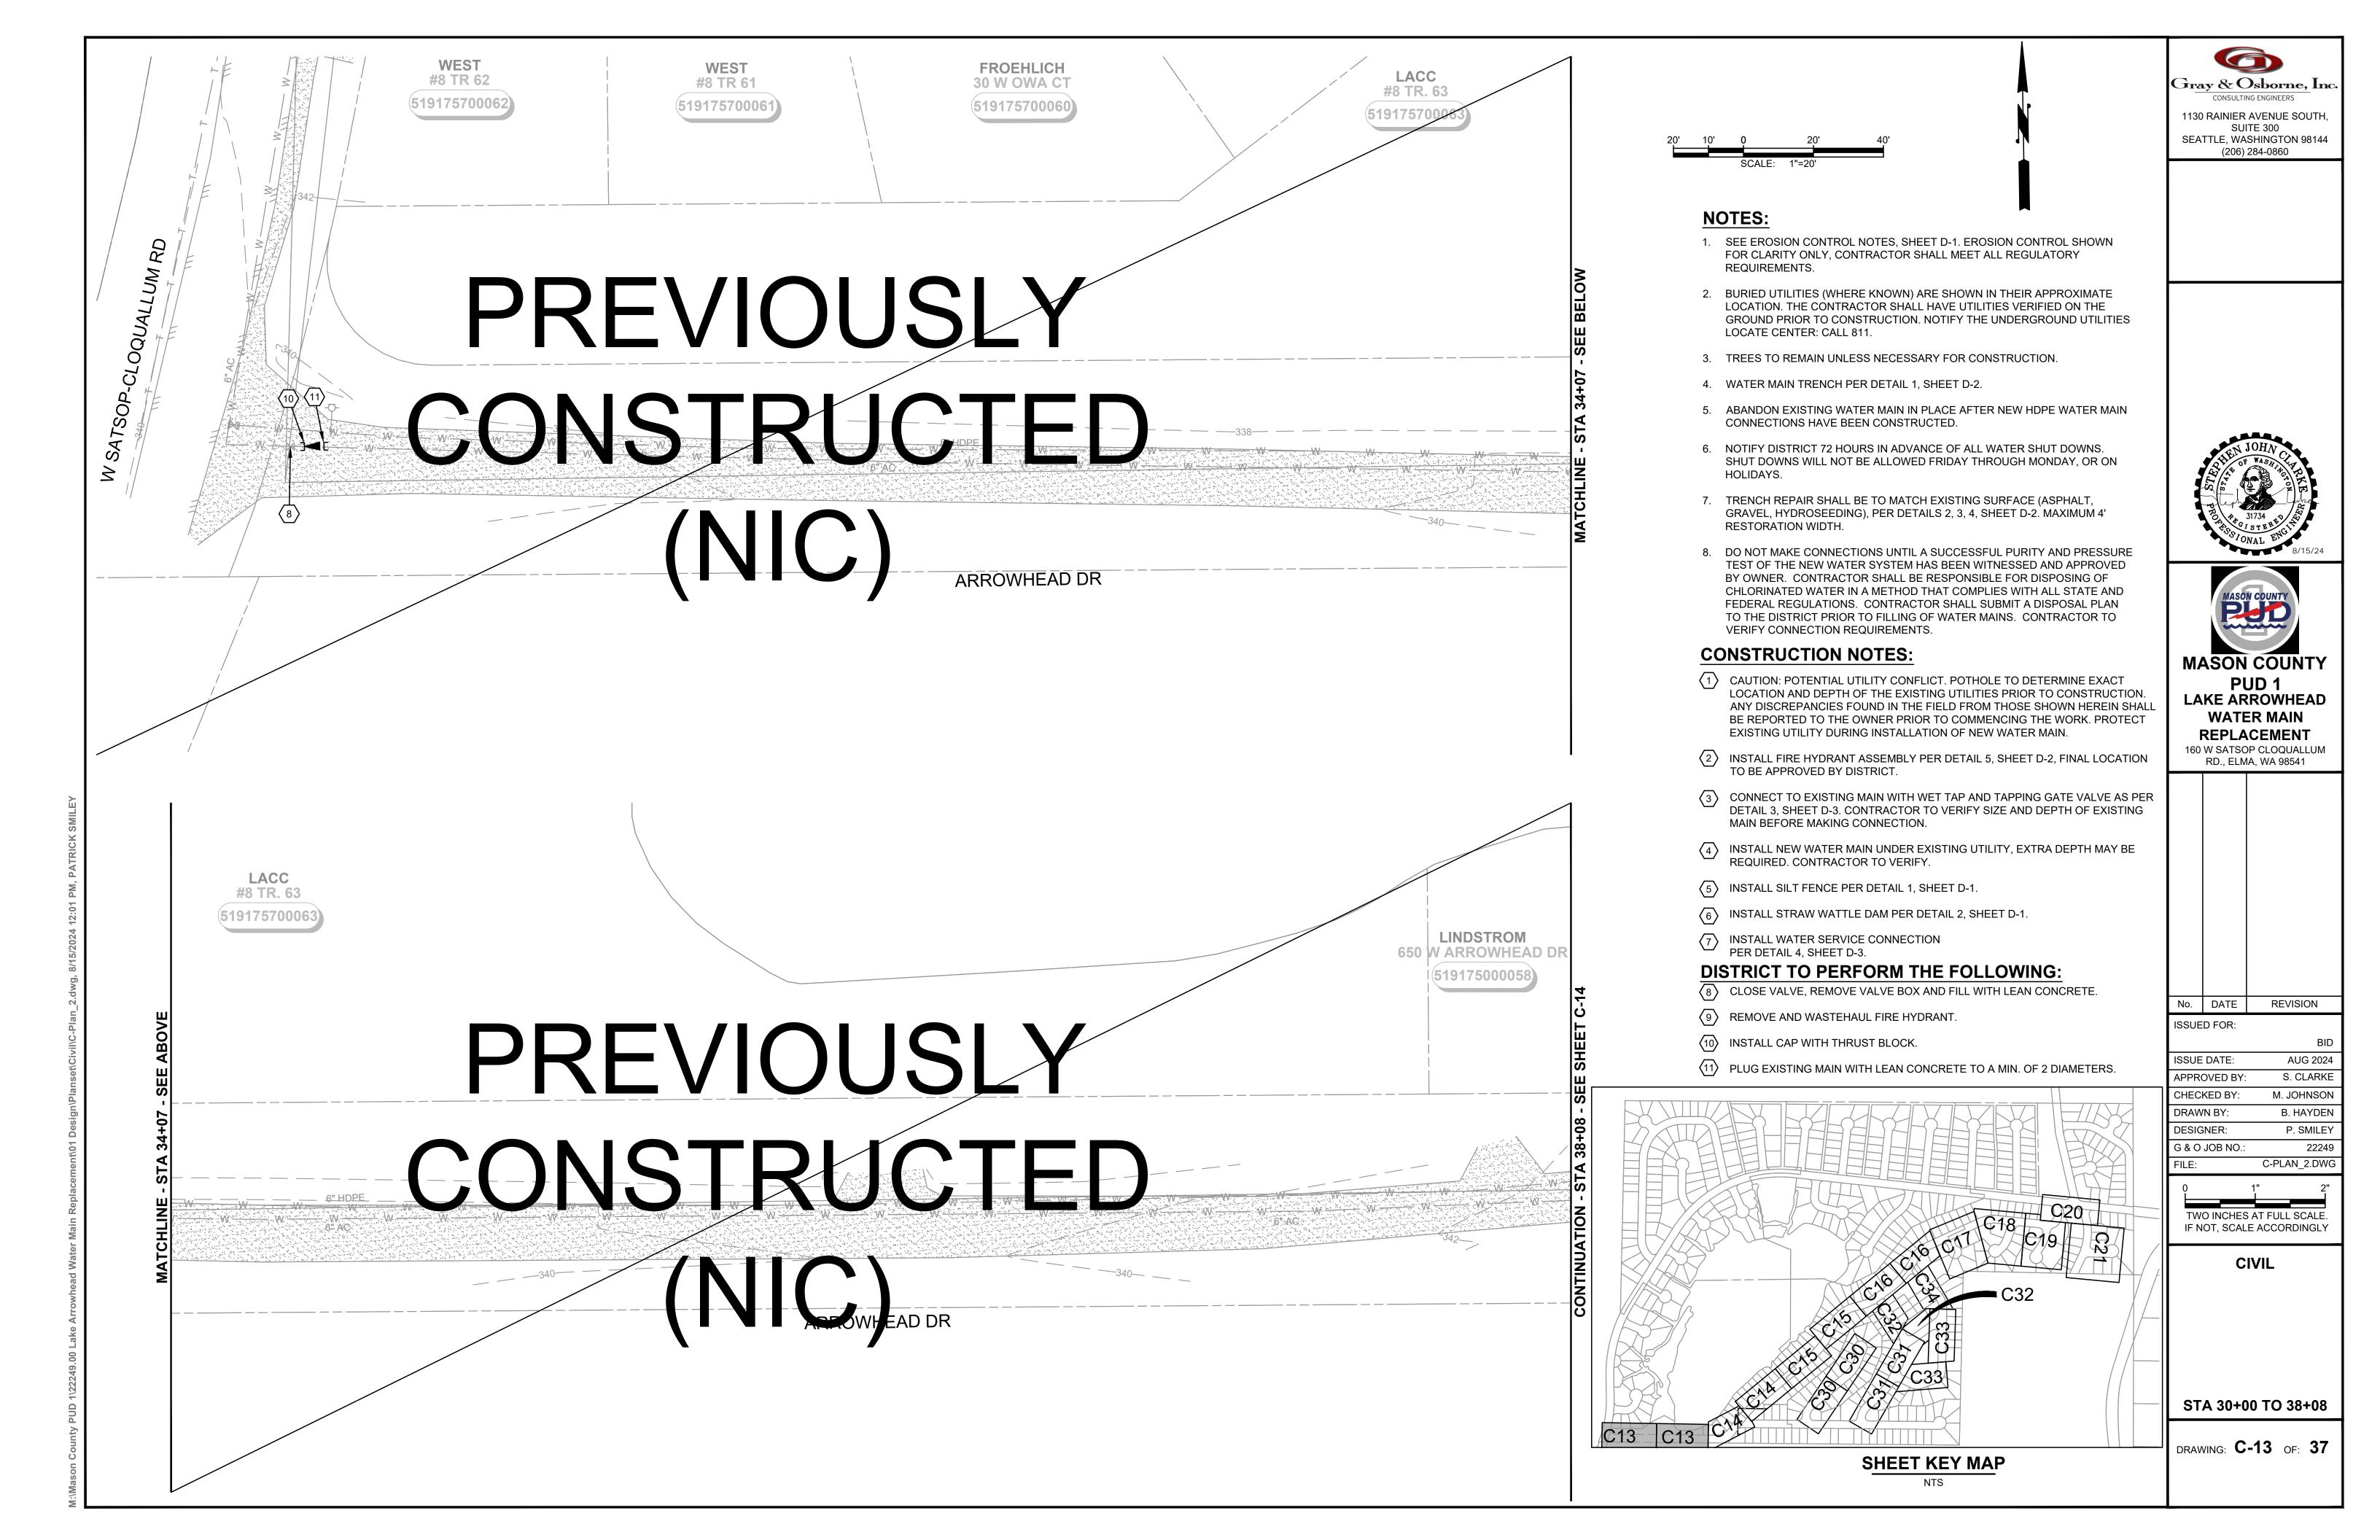


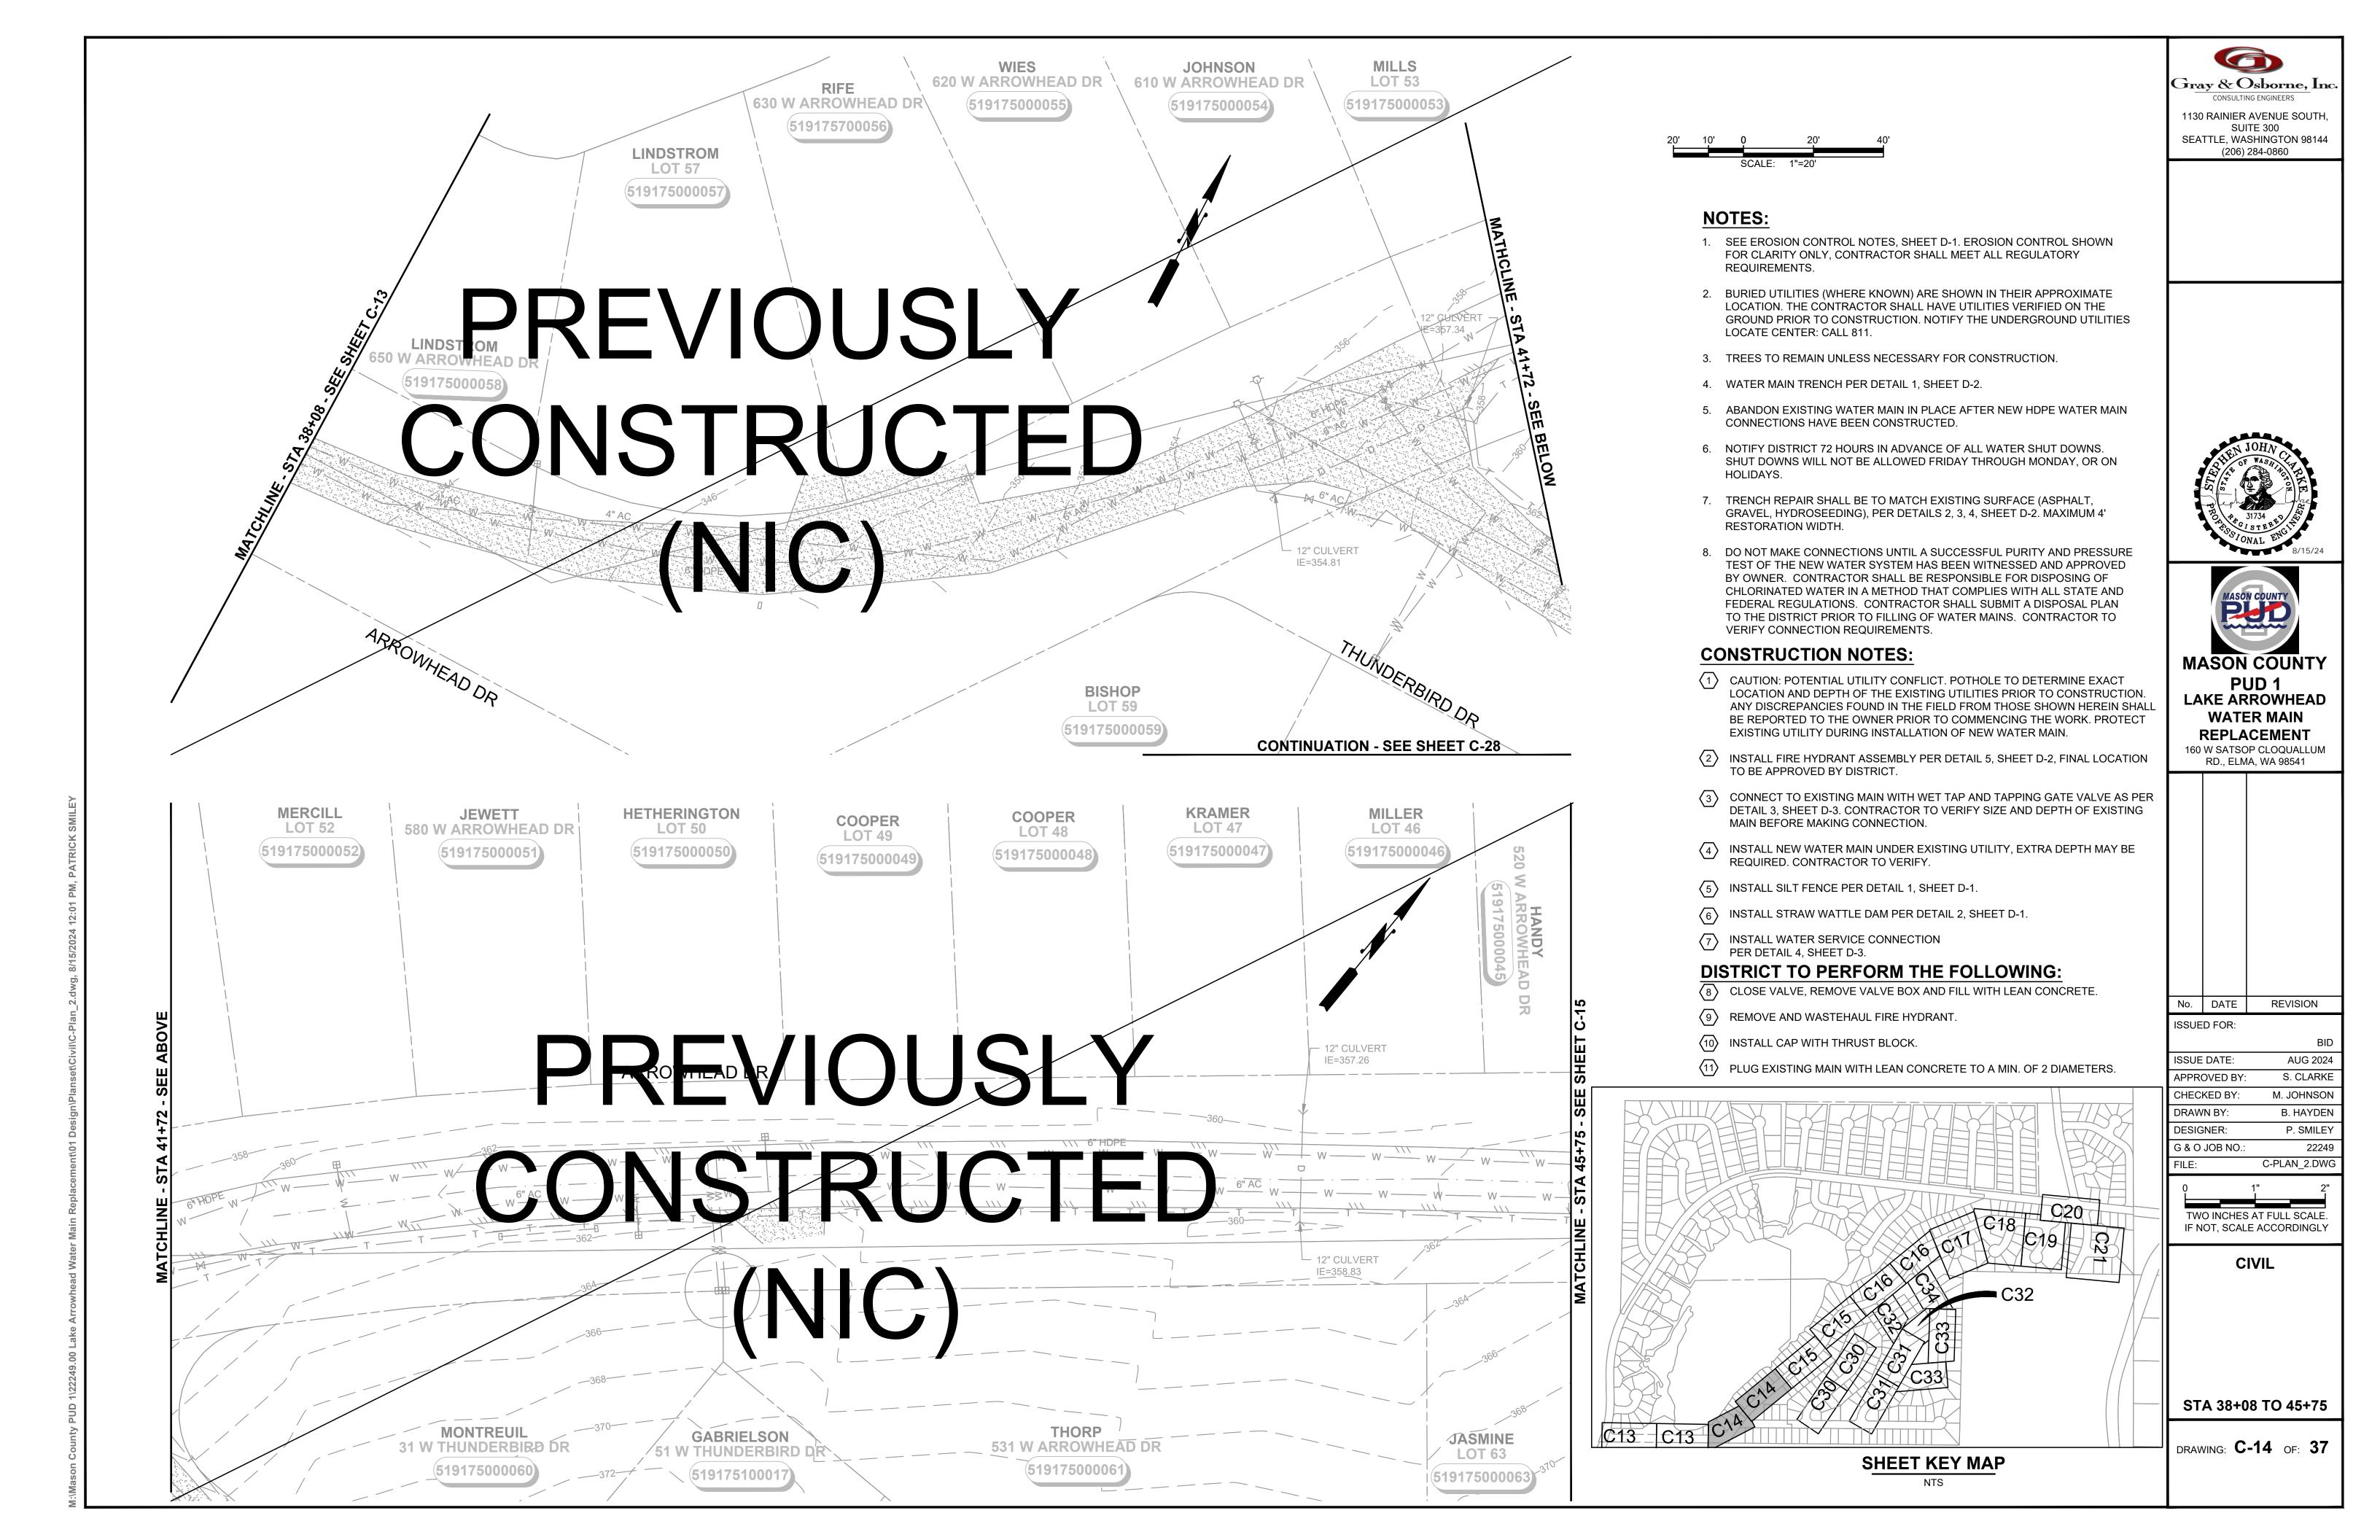


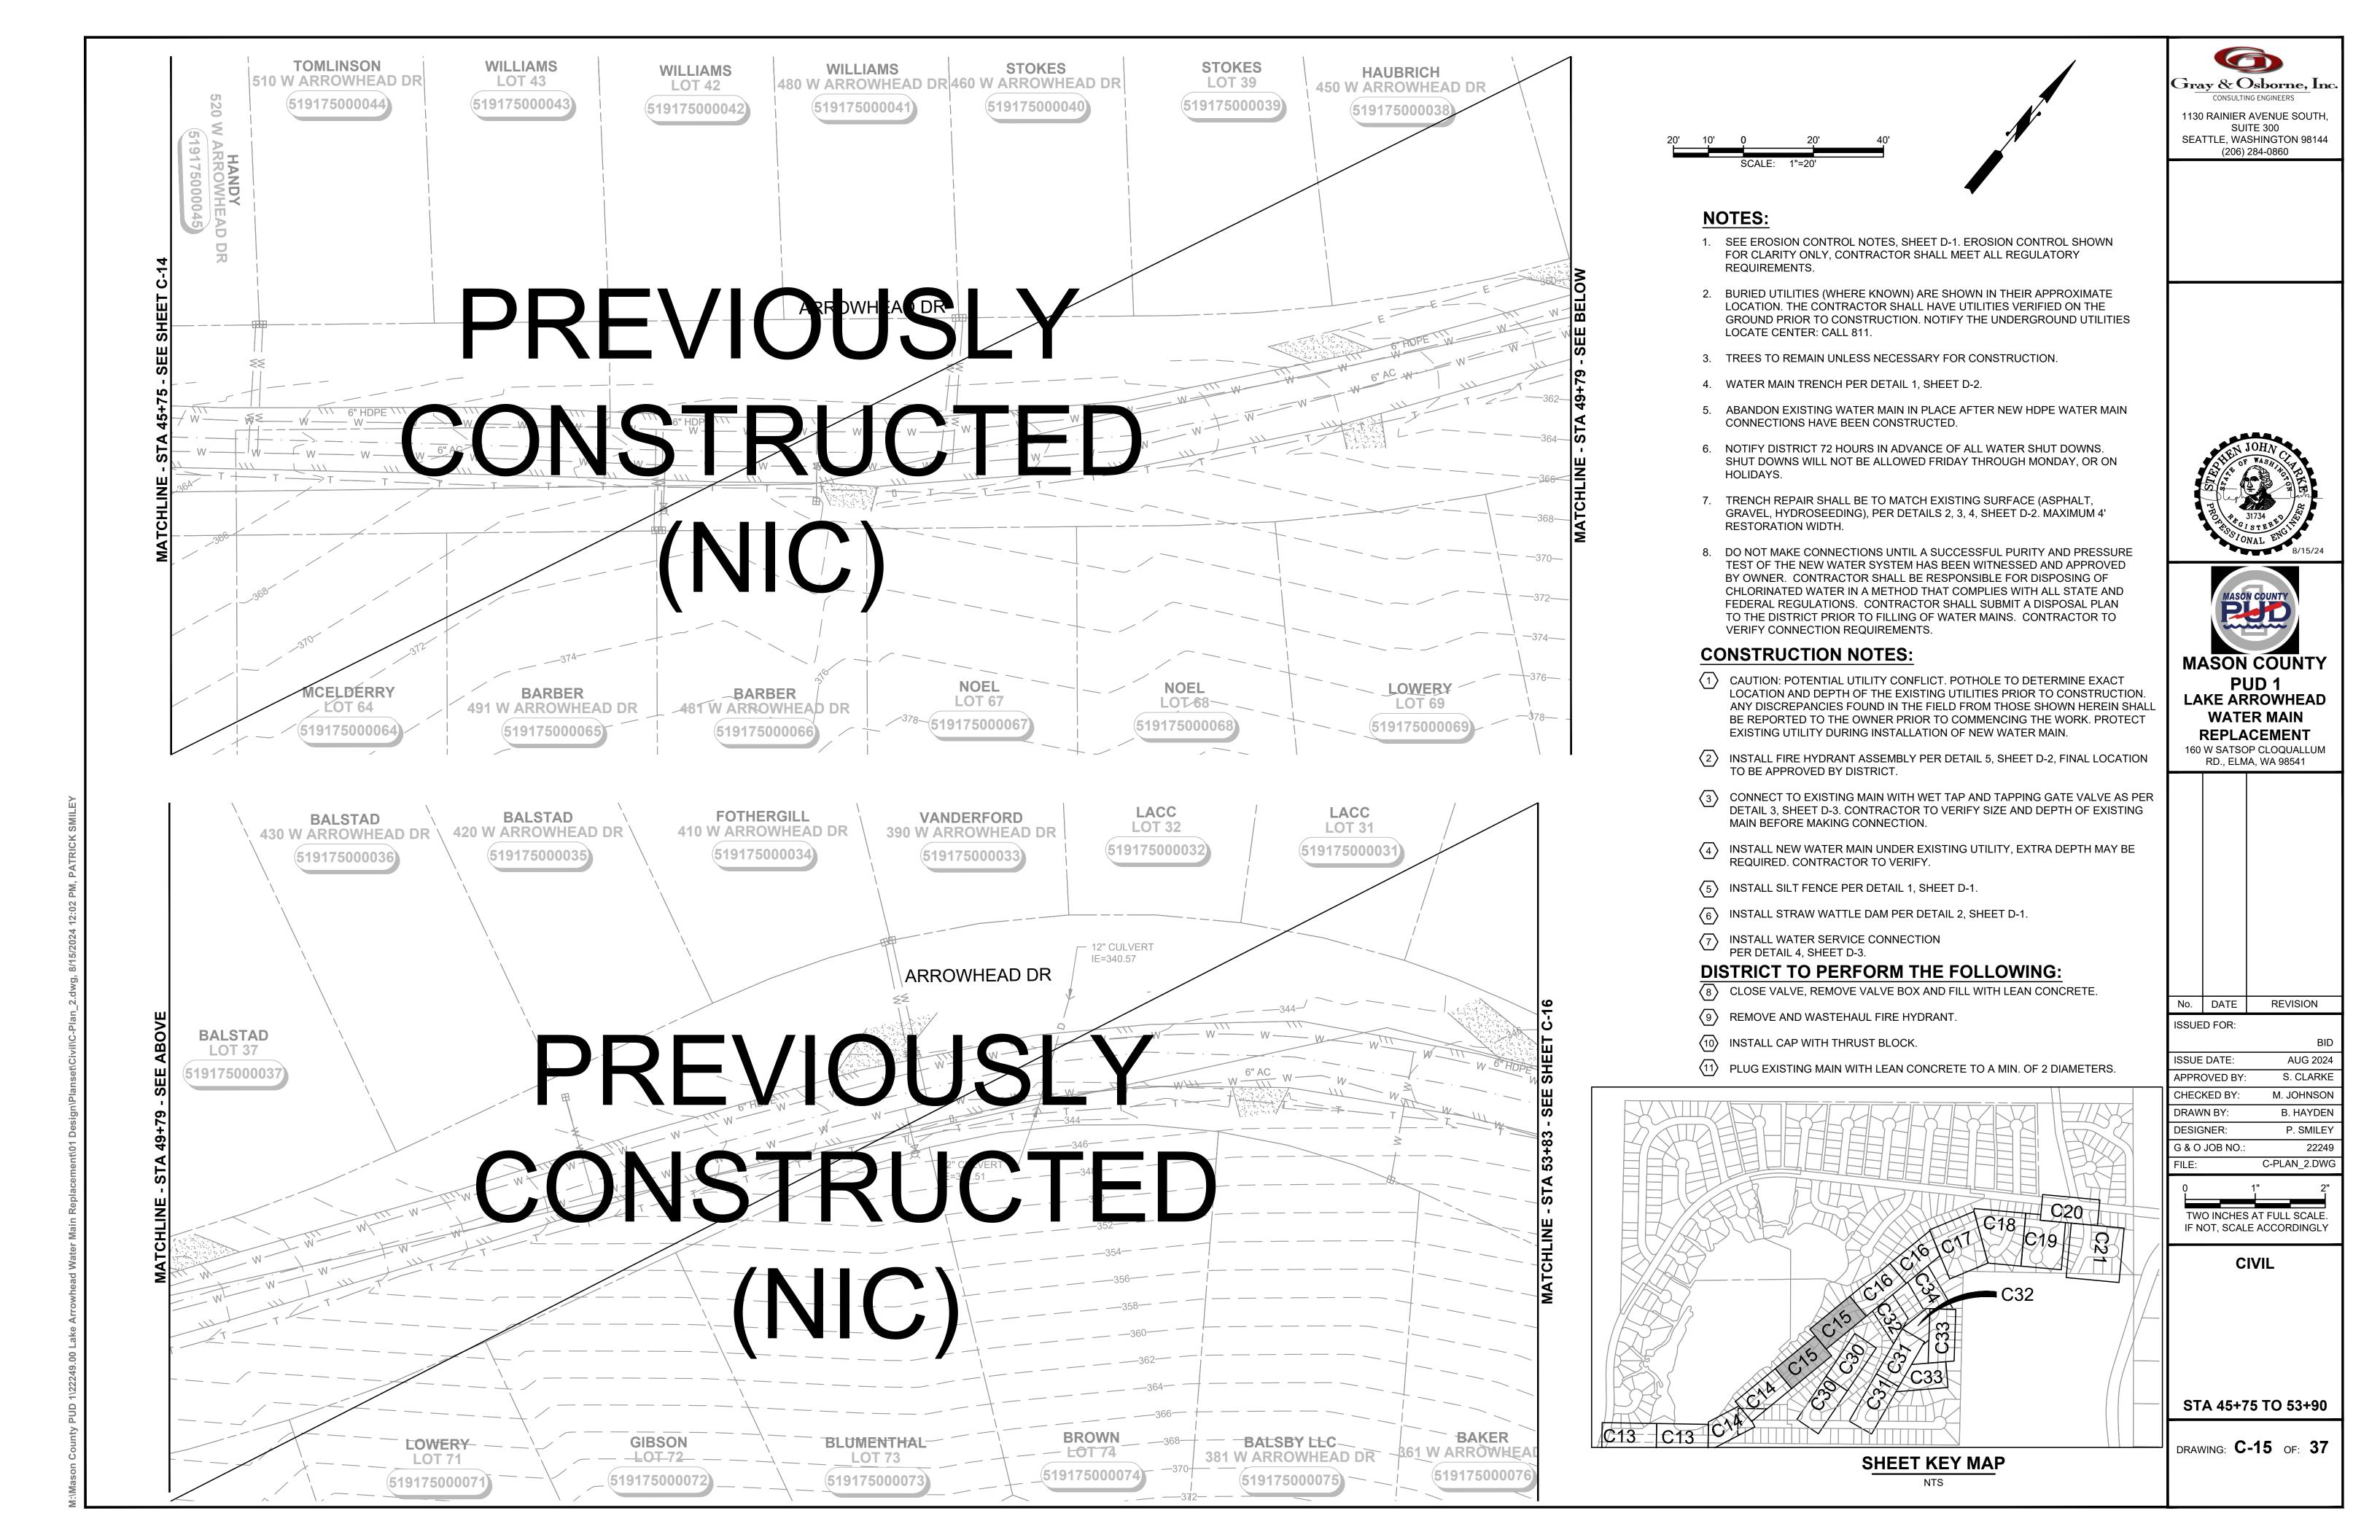


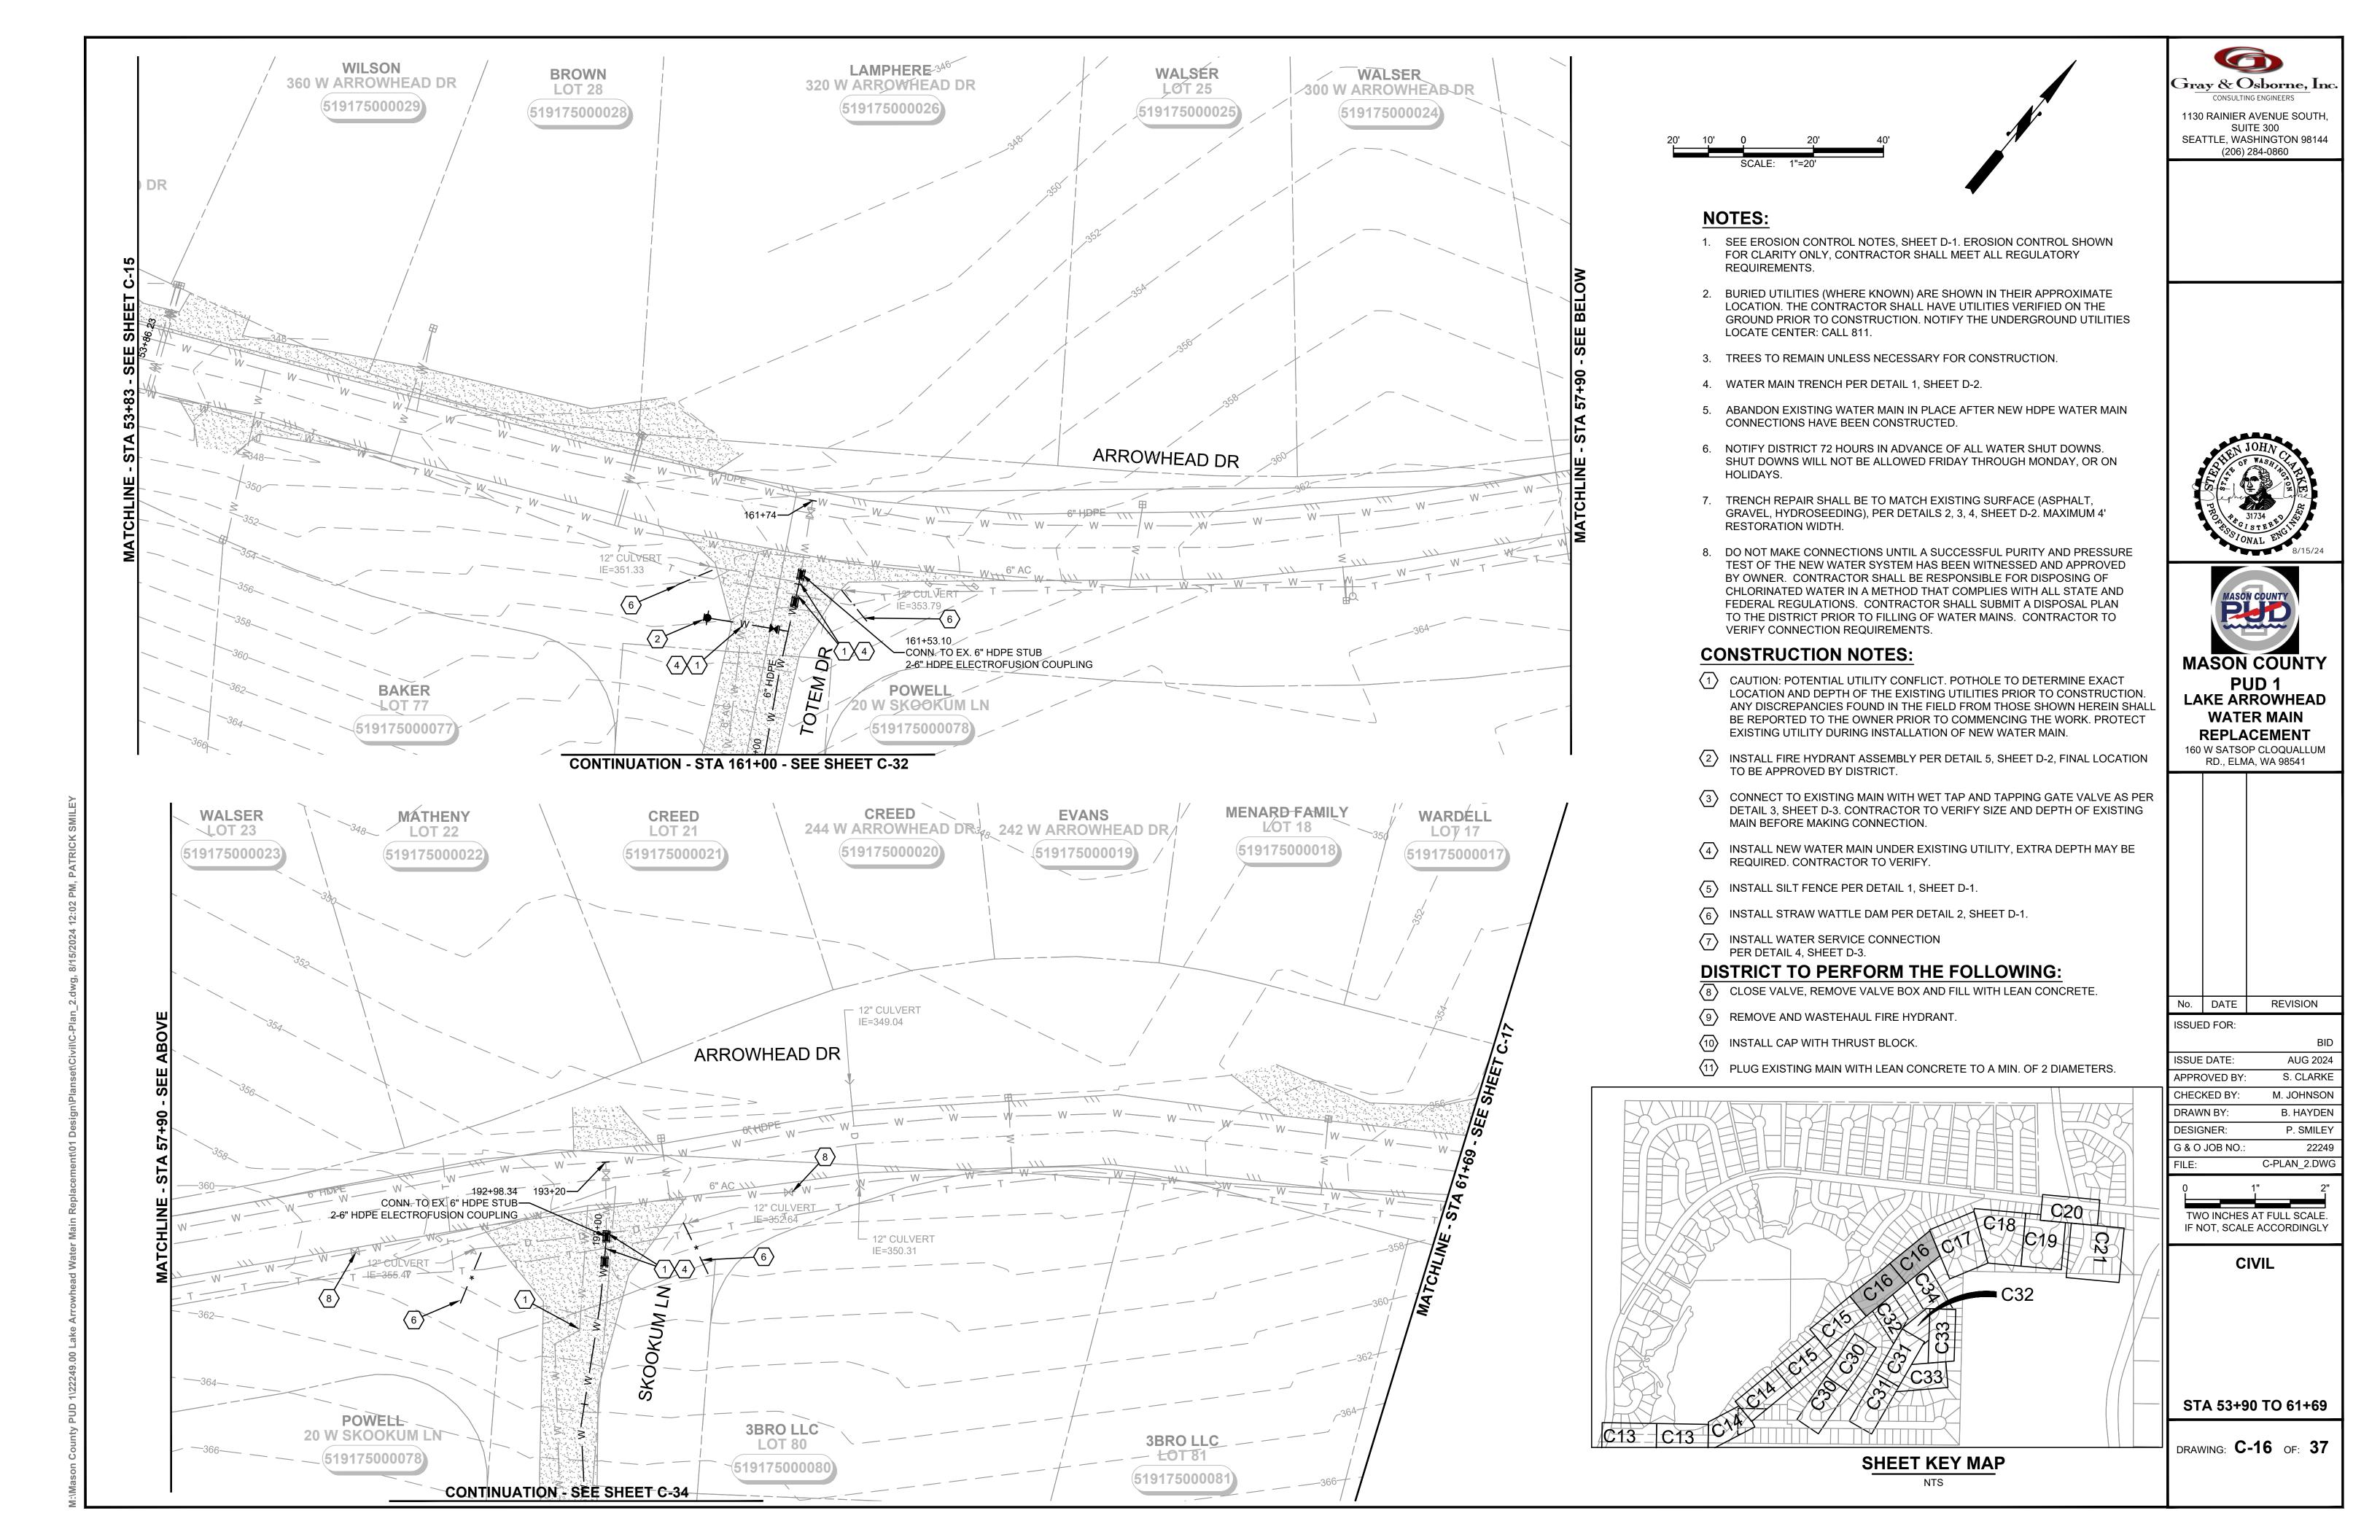

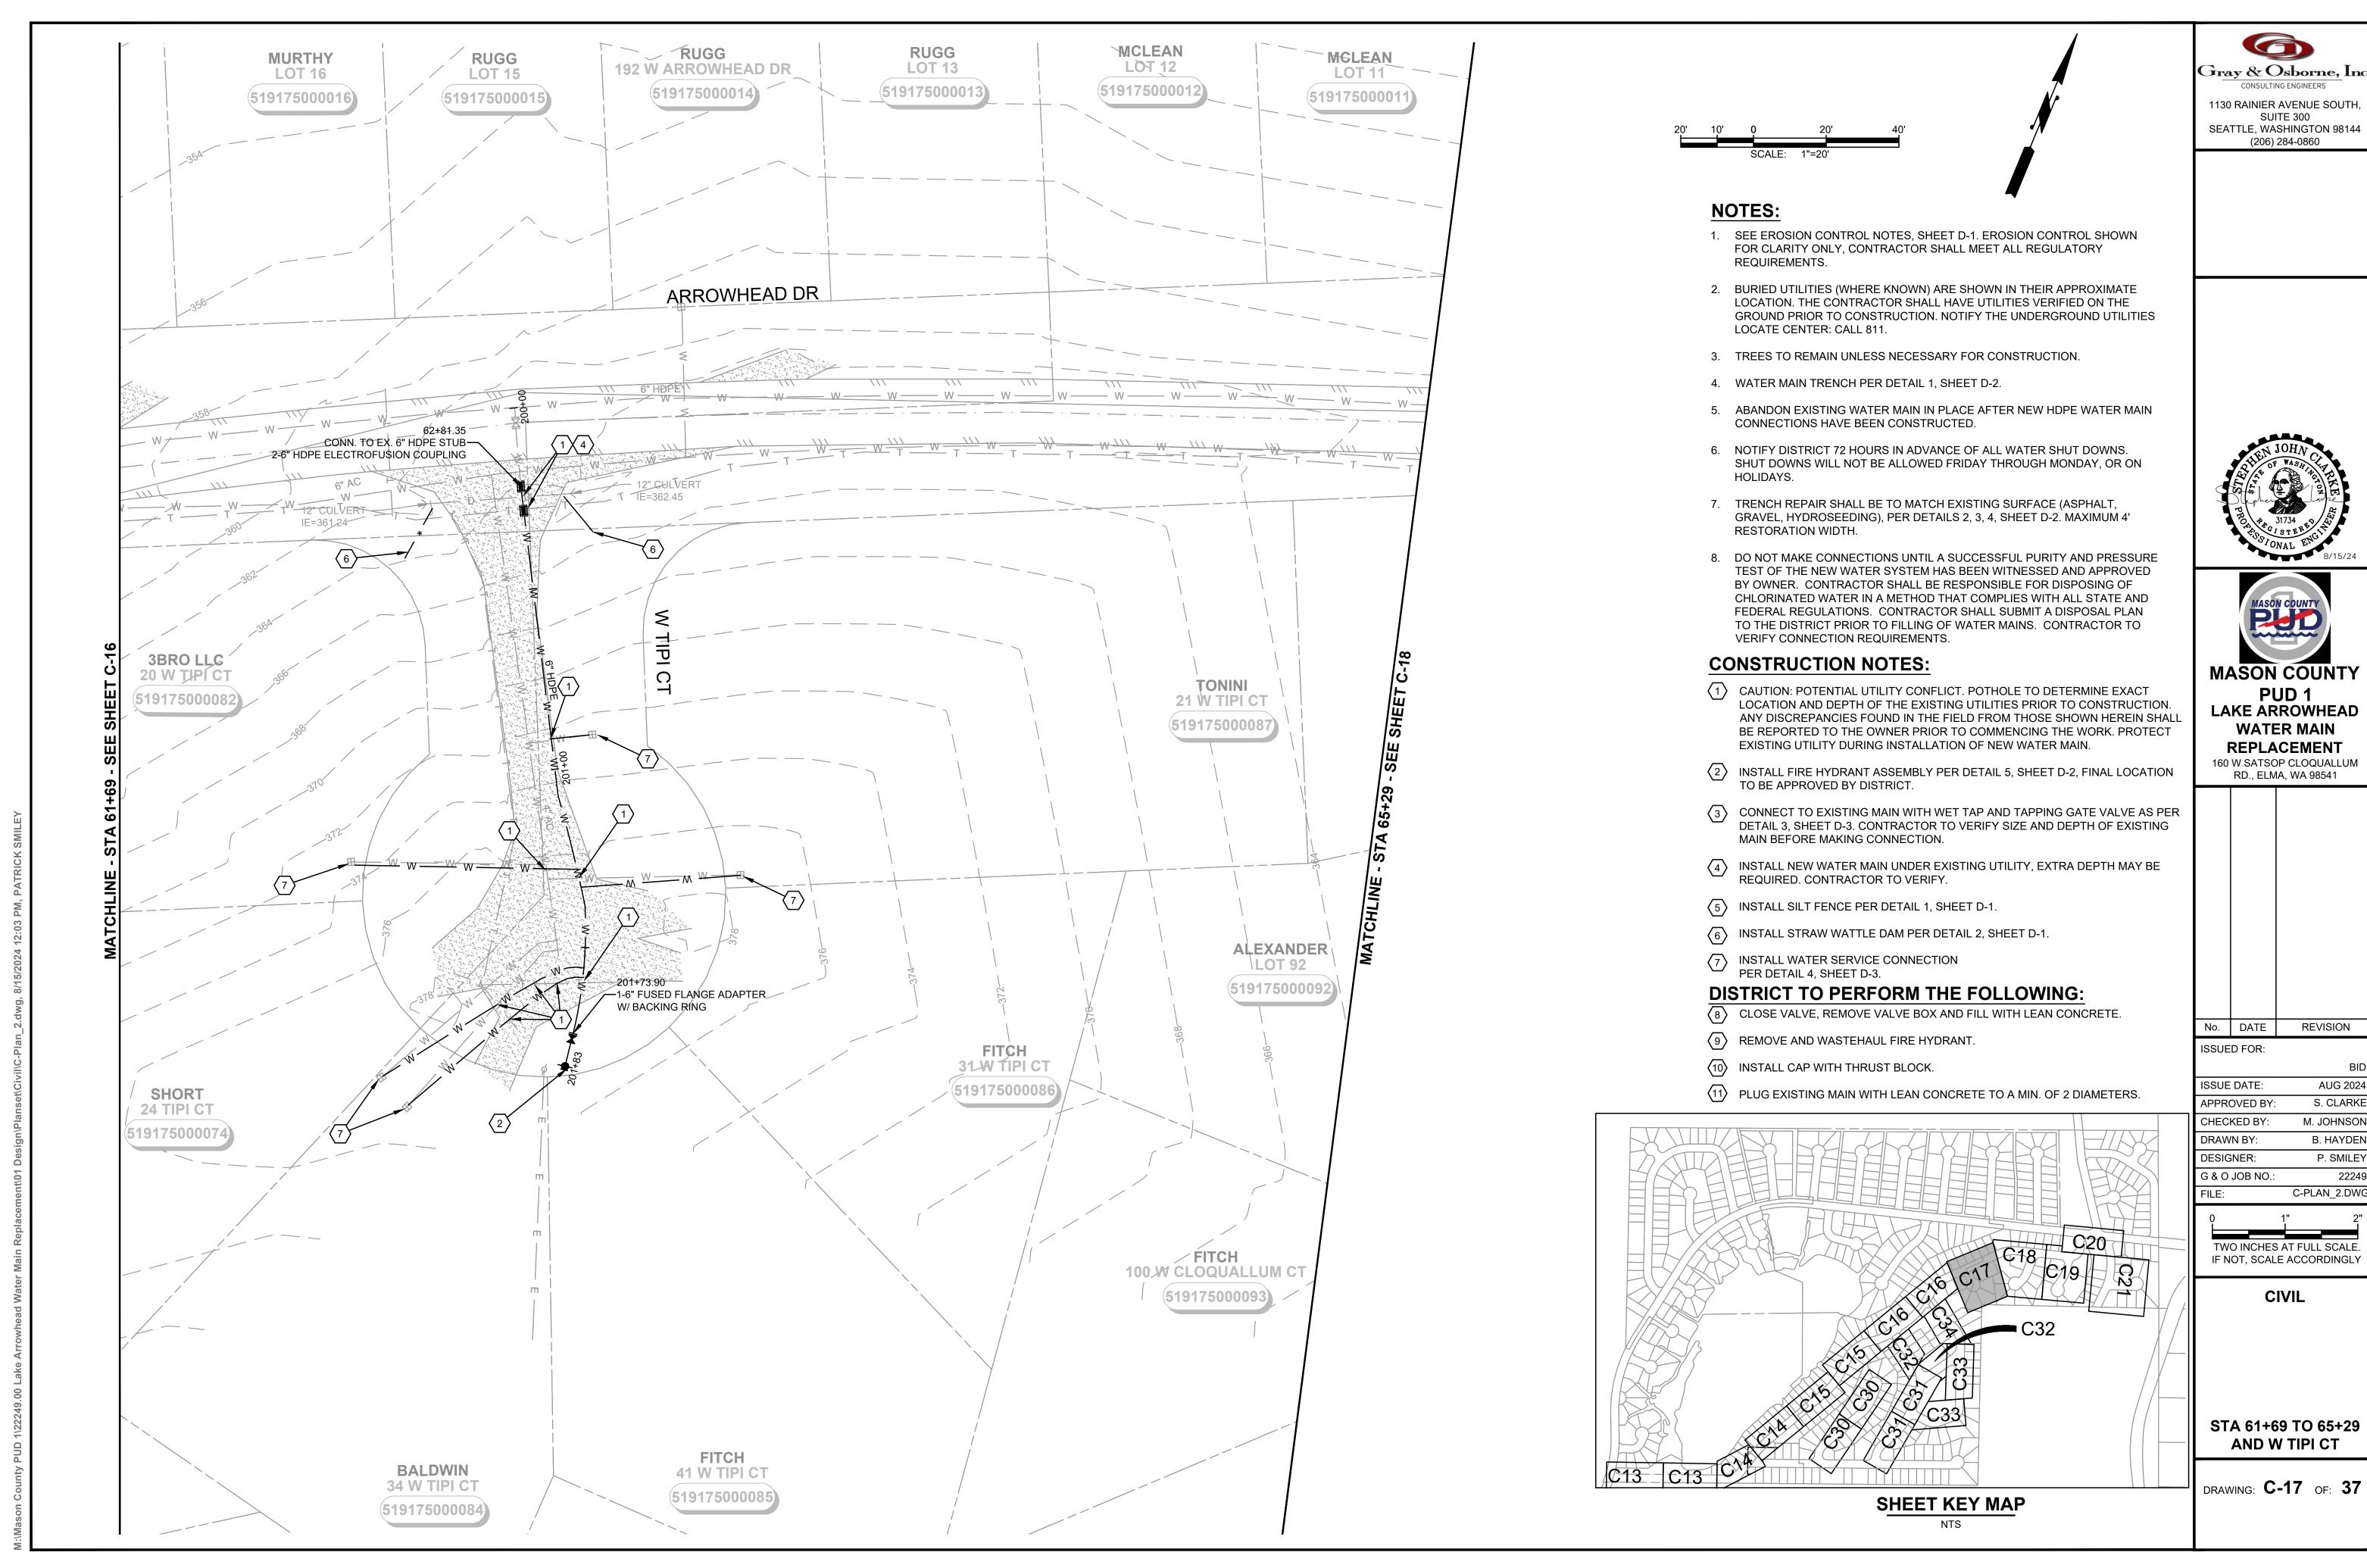

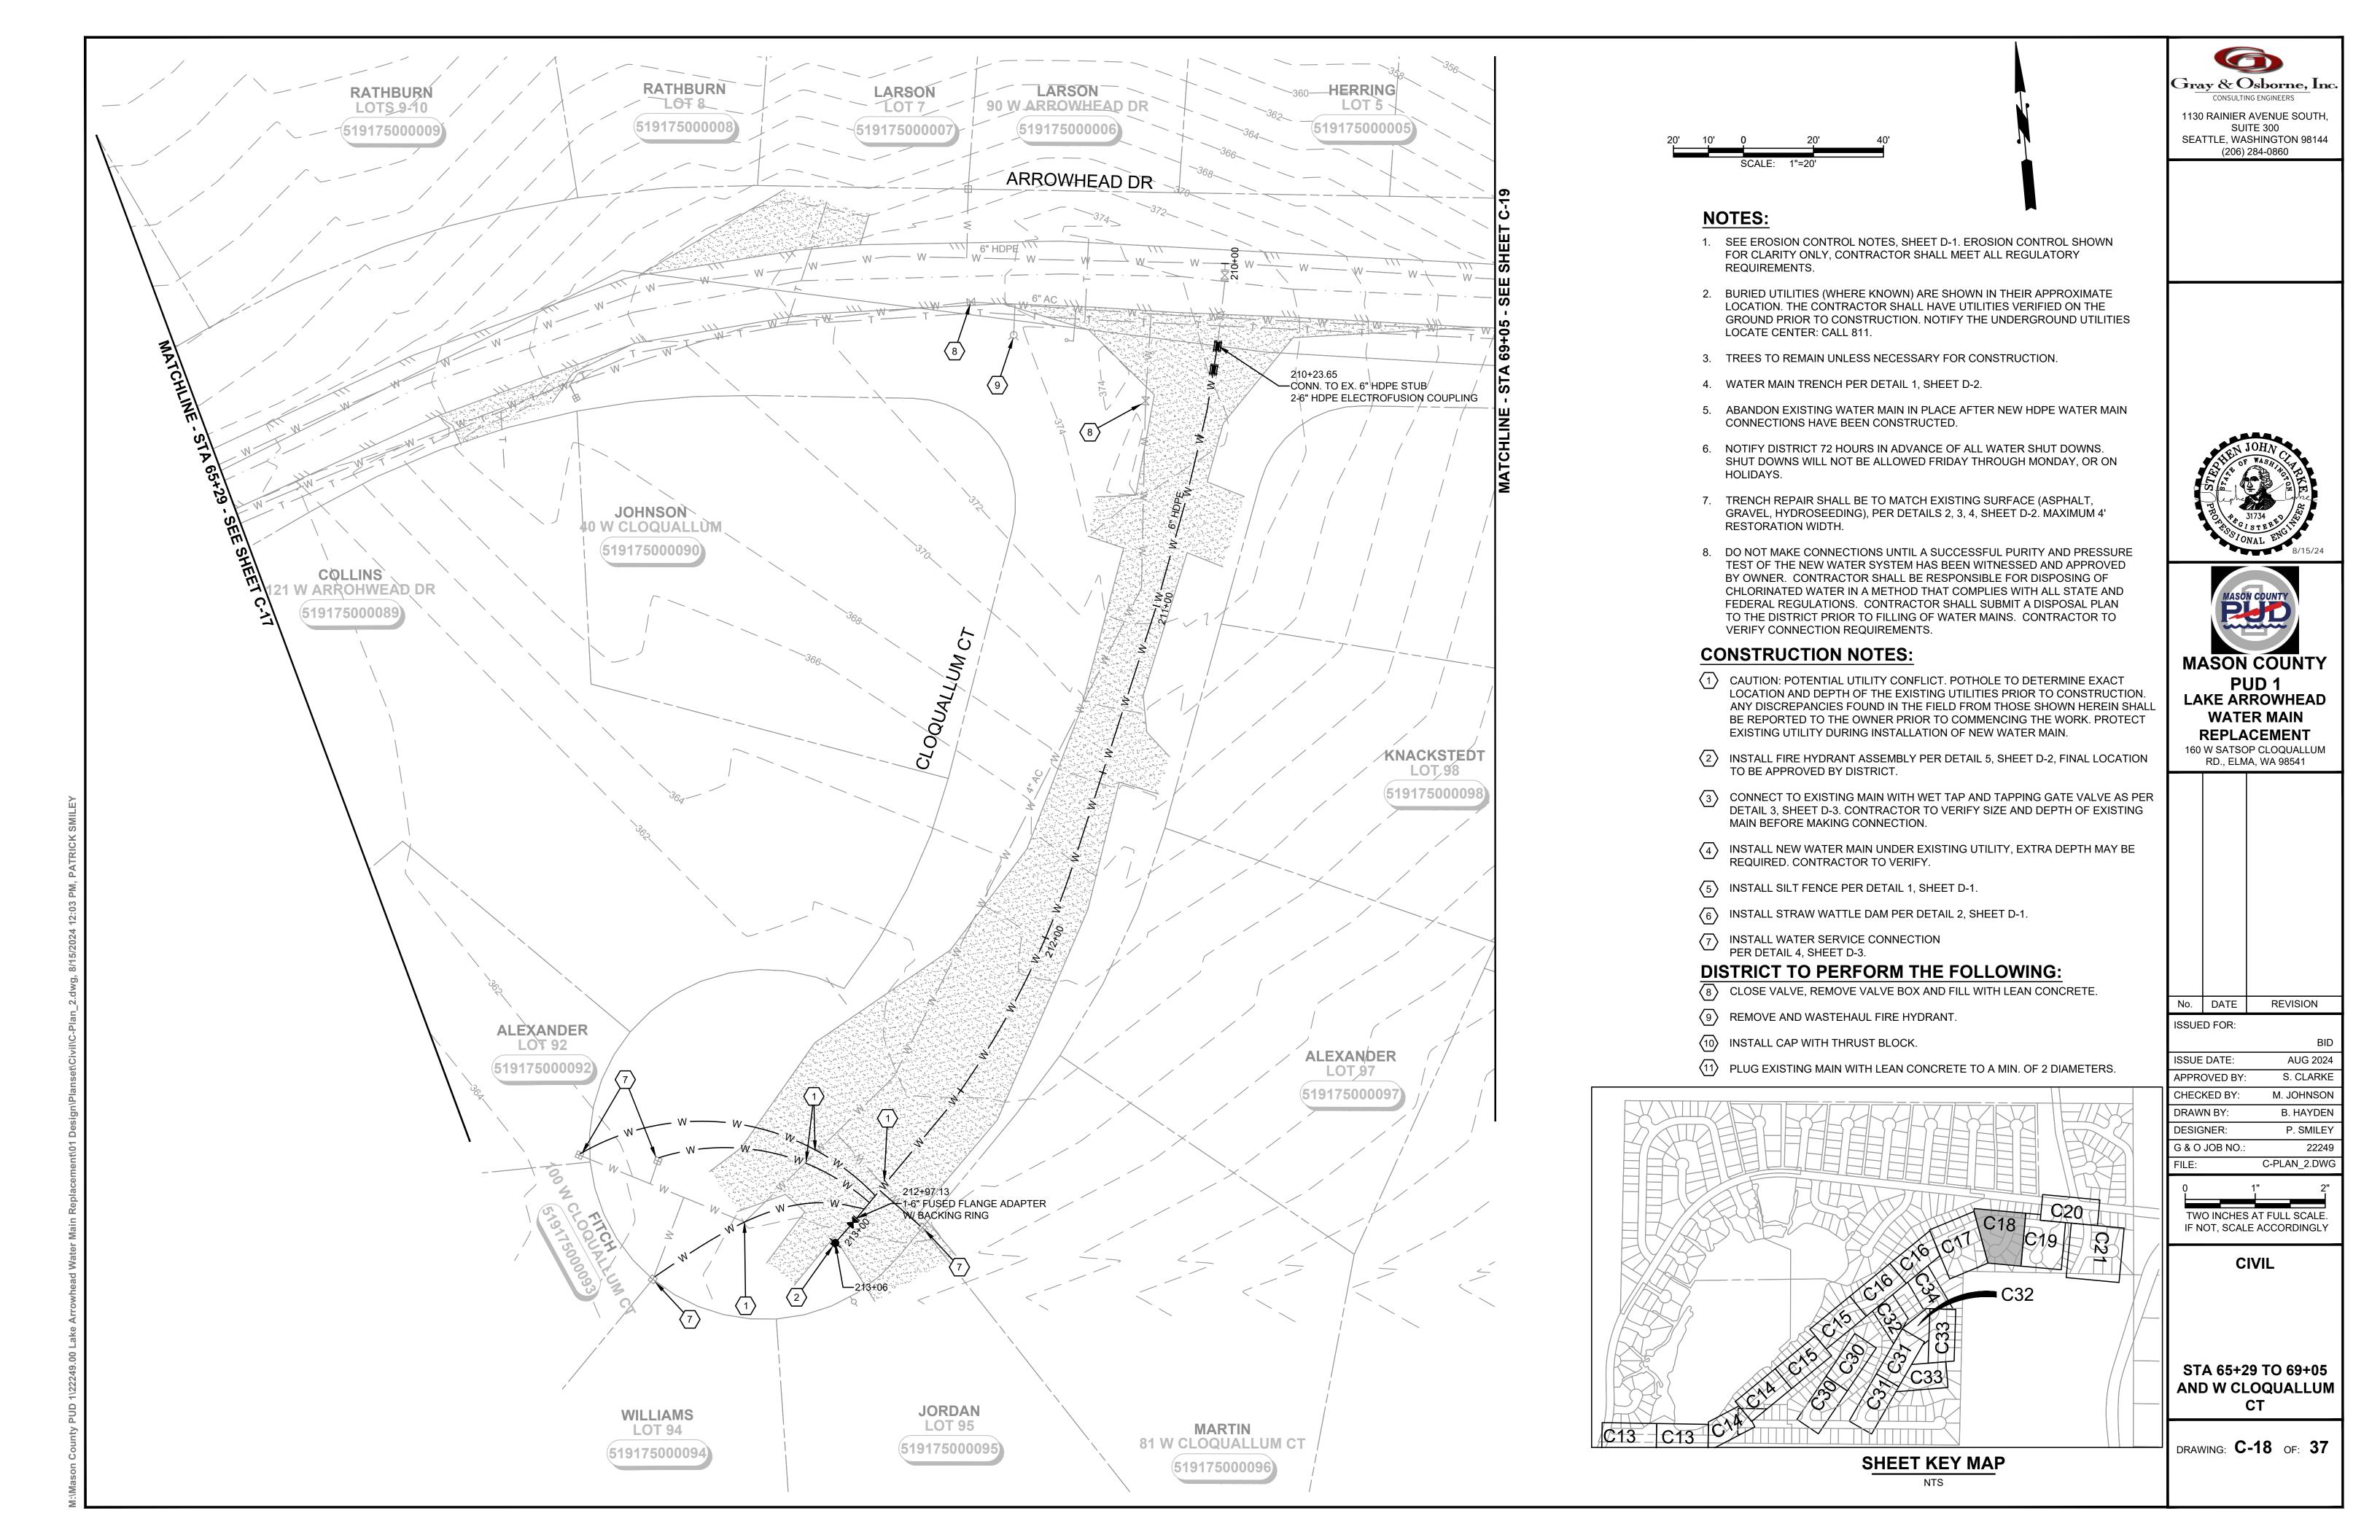

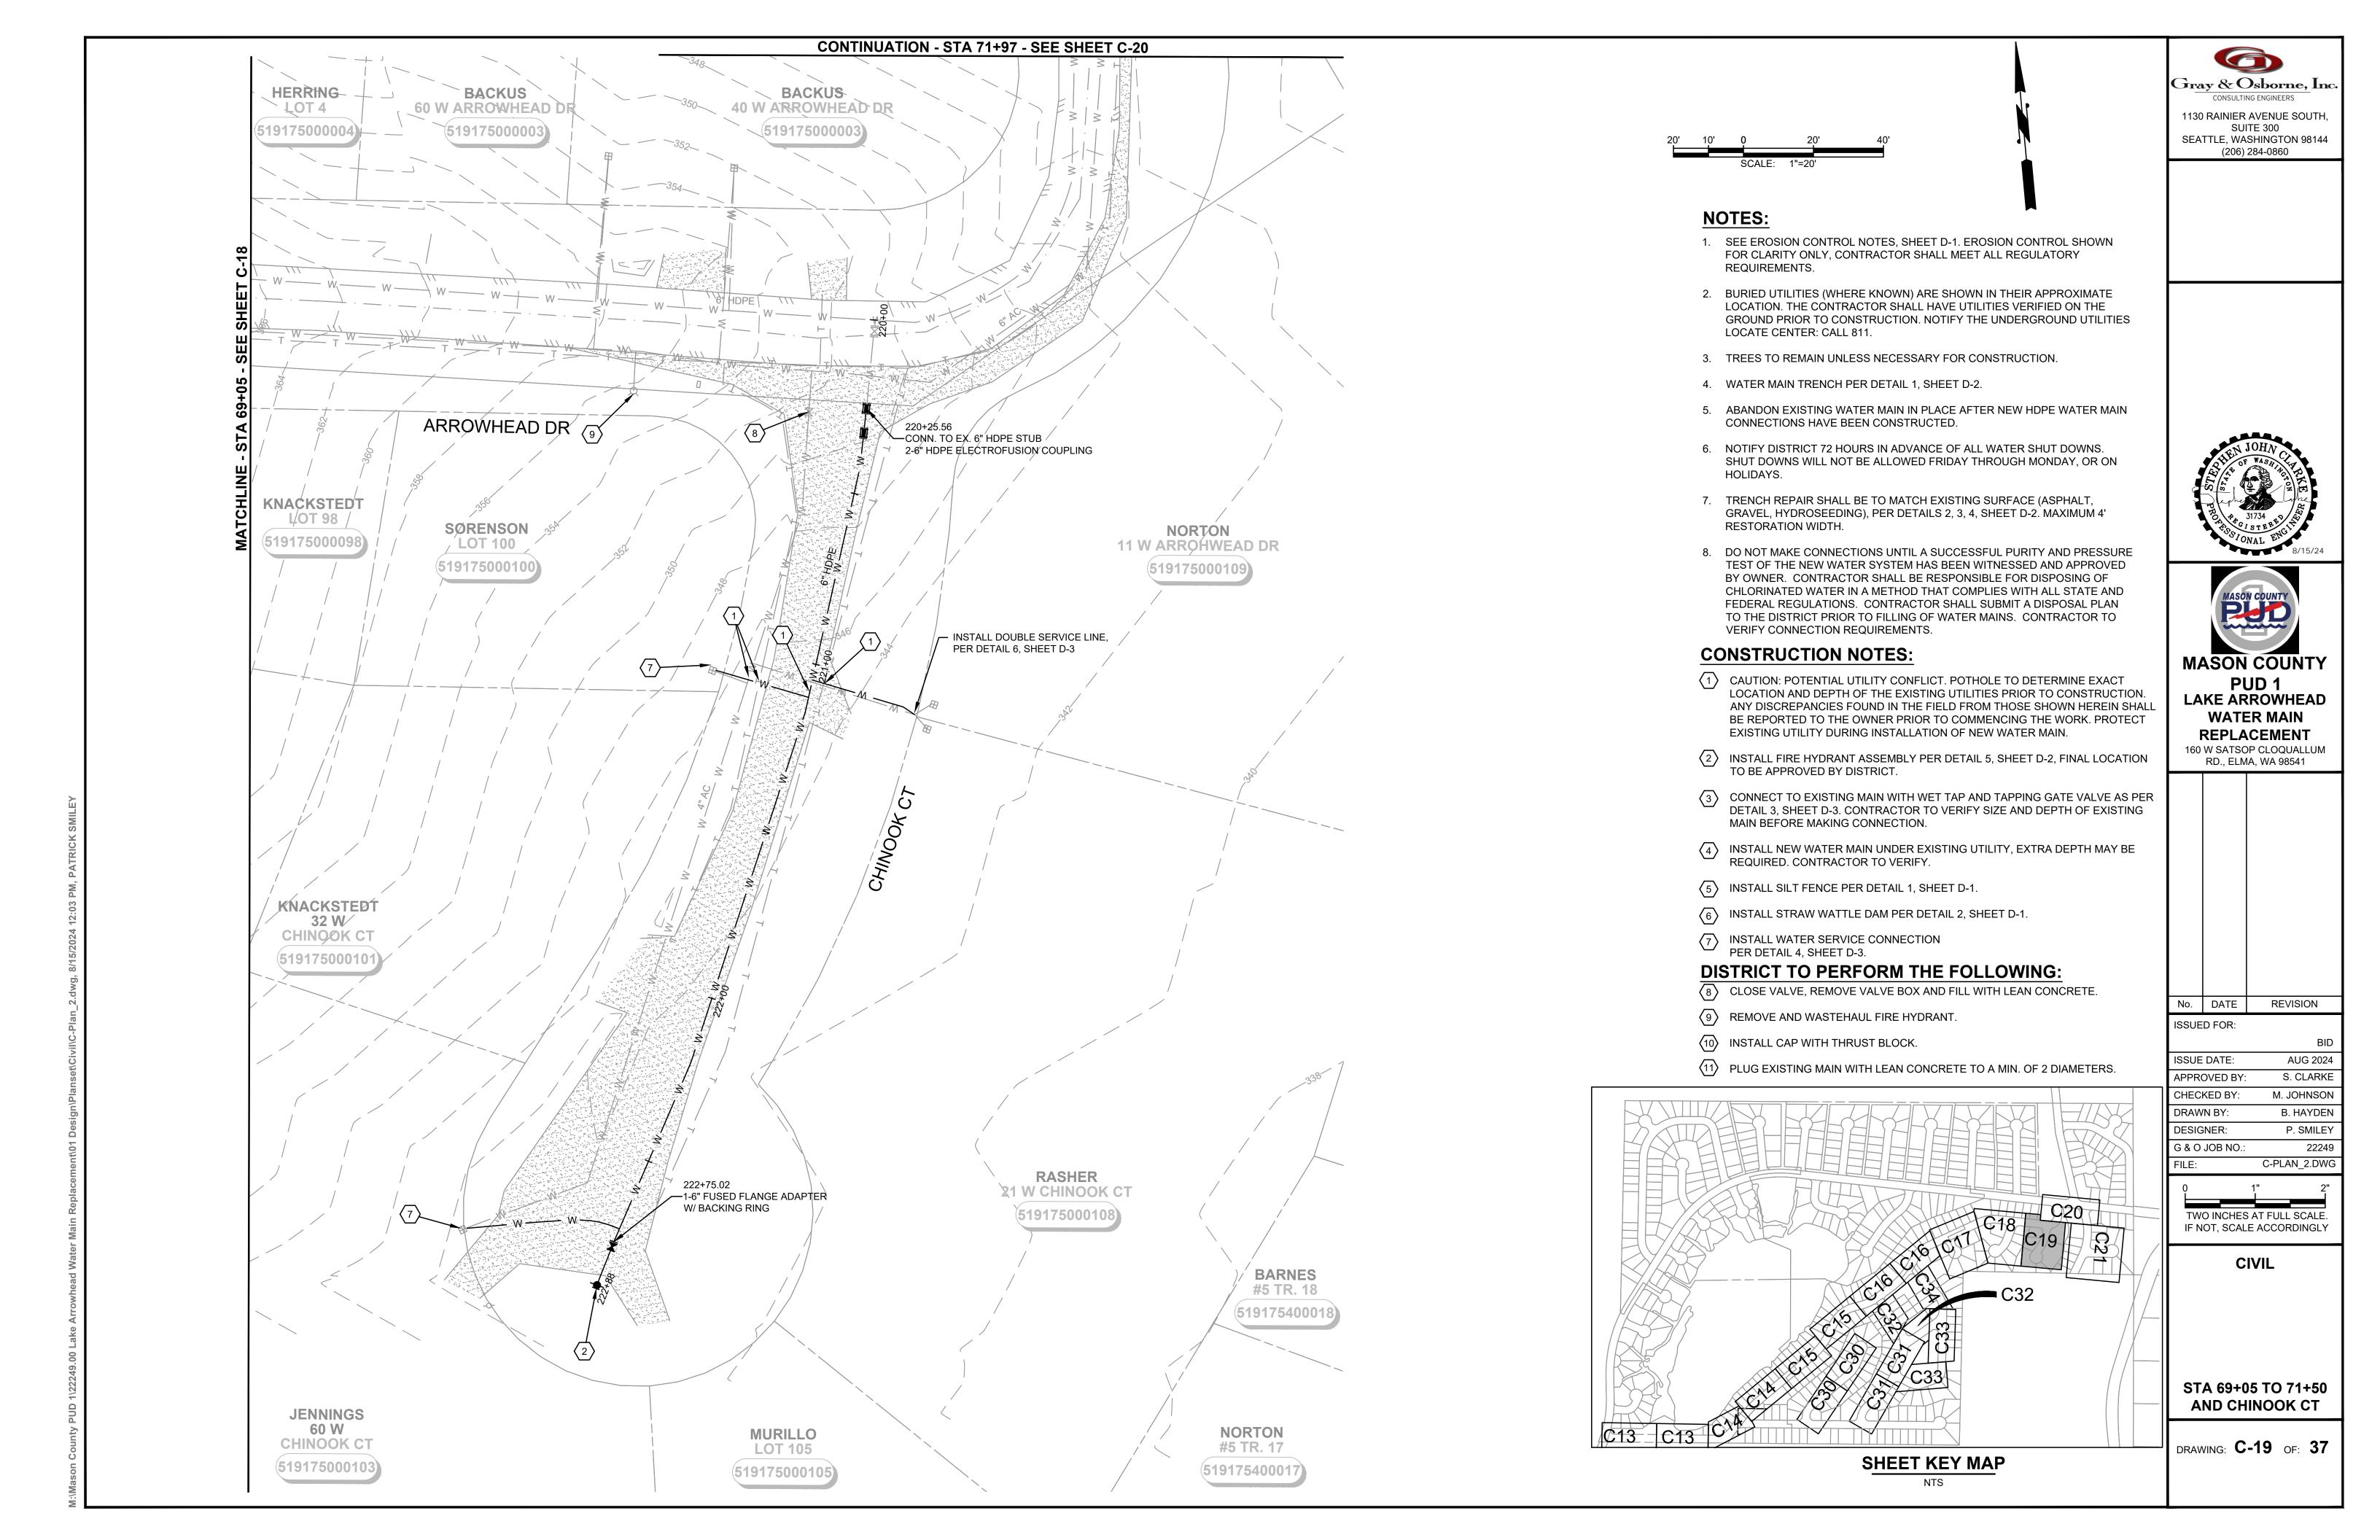


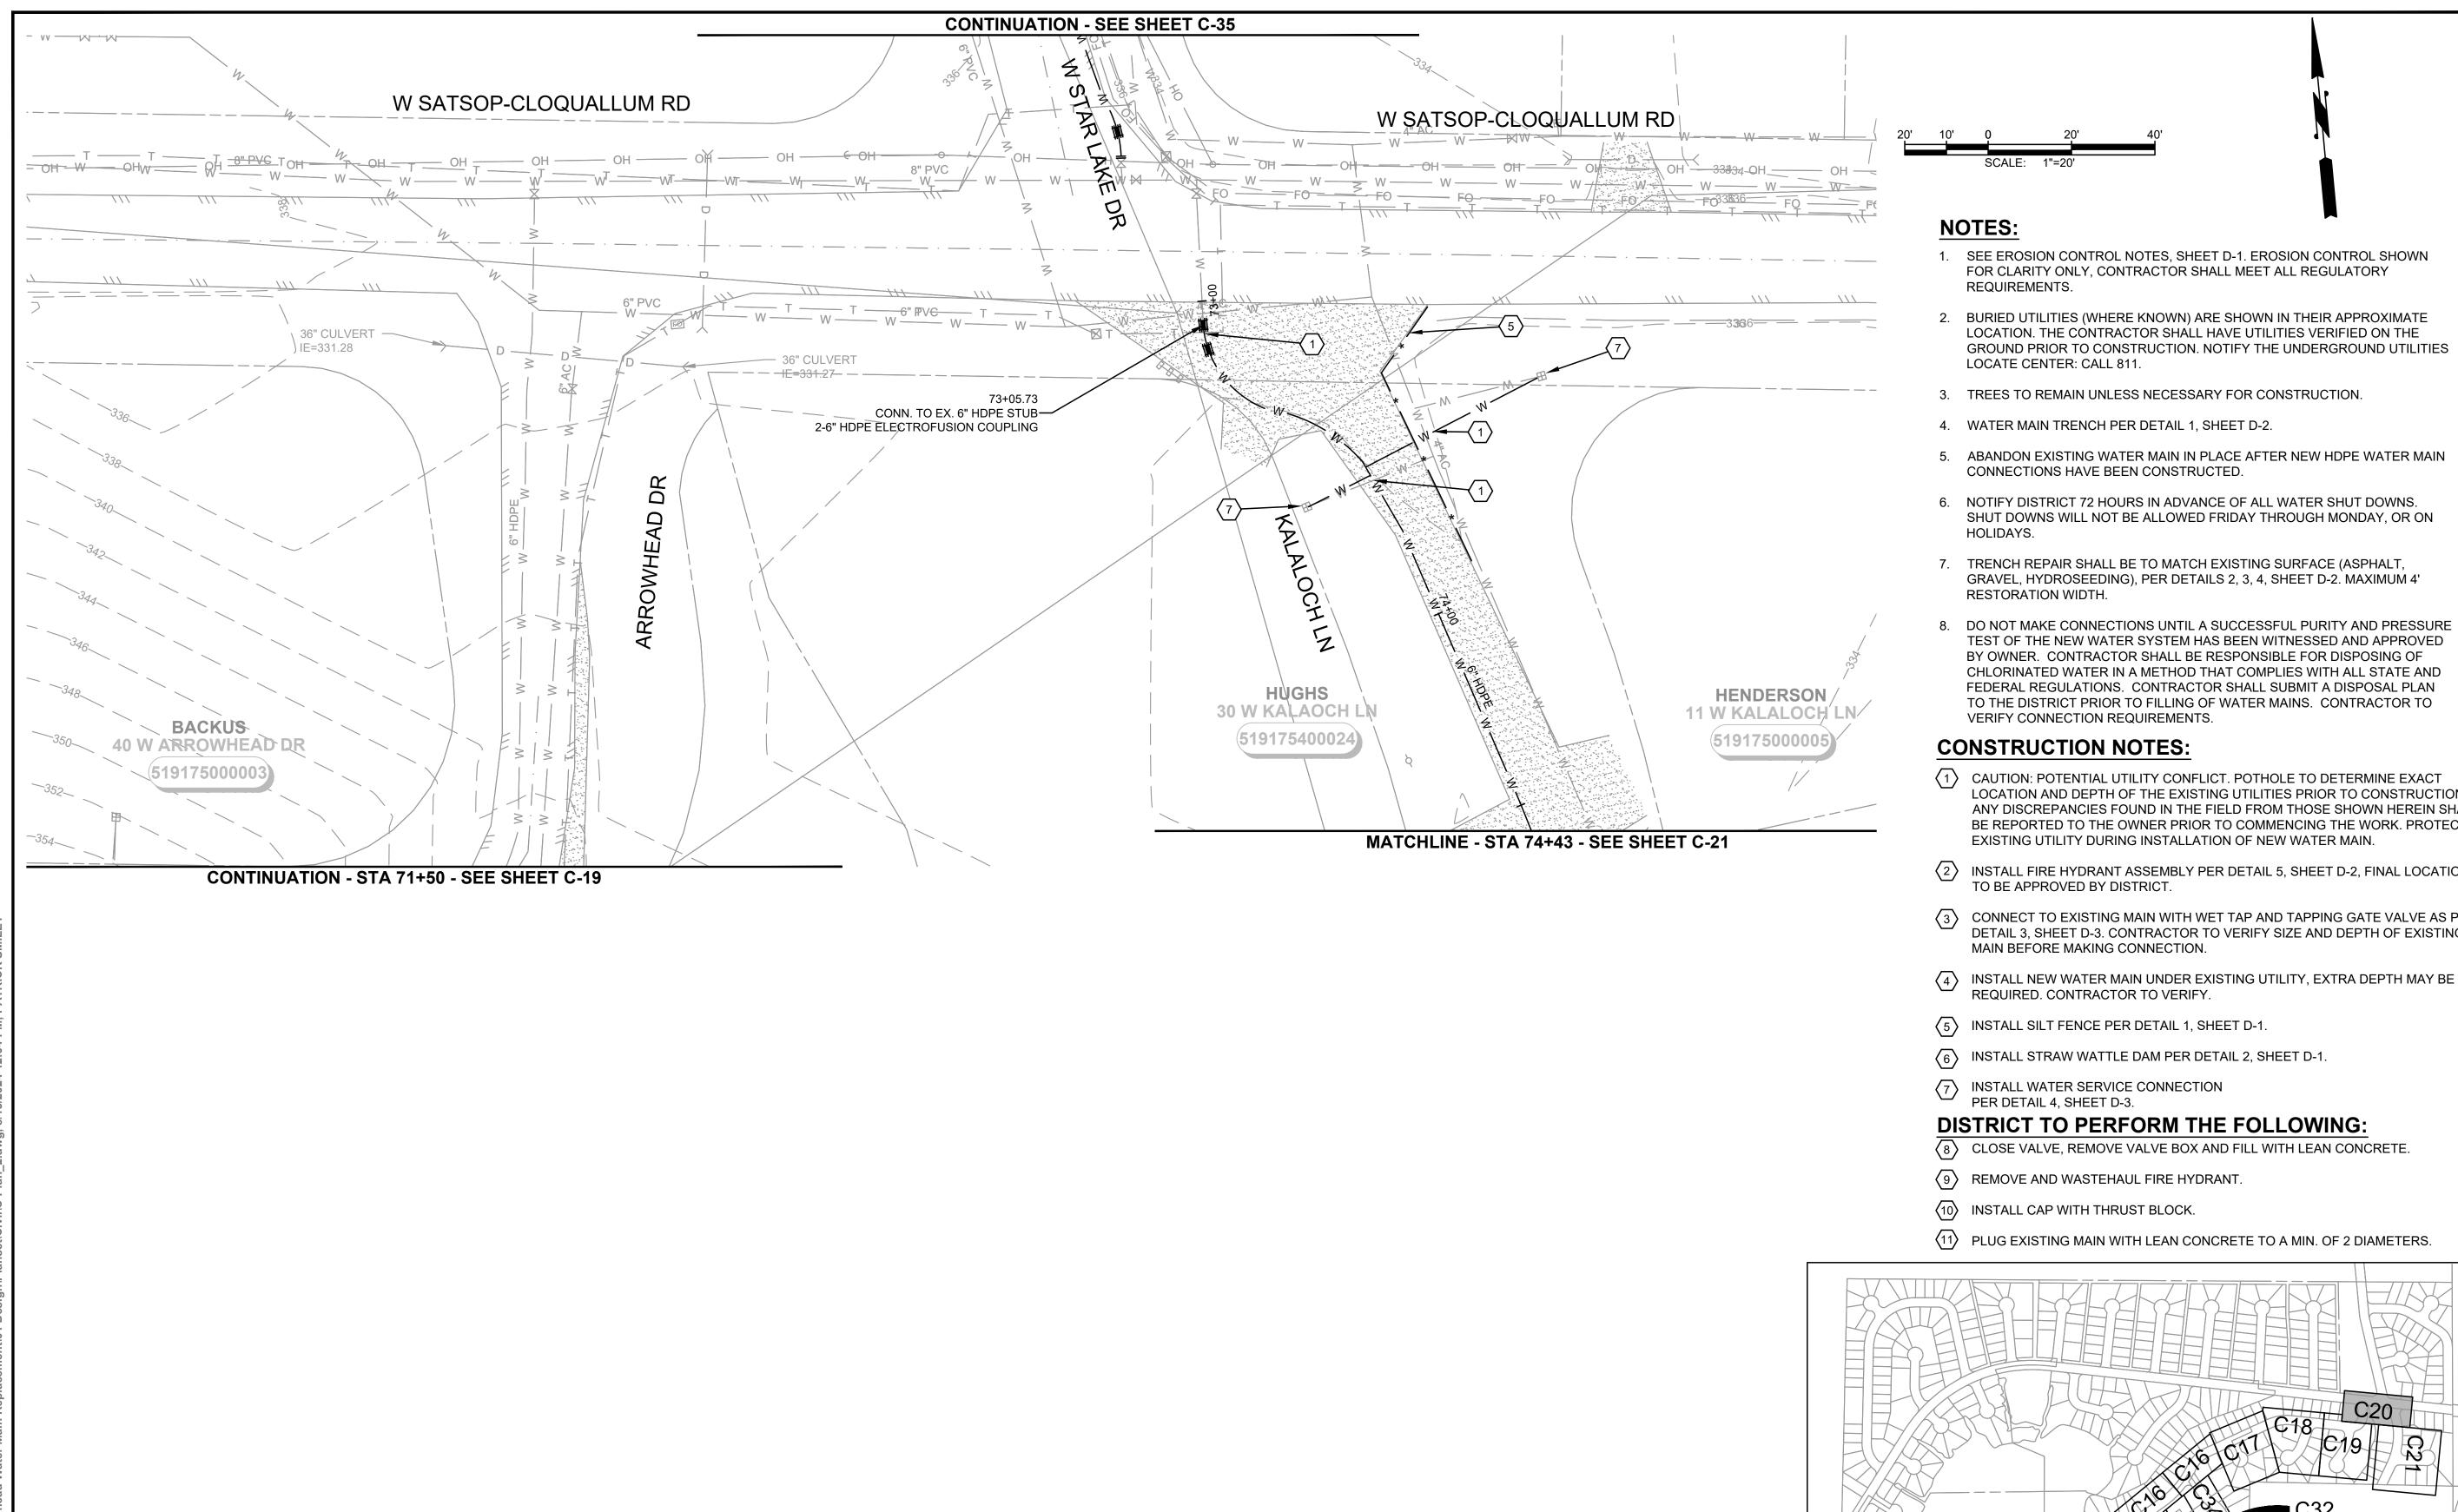




1130 RAINIER AVENUE SOUTH, SUITE 300 SEATTLE, WASHINGTON 98144 (206) 284-0860

- SEE EROSION CONTROL NOTES, SHEET D-1. EROSION CONTROL SHOWN
- LOCATION. THE CONTRACTOR SHALL HAVE UTILITIES VERIFIED ON THE GROUND PRIOR TO CONSTRUCTION. NOTIFY THE UNDERGROUND UTILITIES
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- SHUT DOWNS WILL NOT BE ALLOWED FRIDAY THROUGH MONDAY, OR ON
- GRAVEL, HYDROSEEDING), PER DETAILS 2, 3, 4, SHEET D-2. MAXIMUM 4'
- TEST OF THE NEW WATER SYSTEM HAS BEEN WITNESSED AND APPROVED BY OWNER. CONTRACTOR SHALL BE RESPONSIBLE FOR DISPOSING OF CHLORINATED WATER IN A METHOD THAT COMPLIES WITH ALL STATE AND FEDERAL REGULATIONS. CONTRACTOR SHALL SUBMIT A DISPOSAL PLAN TO THE DISTRICT PRIOR TO FILLING OF WATER MAINS. CONTRACTOR TO
- LOCATION AND DEPTH OF THE EXISTING UTILITIES PRIOR TO CONSTRUCTION. ANY DISCREPANCIES FOUND IN THE FIELD FROM THOSE SHOWN HEREIN SHALL BE REPORTED TO THE OWNER PRIOR TO COMMENCING THE WORK. PROTECT
- 2 INSTALL FIRE HYDRANT ASSEMBLY PER DETAIL 5, SHEET D-2, FINAL LOCATION
- (3) CONNECT TO EXISTING MAIN WITH WET TAP AND TAPPING GATE VALVE AS PER DETAIL 3, SHEET D-3. CONTRACTOR TO VERIFY SIZE AND DEPTH OF EXISTING

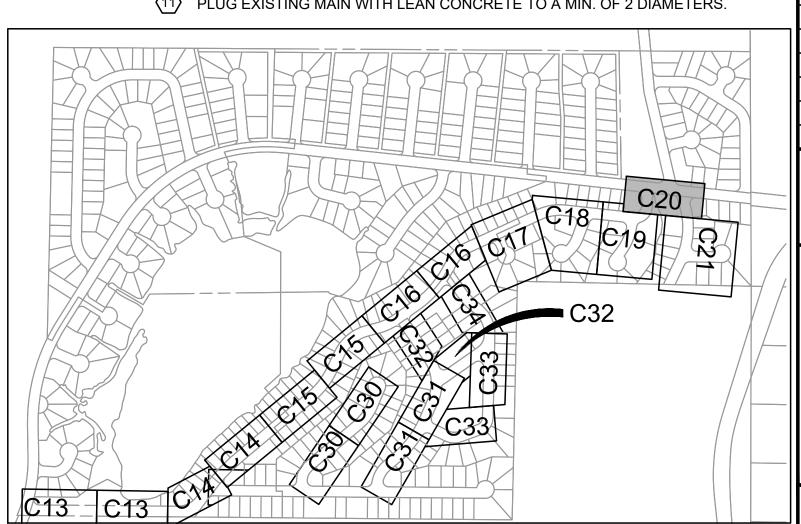

SHEET KEY MAP

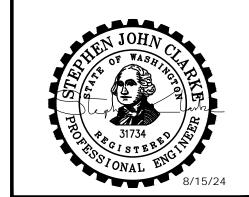



160 W SATSOP CLOQUALLUM RD., ELMA, WA 98541

REVISION

No. DATE

ISSUED FOR: ISSUE DATE: AUG 2024

APPROVED BY: S. CLARKE M. JOHNSON CHECKED BY: DRAWN BY: B. HAYDEN P. SMILEY DESIGNER: G & O JOB NO.:


> TWO INCHES AT FULL SCALE IF NOT, SCALE ACCORDINGLY


C-PLAN\_2.DWG


CIVIL


STA 71+50 TO 72+90 AND KALOCH LN


DRAWING: **C-20** OF: **37** 

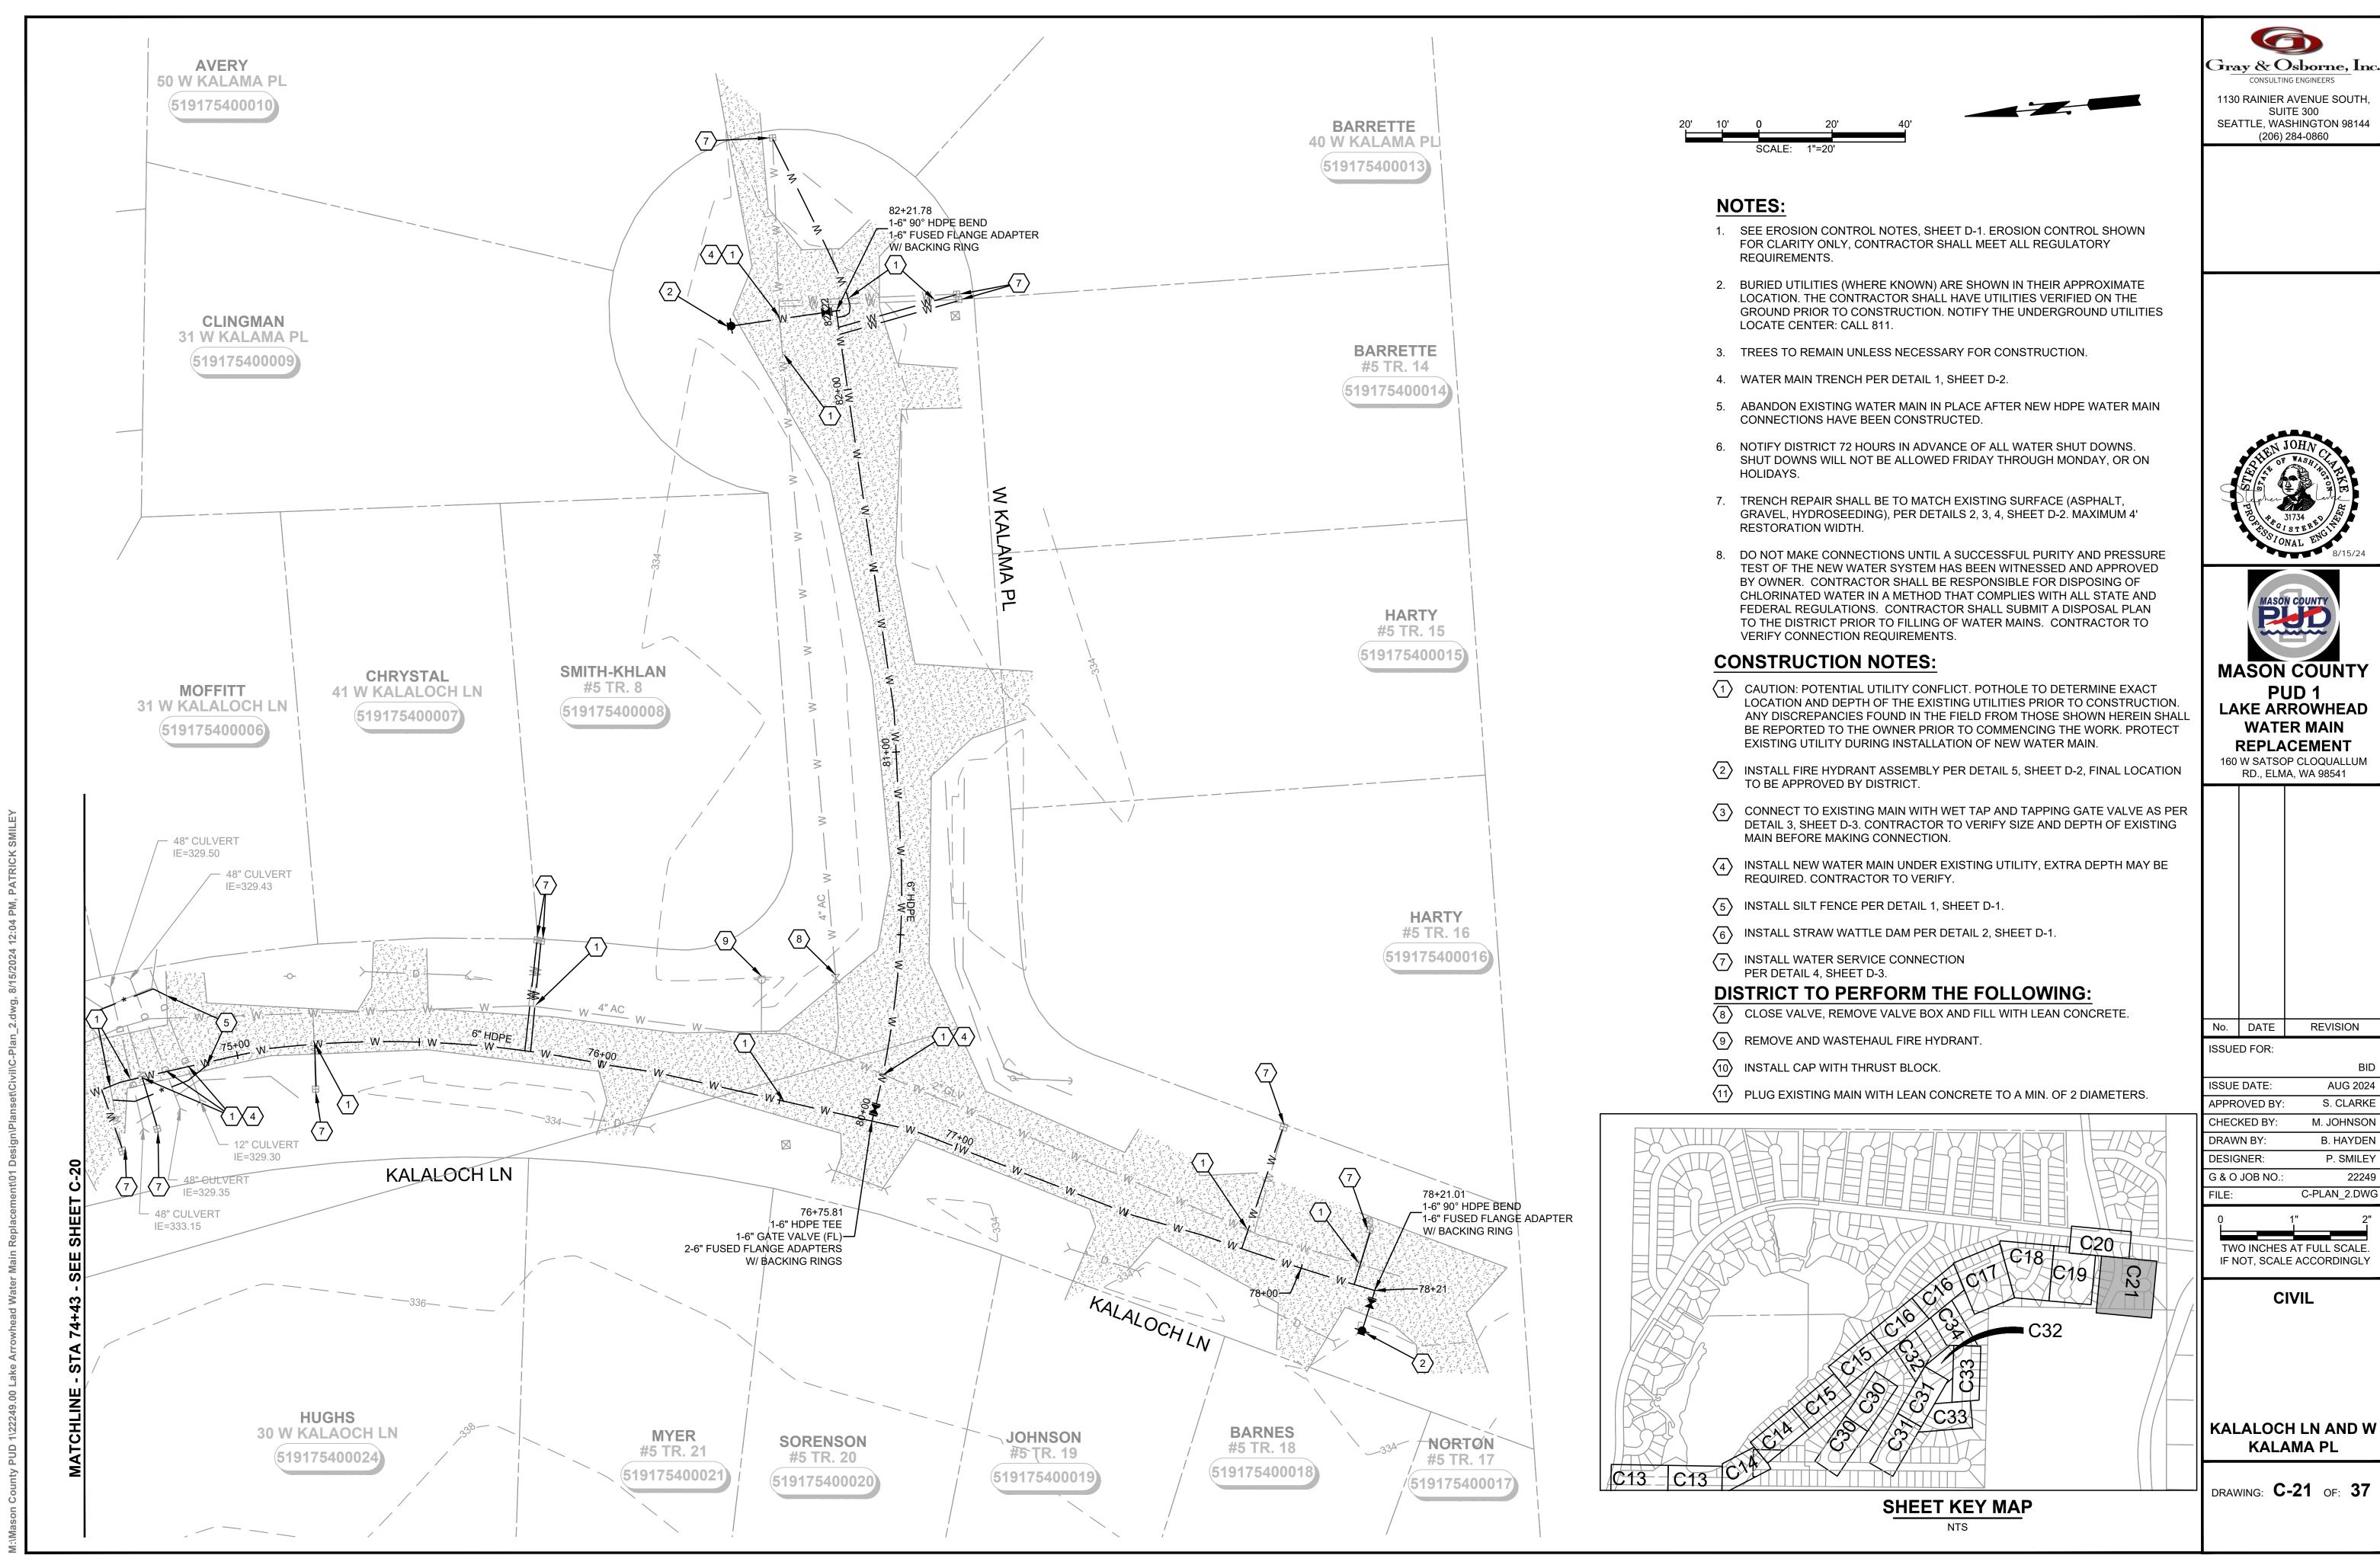


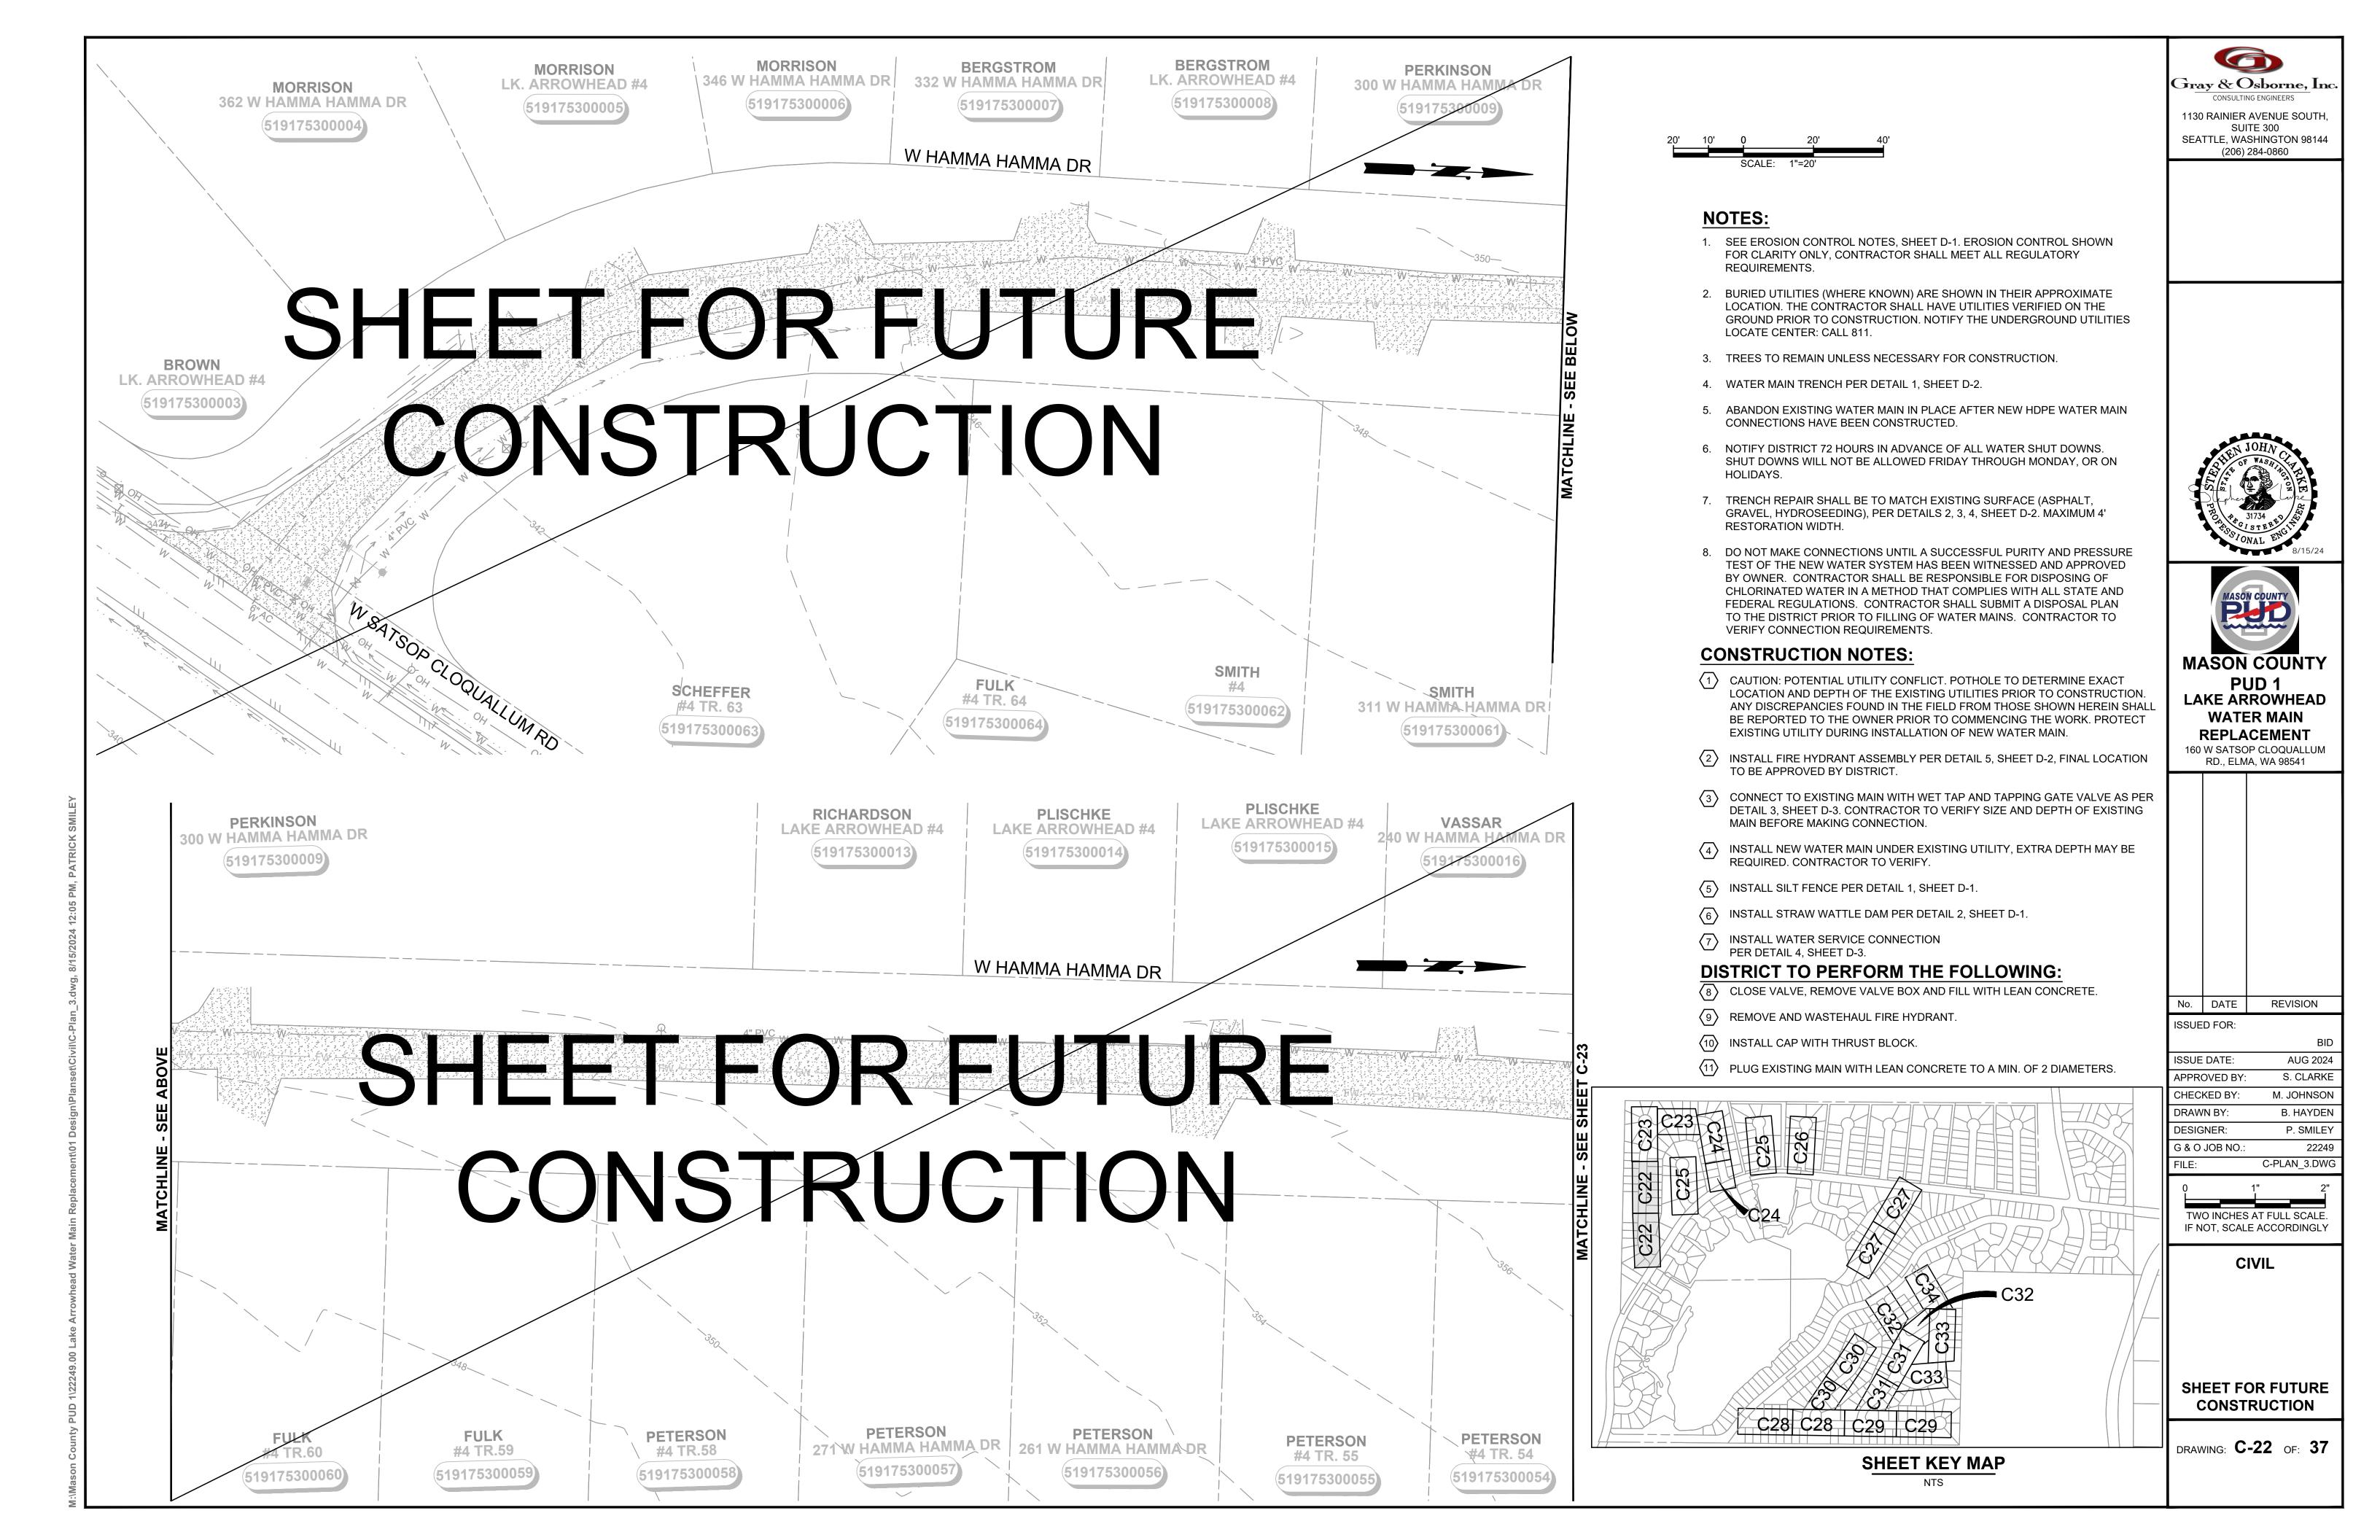

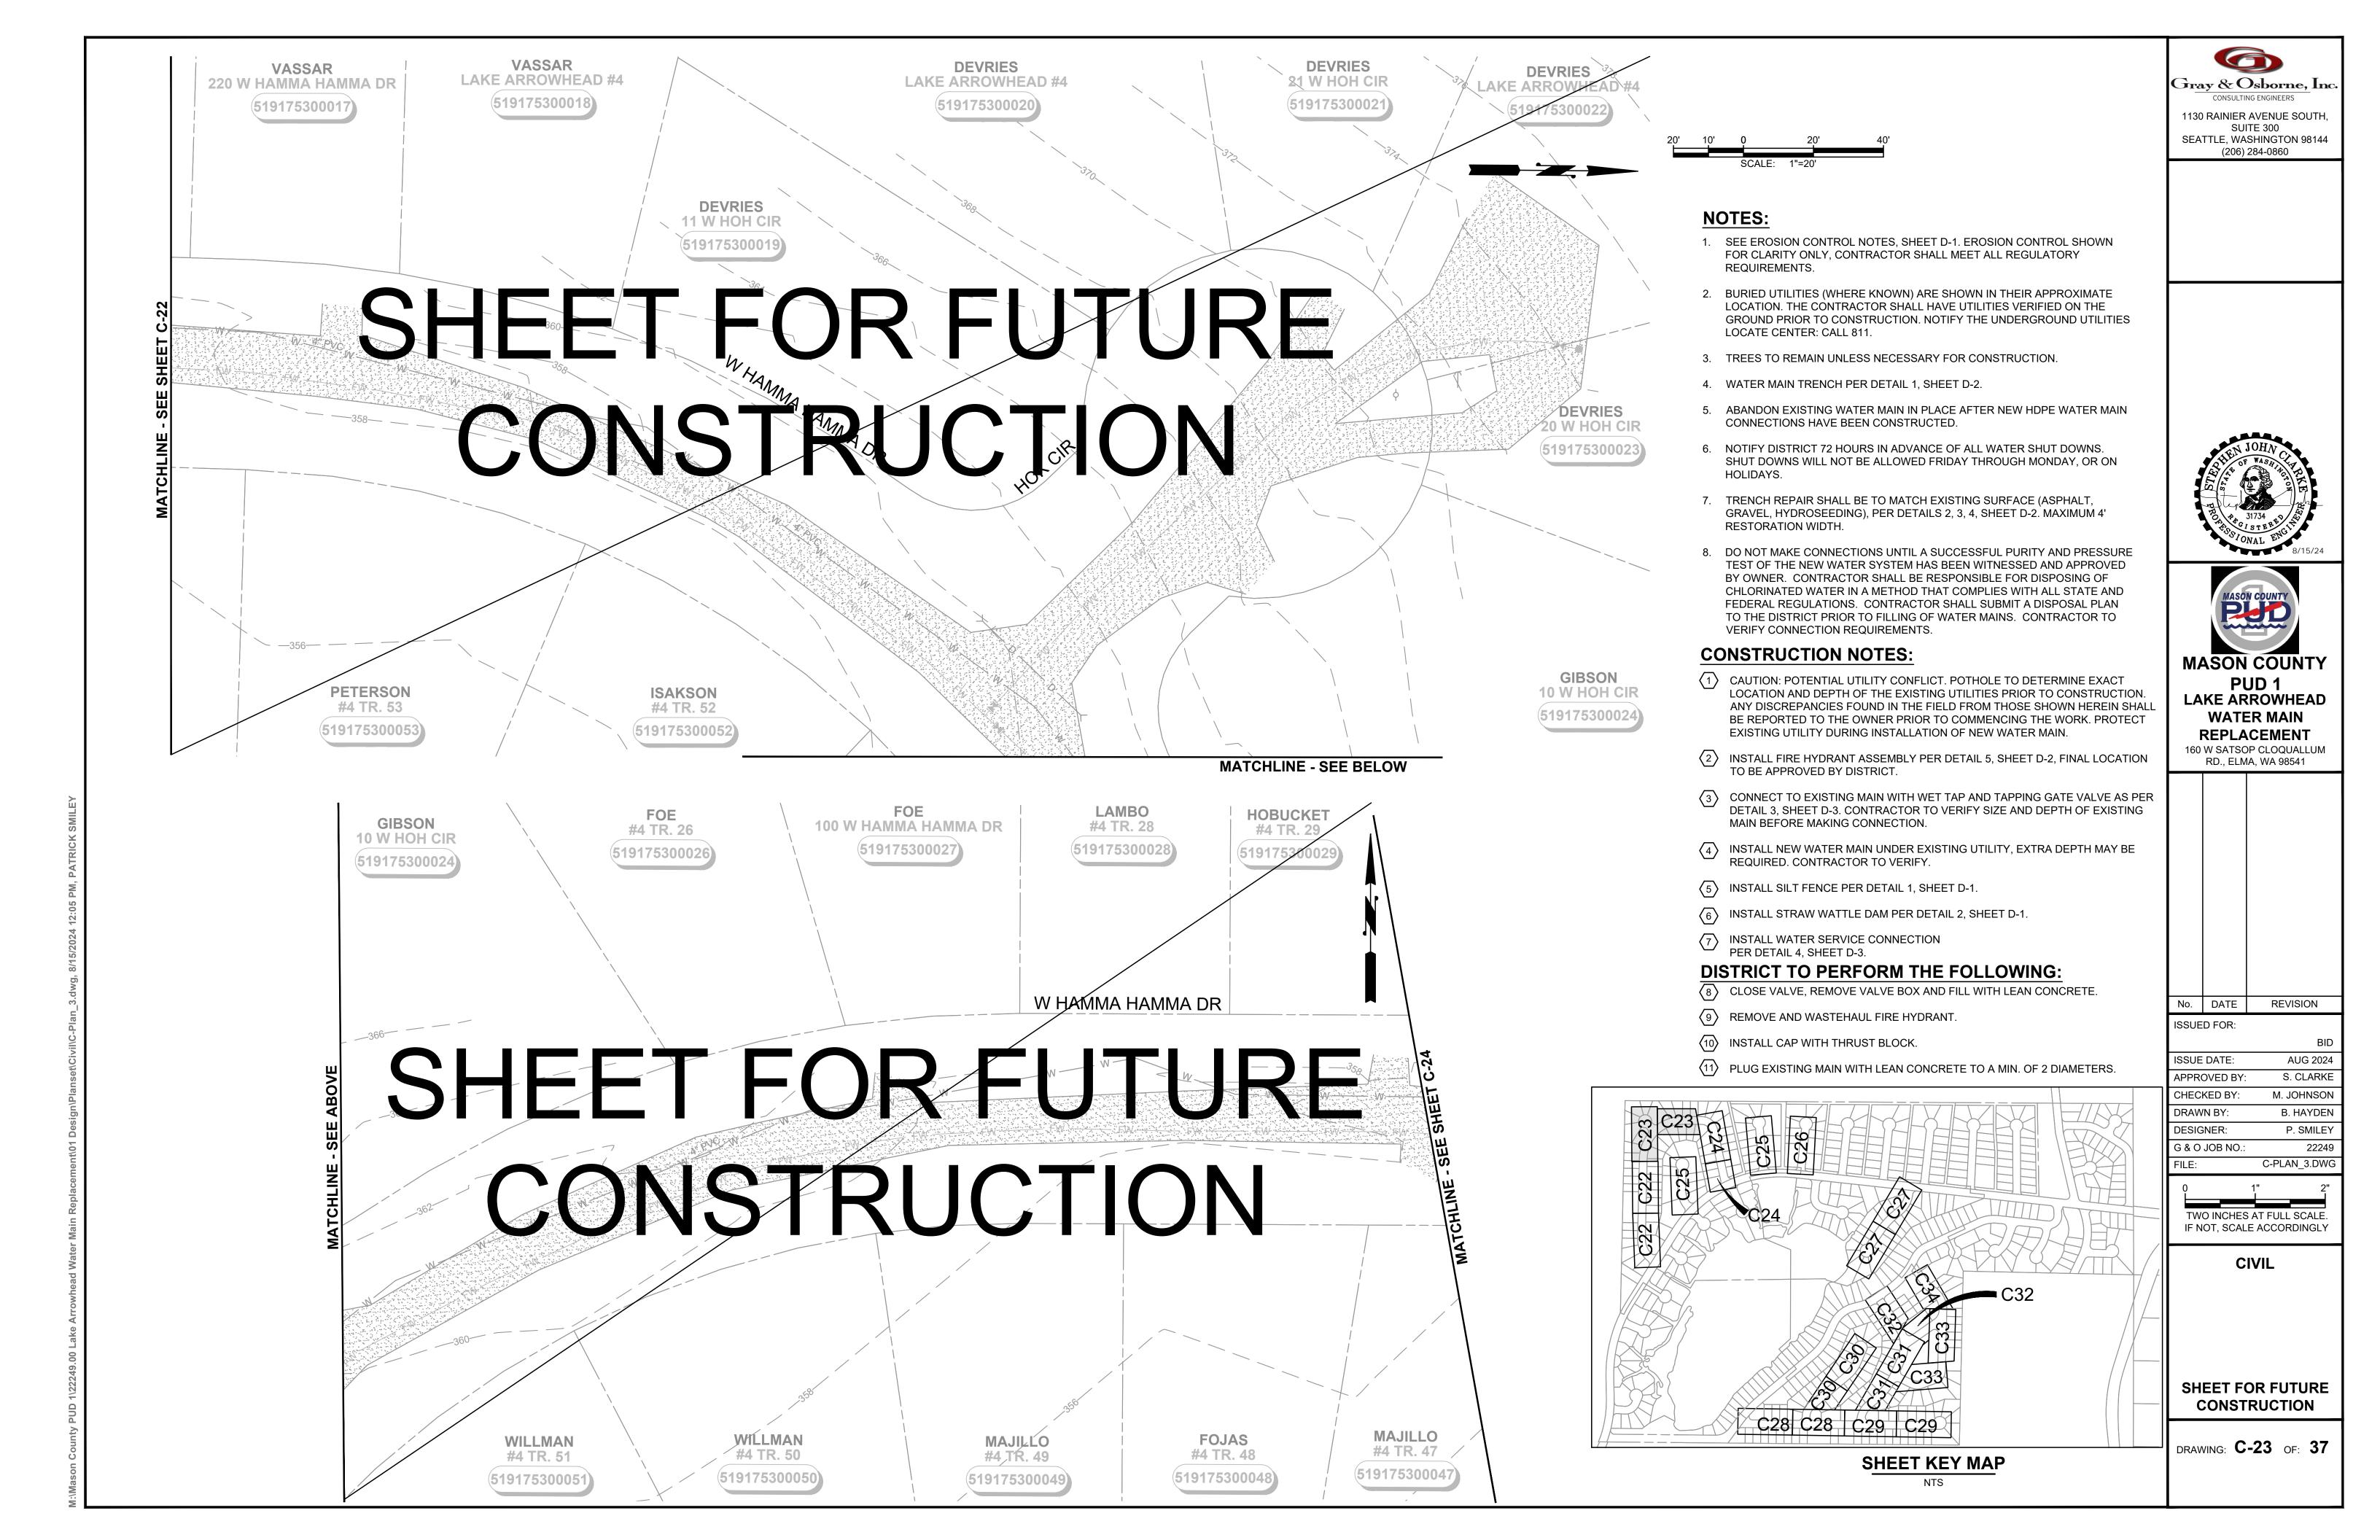

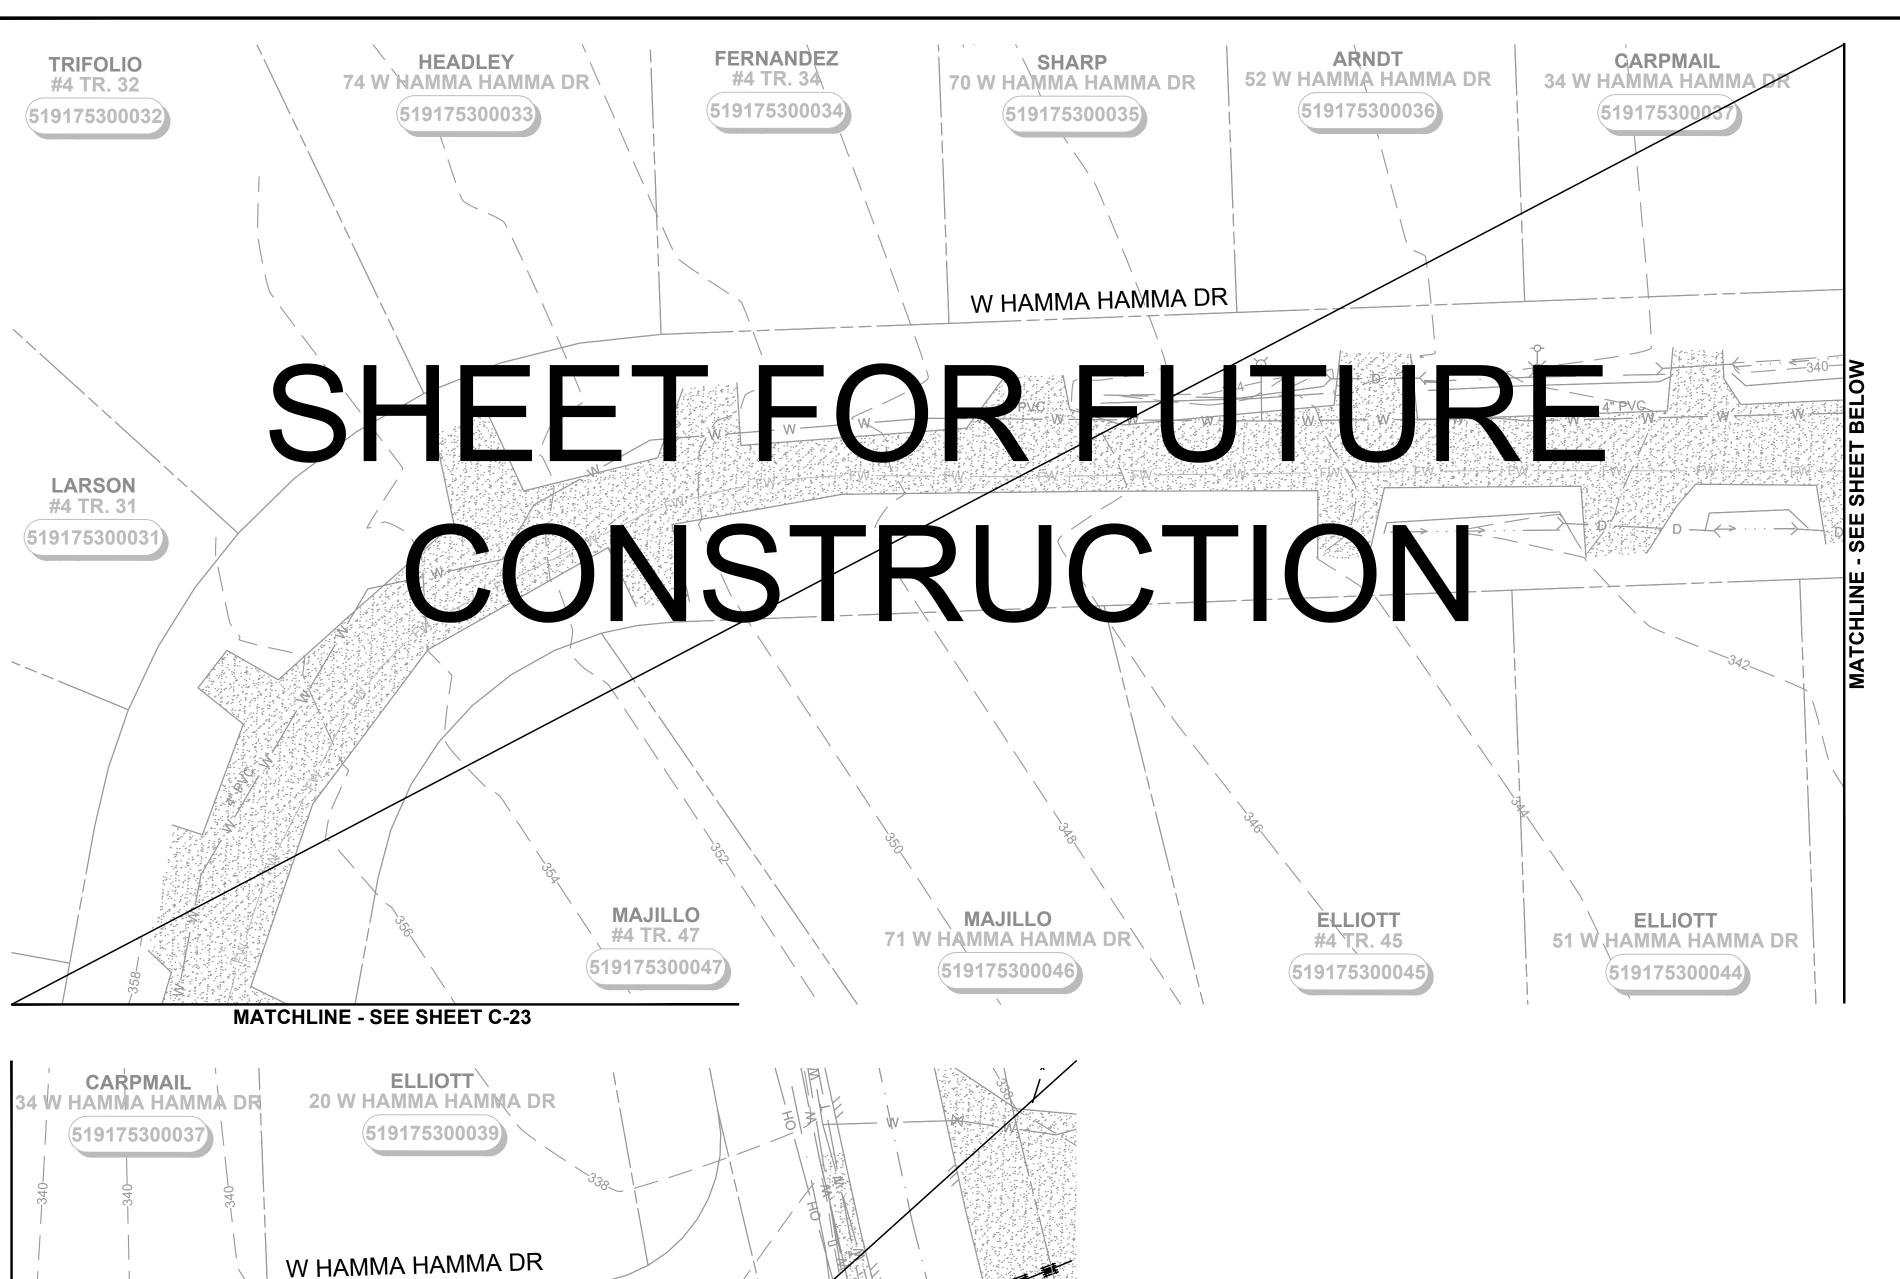

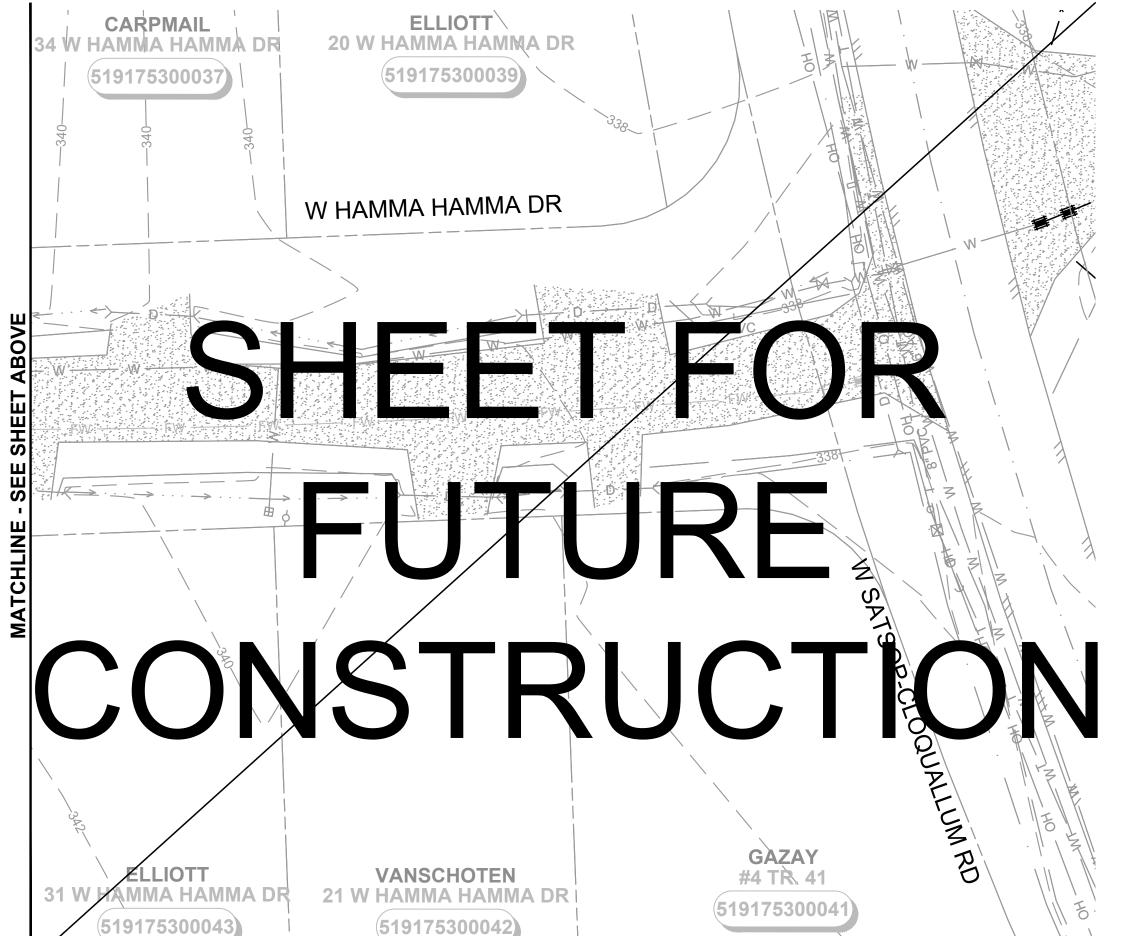

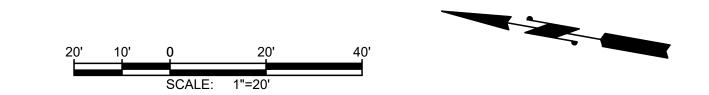

#### NOTES:


- 1. SEE EROSION CONTROL NOTES, SHEET D-1. EROSION CONTROL SHOWN FOR CLARITY ONLY, CONTRACTOR SHALL MEET ALL REGULATORY REQUIREMENTS.
- 2. BURIED UTILITIES (WHERE KNOWN) ARE SHOWN IN THEIR APPROXIMATE LOCATION. THE CONTRACTOR SHALL HAVE UTILITIES VERIFIED ON THE GROUND PRIOR TO CONSTRUCTION. NOTIFY THE UNDERGROUND UTILITIES LOCATE CENTER: CALL 811.
- 3. TREES TO REMAIN UNLESS NECESSARY FOR CONSTRUCTION.
- . WATER MAIN TRENCH PER DETAIL 1, SHEET D-2.
- ABANDON EXISTING WATER MAIN IN PLACE AFTER NEW HDPE WATER MAIN CONNECTIONS HAVE BEEN CONSTRUCTED.
- NOTIFY DISTRICT 72 HOURS IN ADVANCE OF ALL WATER SHUT DOWNS. SHUT DOWNS WILL NOT BE ALLOWED FRIDAY THROUGH MONDAY, OR ON HOLIDAYS.
- TRENCH REPAIR SHALL BE TO MATCH EXISTING SURFACE (ASPHALT, GRAVEL, HYDROSEEDING), PER DETAILS 2, 3, 4, SHEET D-2. MAXIMUM 4' RESTORATION WIDTH.
- 8. DO NOT MAKE CONNECTIONS UNTIL A SUCCESSFUL PURITY AND PRESSURE TEST OF THE NEW WATER SYSTEM HAS BEEN WITNESSED AND APPROVED BY OWNER. CONTRACTOR SHALL BE RESPONSIBLE FOR DISPOSING OF CHLORINATED WATER IN A METHOD THAT COMPLIES WITH ALL STATE AND FEDERAL REGULATIONS. CONTRACTOR SHALL SUBMIT A DISPOSAL PLAN TO THE DISTRICT PRIOR TO FILLING OF WATER MAINS. CONTRACTOR TO VERIFY CONNECTION REQUIREMENTS.

#### **CONSTRUCTION NOTES:**

- CAUTION: POTENTIAL UTILITY CONFLICT. POTHOLE TO DETERMINE EXACT LOCATION AND DEPTH OF THE EXISTING UTILITIES PRIOR TO CONSTRUCTION. ANY DISCREPANCIES FOUND IN THE FIELD FROM THOSE SHOWN HEREIN SHALL BE REPORTED TO THE OWNER PRIOR TO COMMENCING THE WORK. PROTECT EXISTING UTILITY DURING INSTALLATION OF NEW WATER MAIN.
- 2 INSTALL FIRE HYDRANT ASSEMBLY PER DETAIL 5, SHEET D-2, FINAL LOCATION TO BE APPROVED BY DISTRICT.
- CONNECT TO EXISTING MAIN WITH WET TAP AND TAPPING GATE VALVE AS PER DETAIL 3, SHEET D-3. CONTRACTOR TO VERIFY SIZE AND DEPTH OF EXISTING MAIN BEFORE MAKING CONNECTION.
- INSTALL NEW WATER MAIN UNDER EXISTING UTILITY, EXTRA DEPTH MAY BE REQUIRED. CONTRACTOR TO VERIFY.
- (5) INSTALL SILT FENCE PER DETAIL 1, SHEET D-1.
- (6) INSTALL STRAW WATTLE DAM PER DETAIL 2, SHEET D-1
- 7 INSTALL WATER SERVICE CONNECTION PER DETAIL 4, SHEET D-3.

#### **DISTRICT TO PERFORM THE FOLLOWING:**

- 8 CLOSE VALVE, REMOVE VALVE BOX AND FILL WITH LEAN CONCRETE.
- 9 REMOVE AND WASTEHAUL FIRE HYDRANT.
- 10) INSTALL CAP WITH THRUST BLOCK.
- PLUG EXISTING MAIN WITH LEAN CONCRETE TO A MIN. OF 2 DIAMETERS.

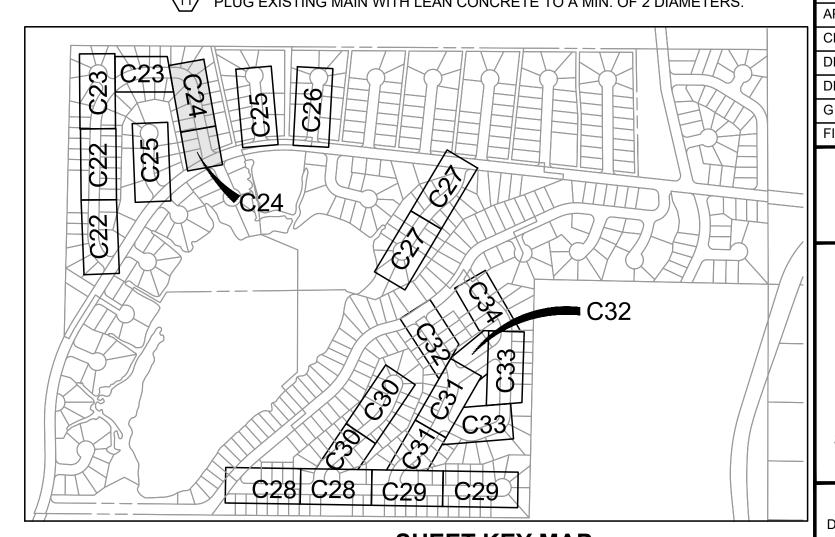


SHEET KEY MAP

NTS



1130 RAINIER AVENUE SOUTH, SUITE 300 SEATTLE, WASHINGTON 98144 (206) 284-0860

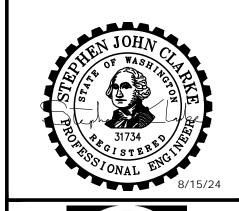



REPLACEMENT

160 W SATSOP CLOQUALLUM
RD., ELMA, WA 98541

No. DATE REVISION

ISSUED FOR:

BID
ISSUE DATE: AUG 2024

APPROVED BY: S. CLARKE
CHECKED BY: M. JOHNSON
DRAWN BY: B. HAYDEN
DESIGNER: P. SMILEY
G & O JOB NO.: 22249


TWO INCHES AT FULL SCALE.
IF NOT, SCALE ACCORDINGLY


C-PLAN\_3.DWC

CIVIL

SHEET FOR FUTURE CONSTRUCTION

DRAWING: C-24 OF: 37

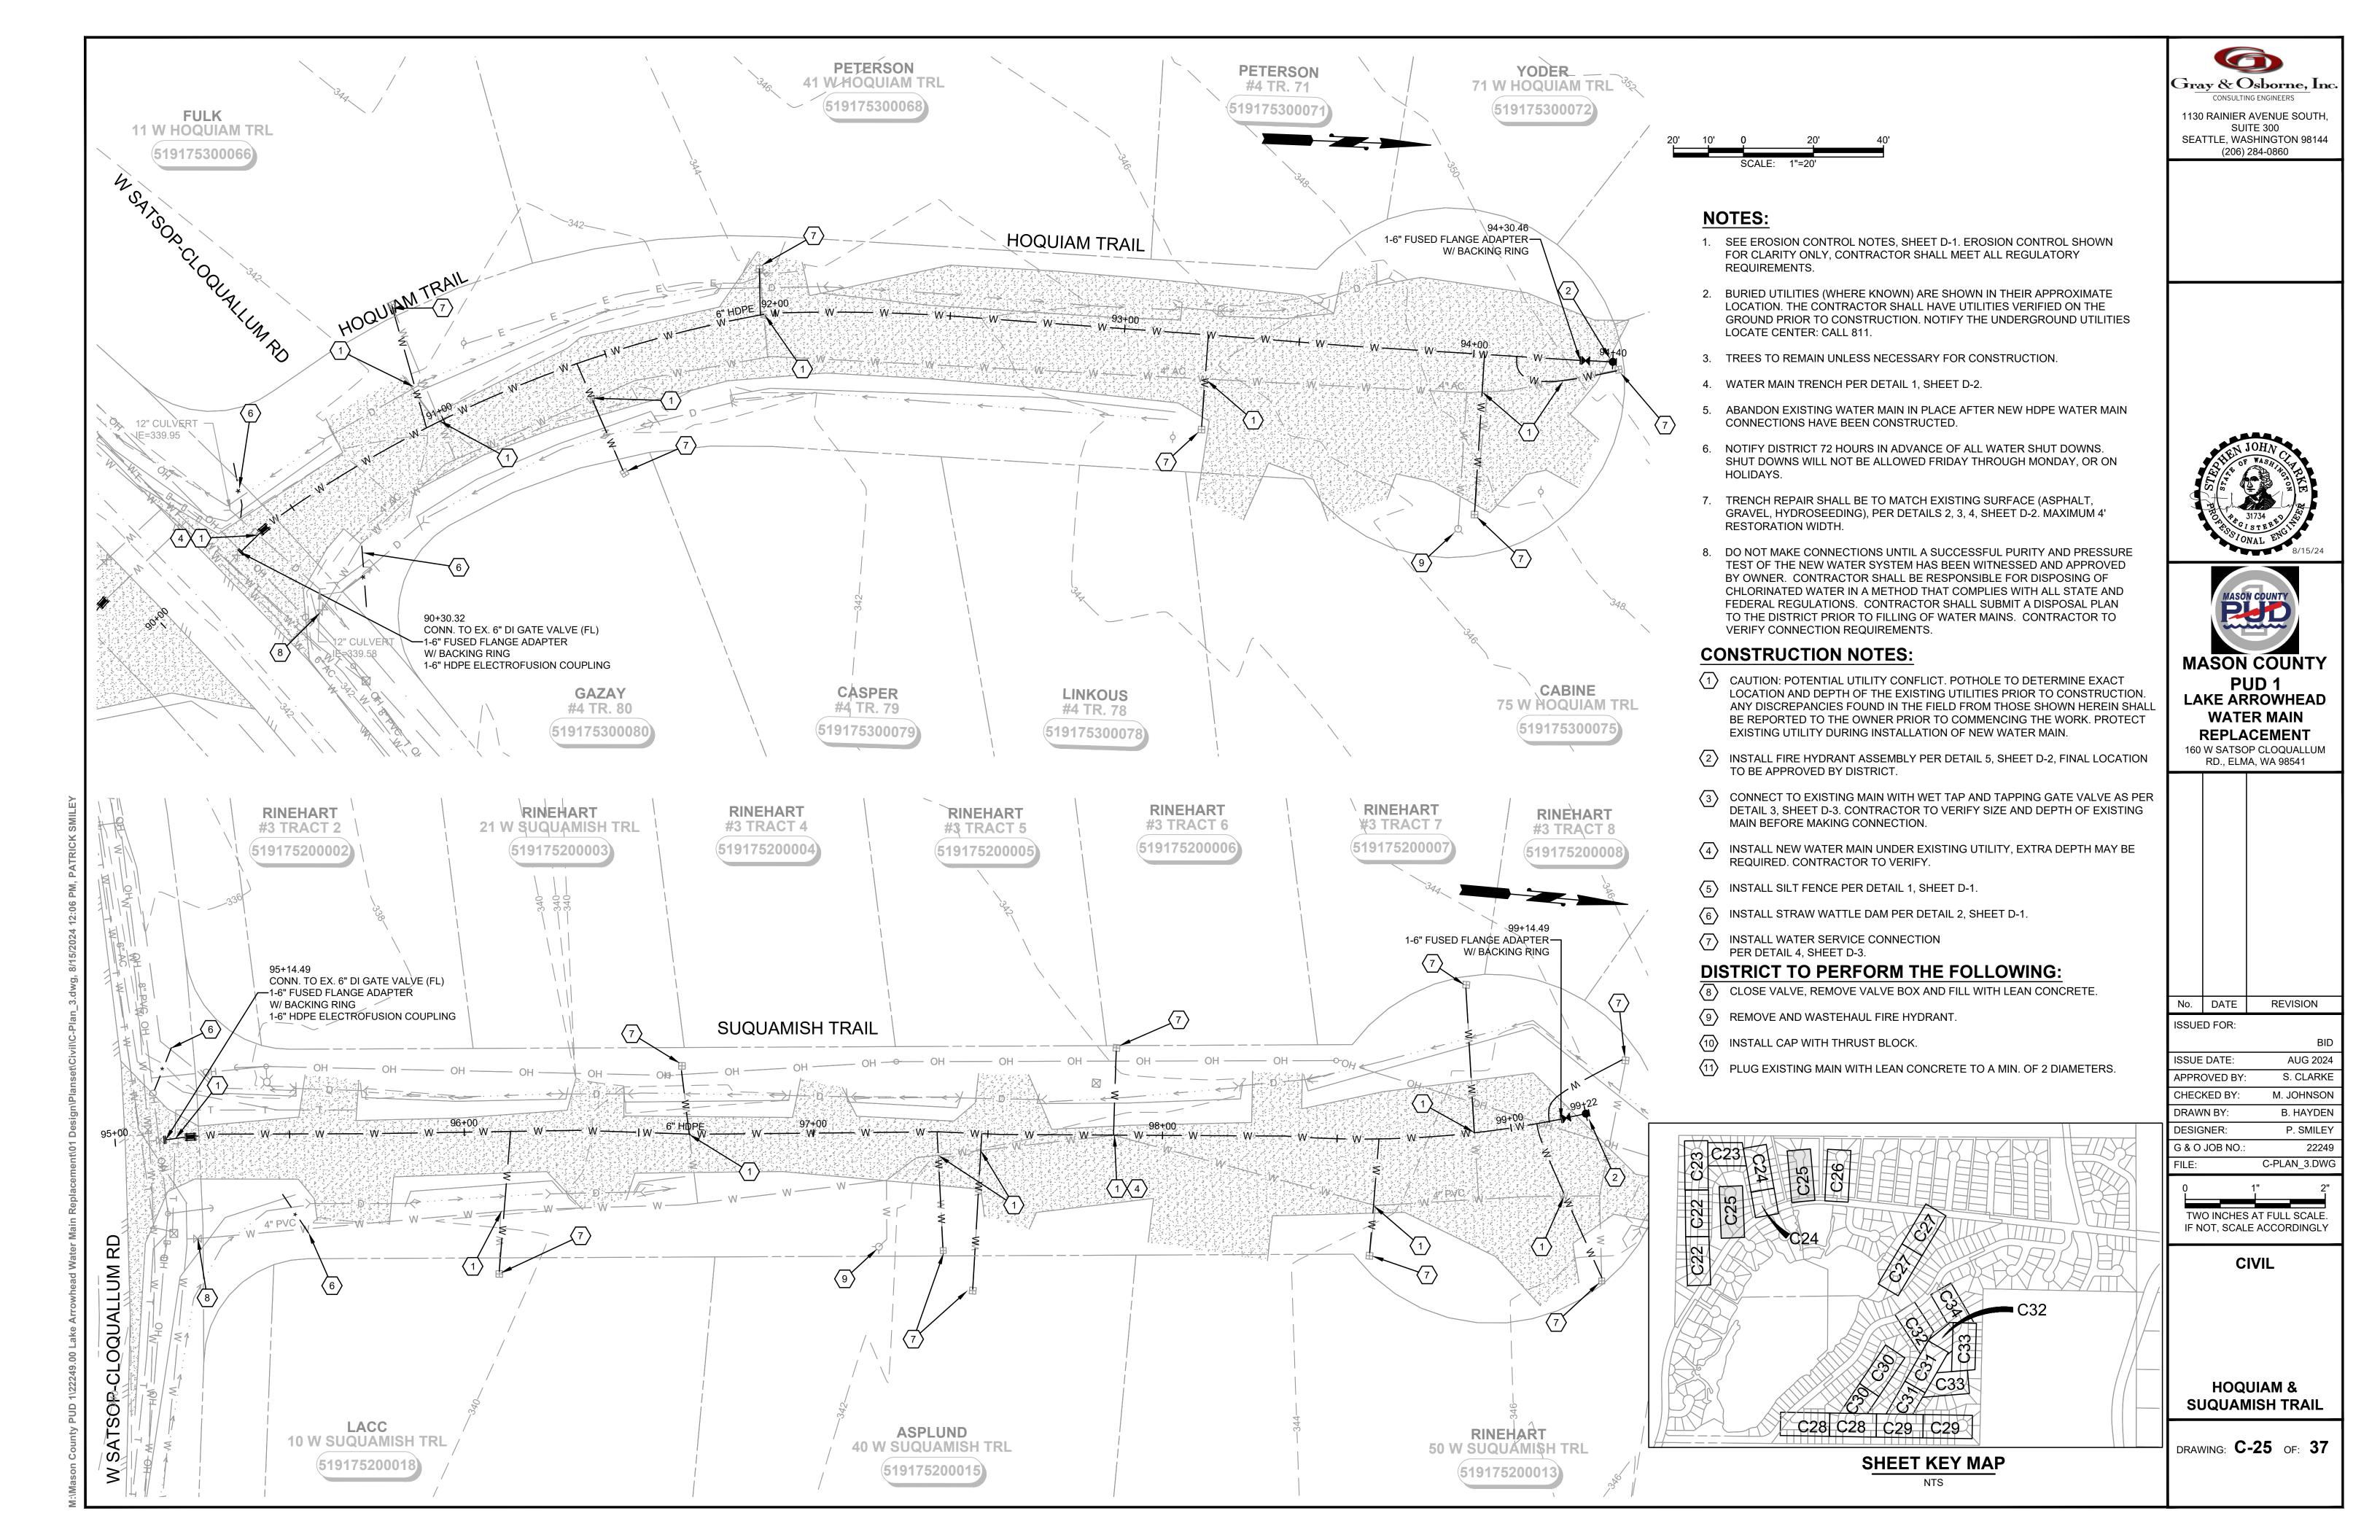

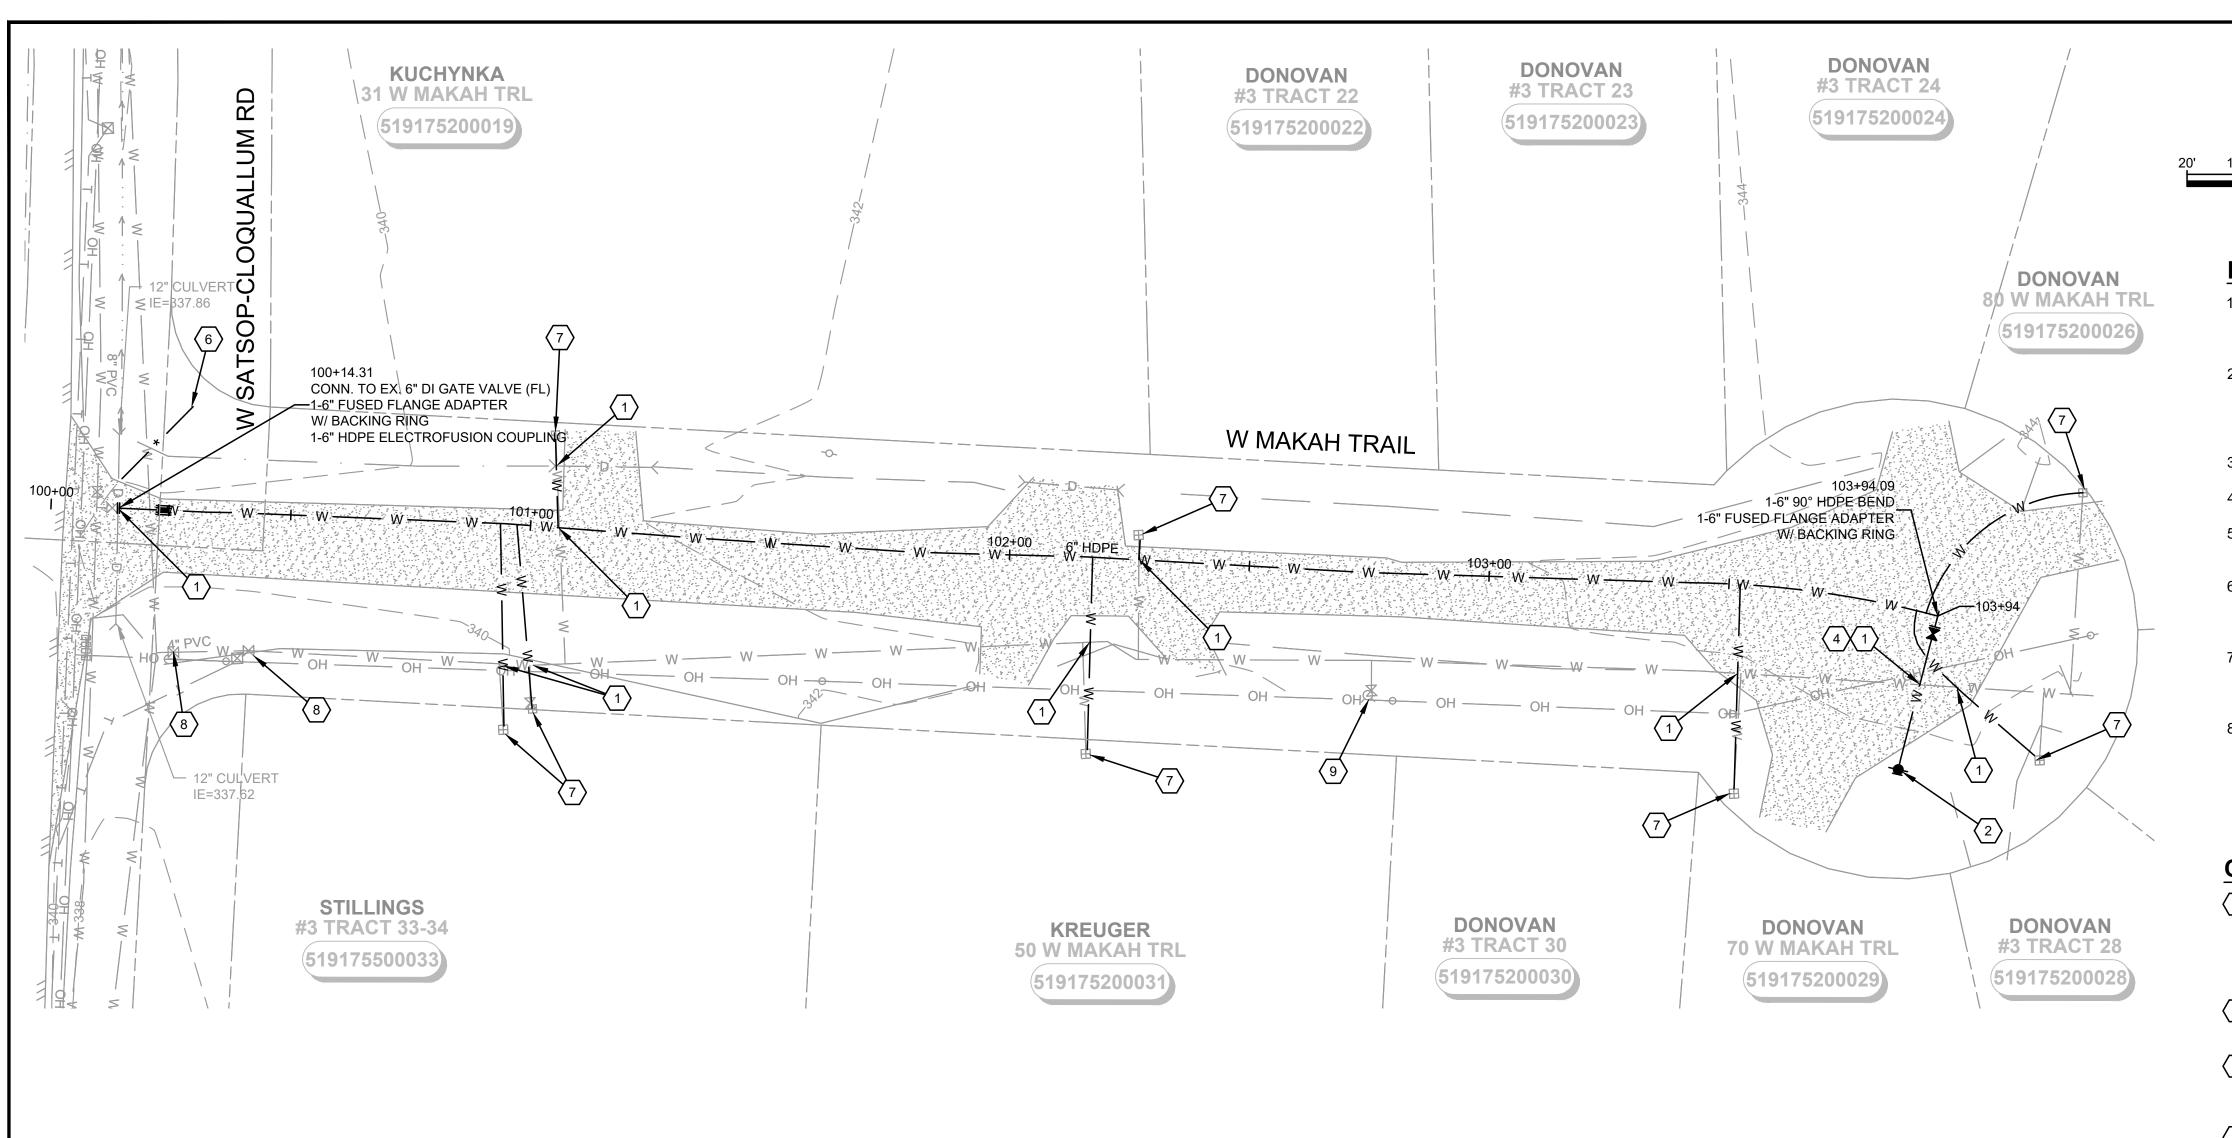



1130 RAINIER AVENUE SOUTH, SUITE 300 SEATTLE, WASHINGTON 98144 (206) 284-0860

### NOTES:


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#### **CONSTRUCTION NOTES:**


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- PLUG EXISTING MAIN WITH LEAN CONCRETE TO A MIN. OF 2 DIAMETERS.



SHEET KEY MAP

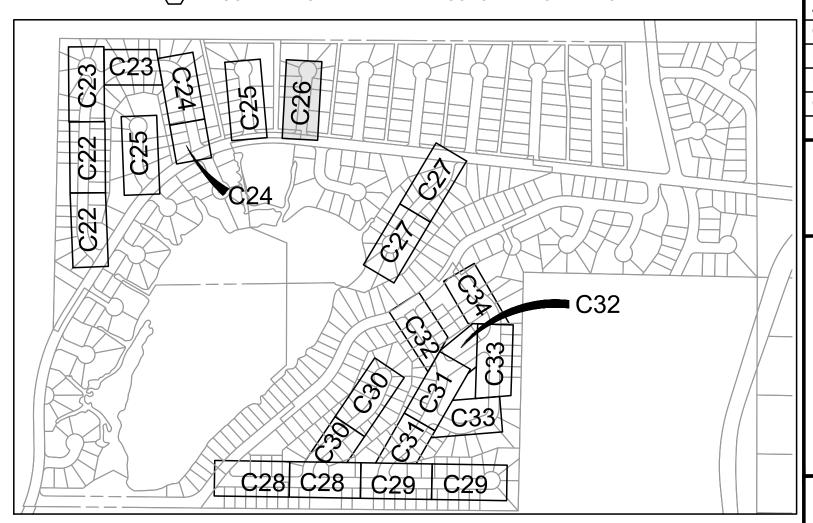

MASON COUNTY PUD 1 LAKE ARROWHEAD **WATER MAIN** REPLACEMENT

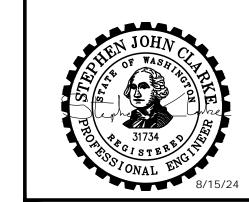160 W SATSOP CLOQUALLUM RD., ELMA, WA 98541

REVISION No. DATE

ISSUED FOR: ISSUE DATE: AUG 2024 APPROVED BY: S. CLARKE

M. JOHNSON CHECKED BY: DRAWN BY: B. HAYDEN P. SMILEY DESIGNER: G & O JOB NO.: C-PLAN\_3.DWG


TWO INCHES AT FULL SCALE IF NOT, SCALE ACCORDINGLY

CIVIL


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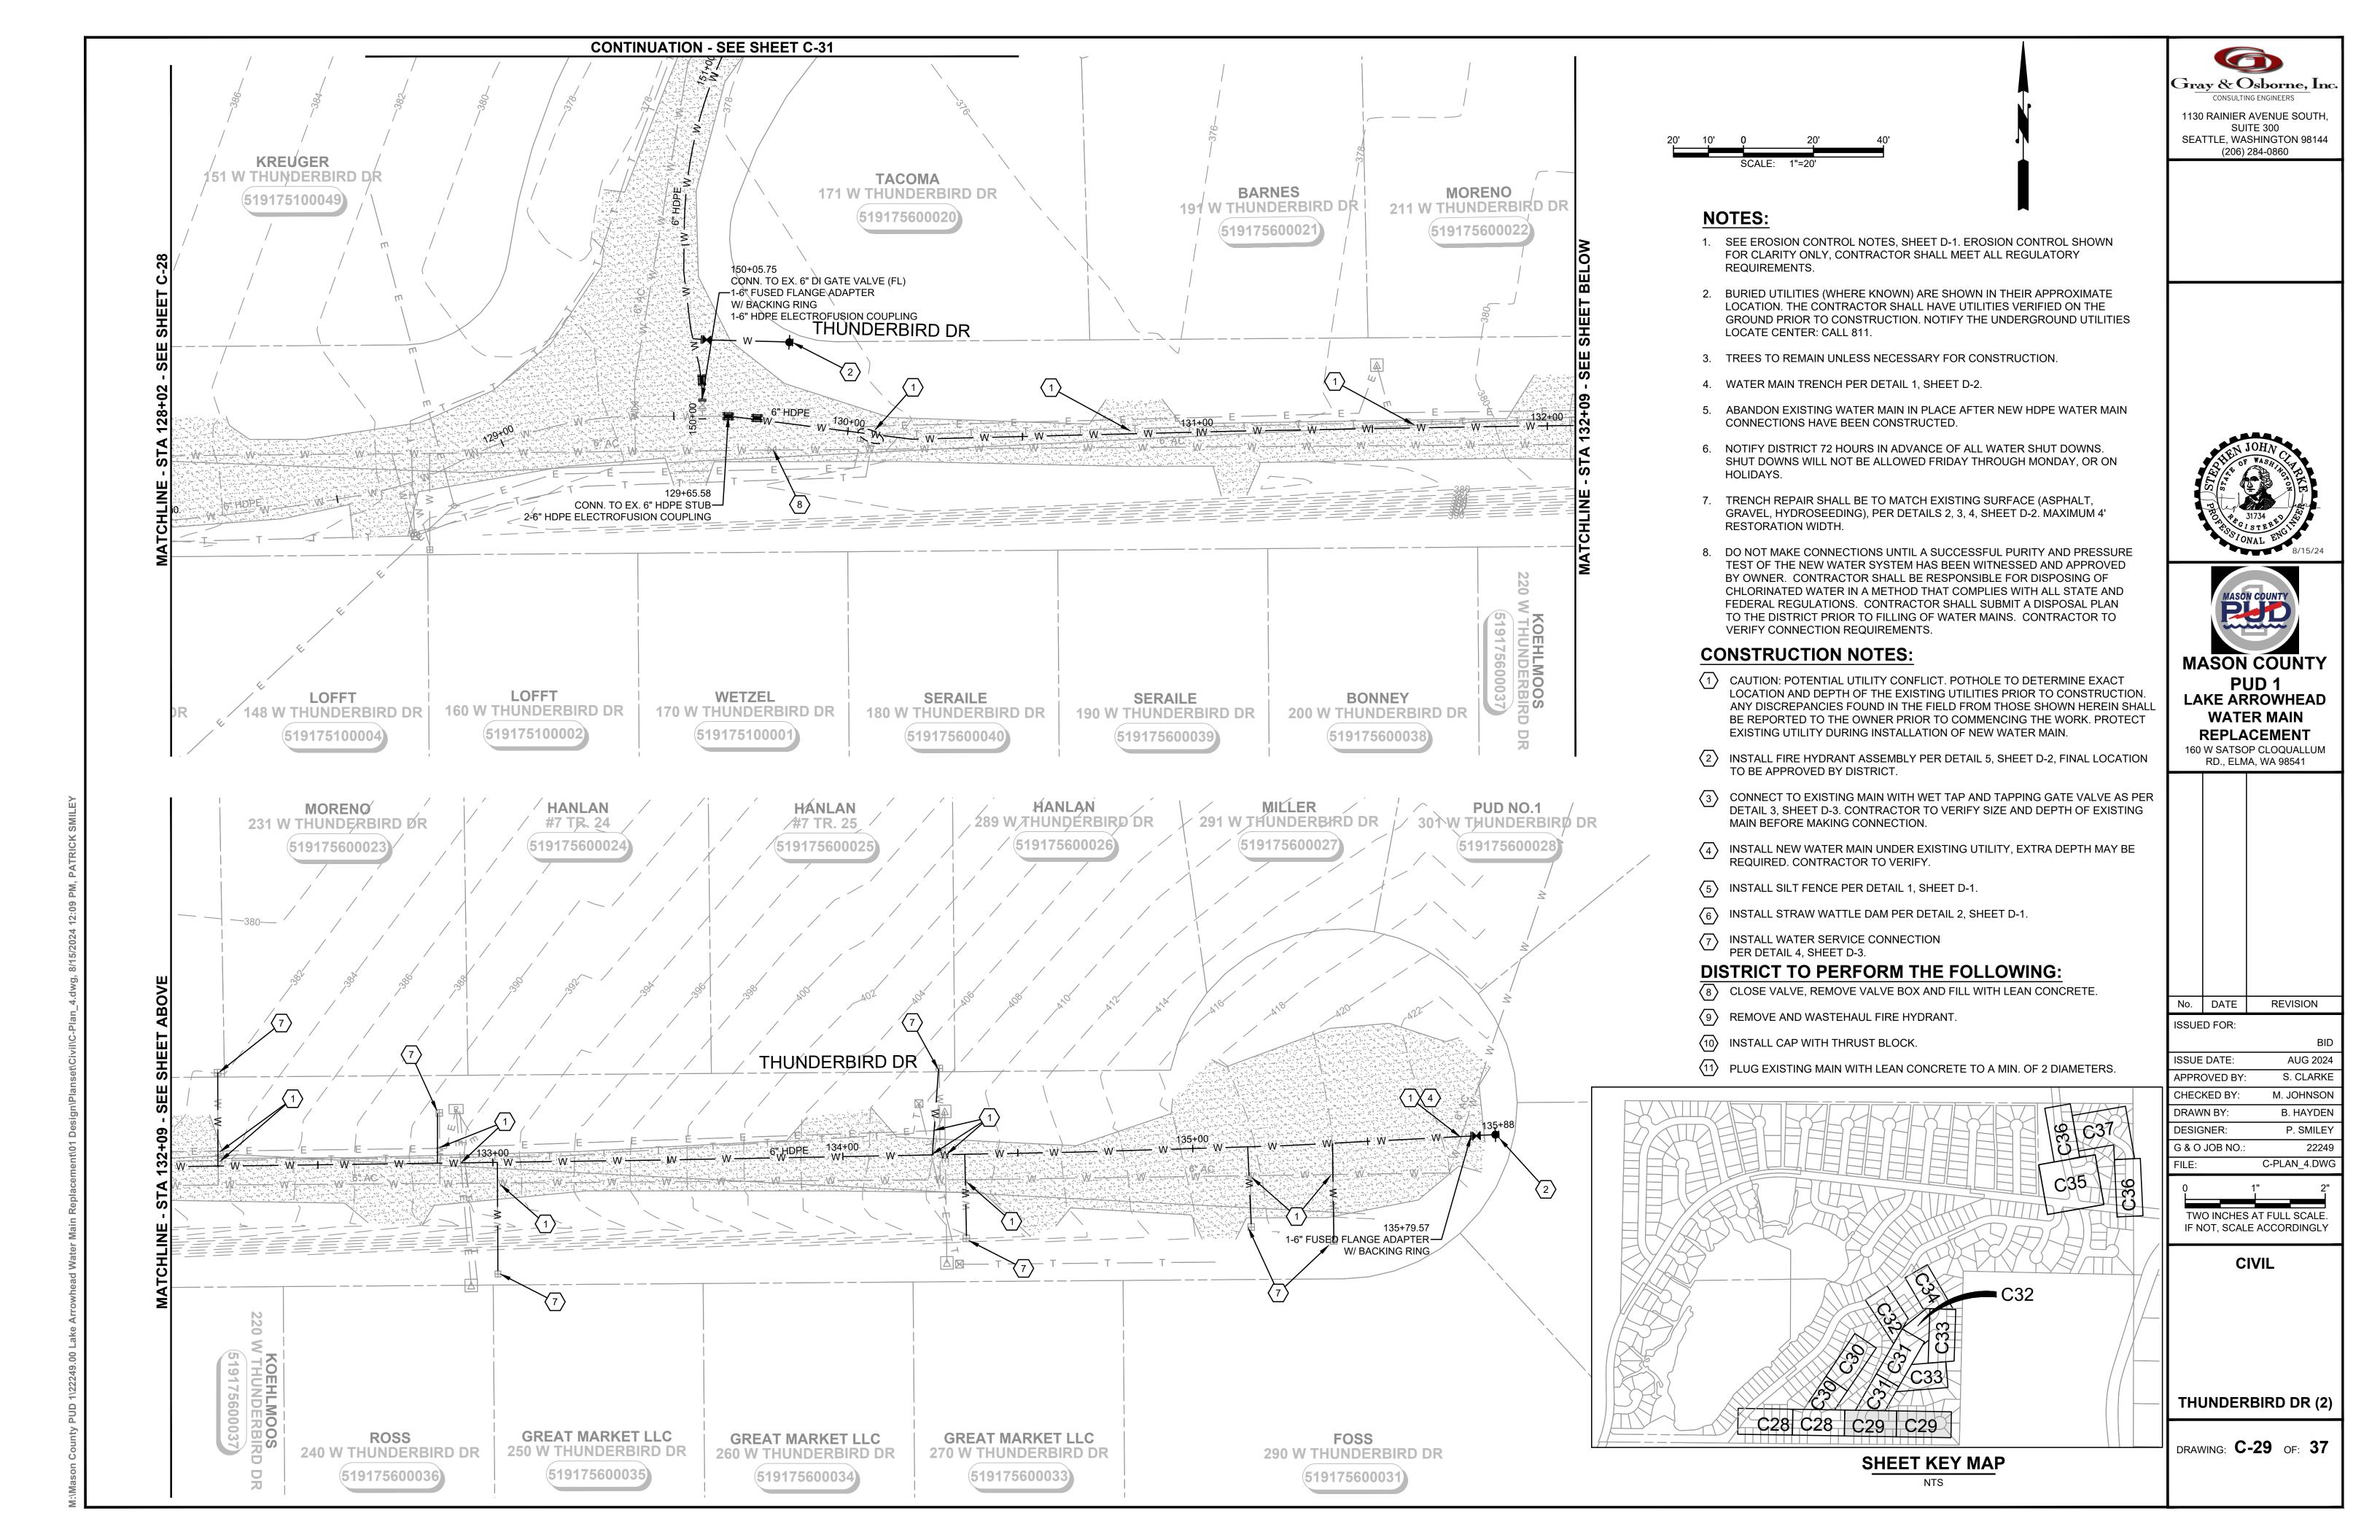
DRAWING: **C-26** OF: **37** 




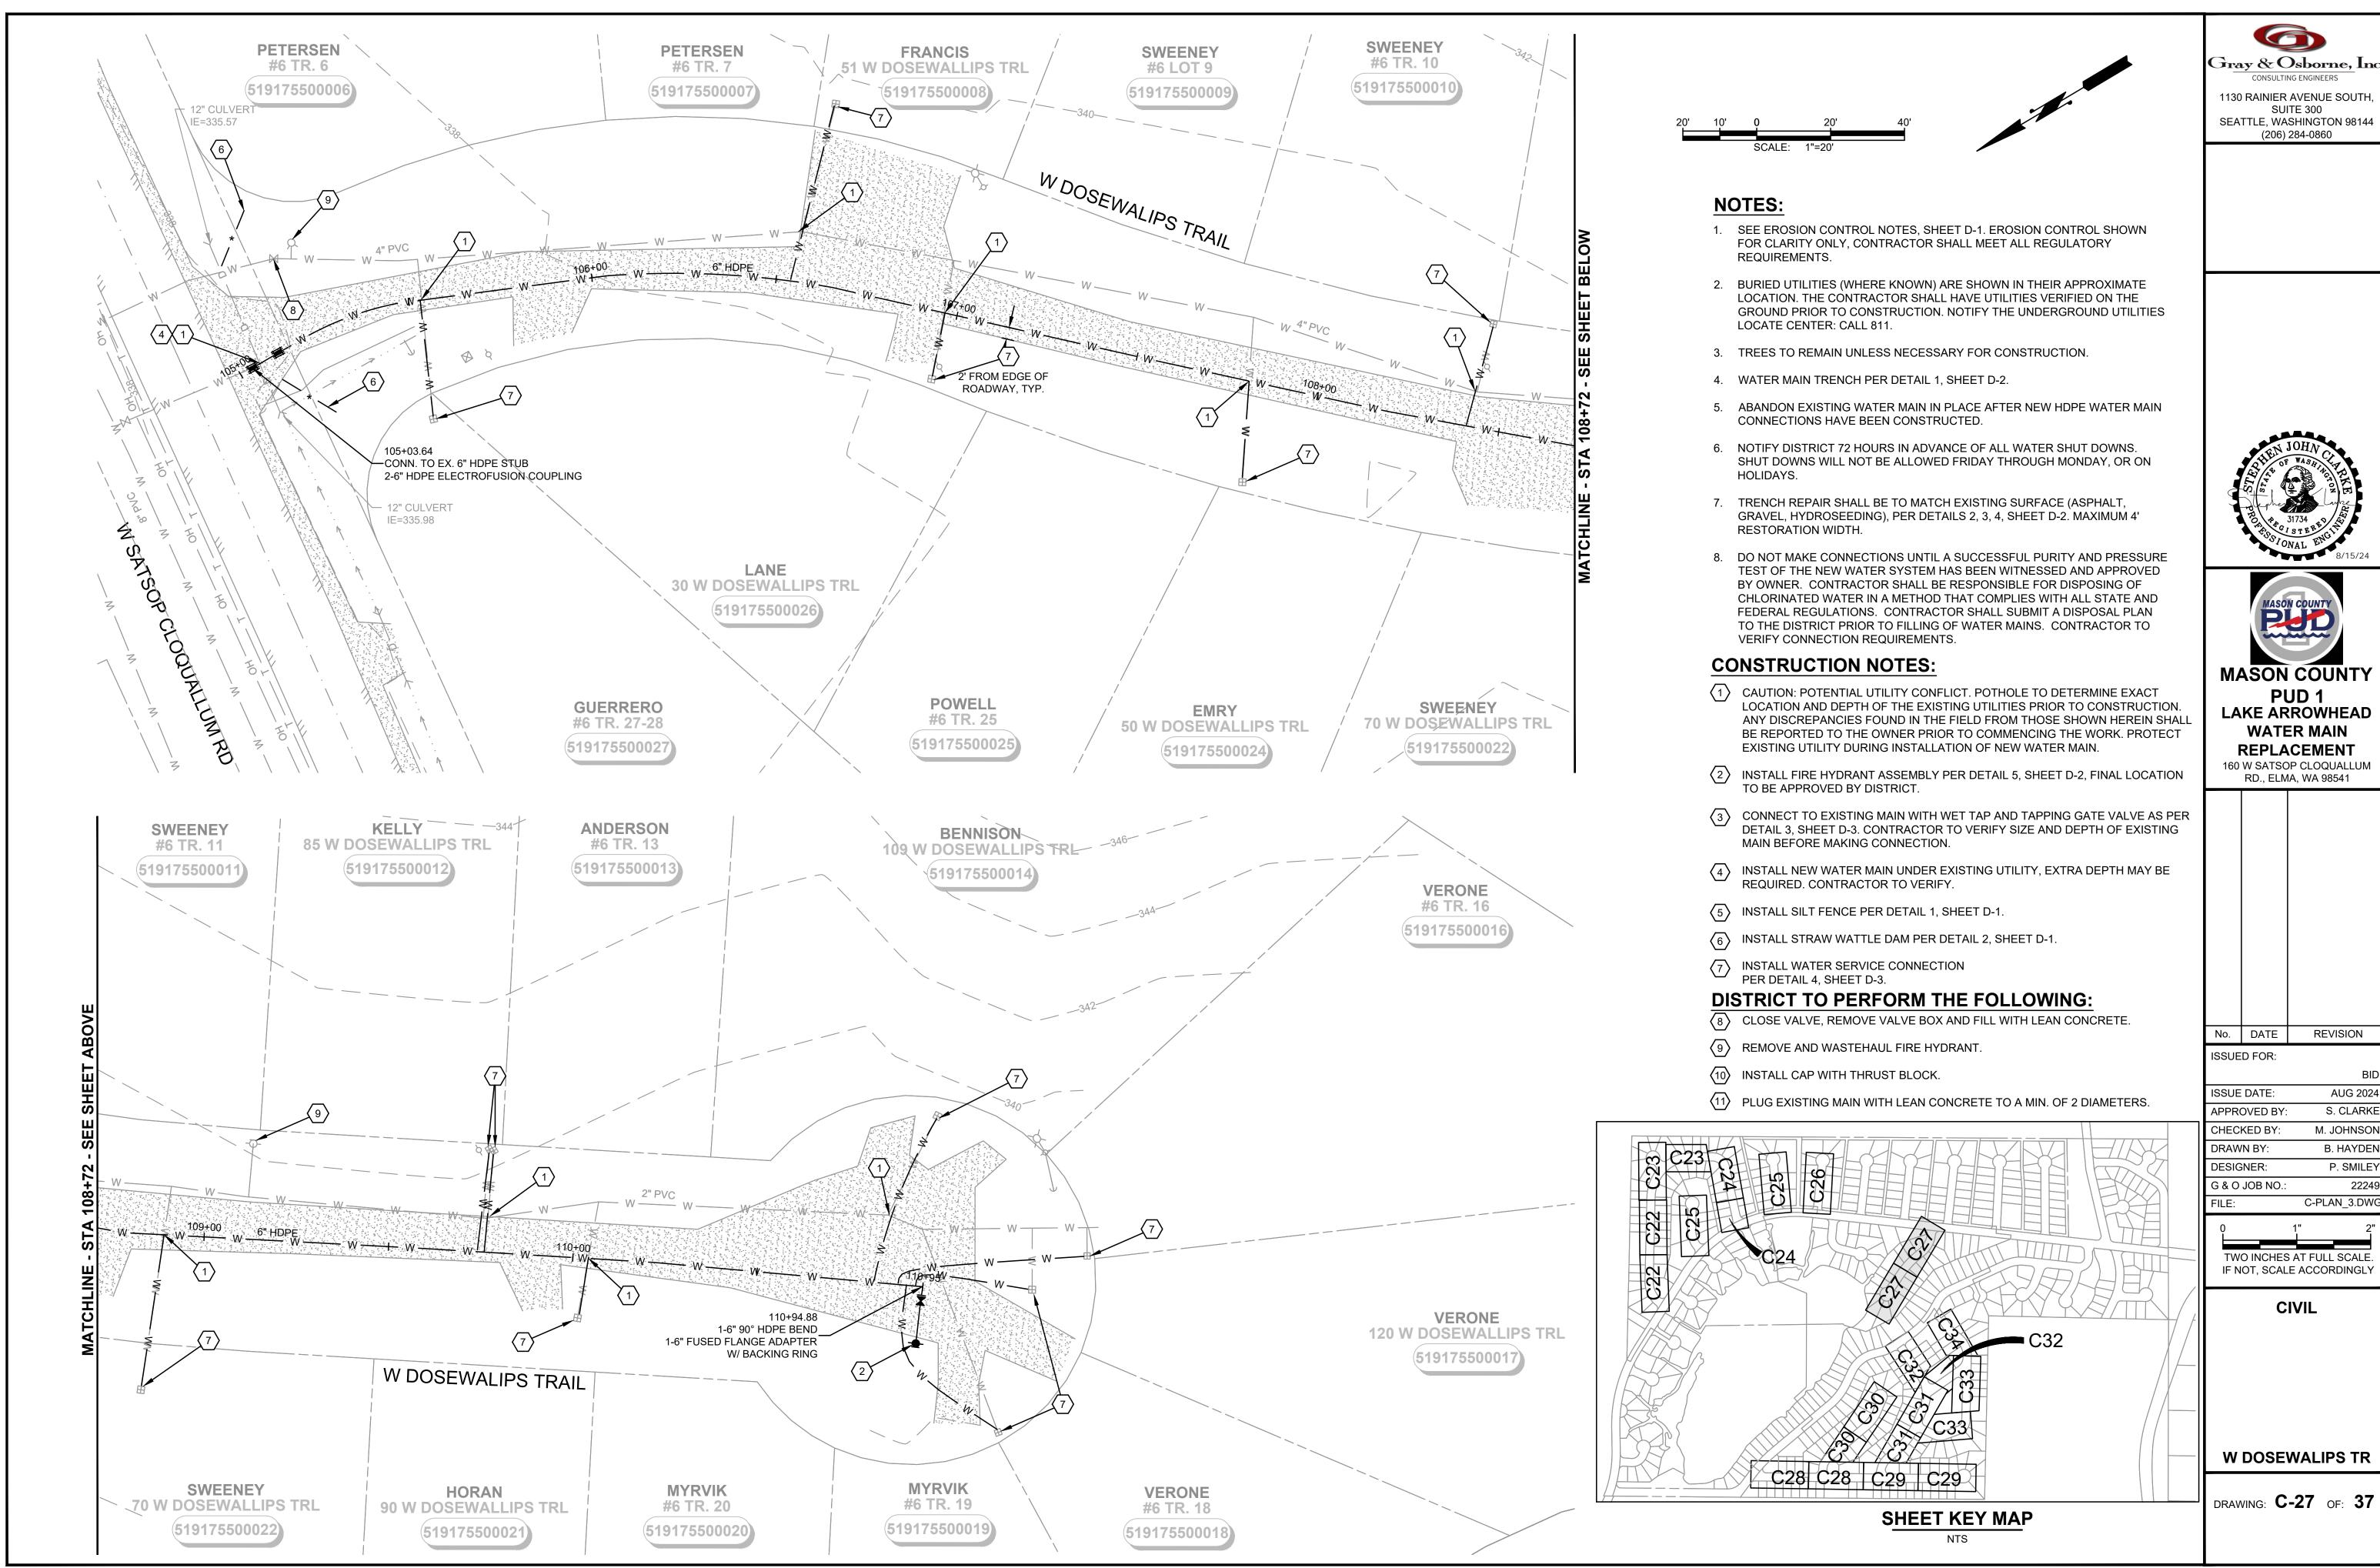



1130 RAINIER AVENUE SOUTH SEATTLE, WASHINGTON 98144



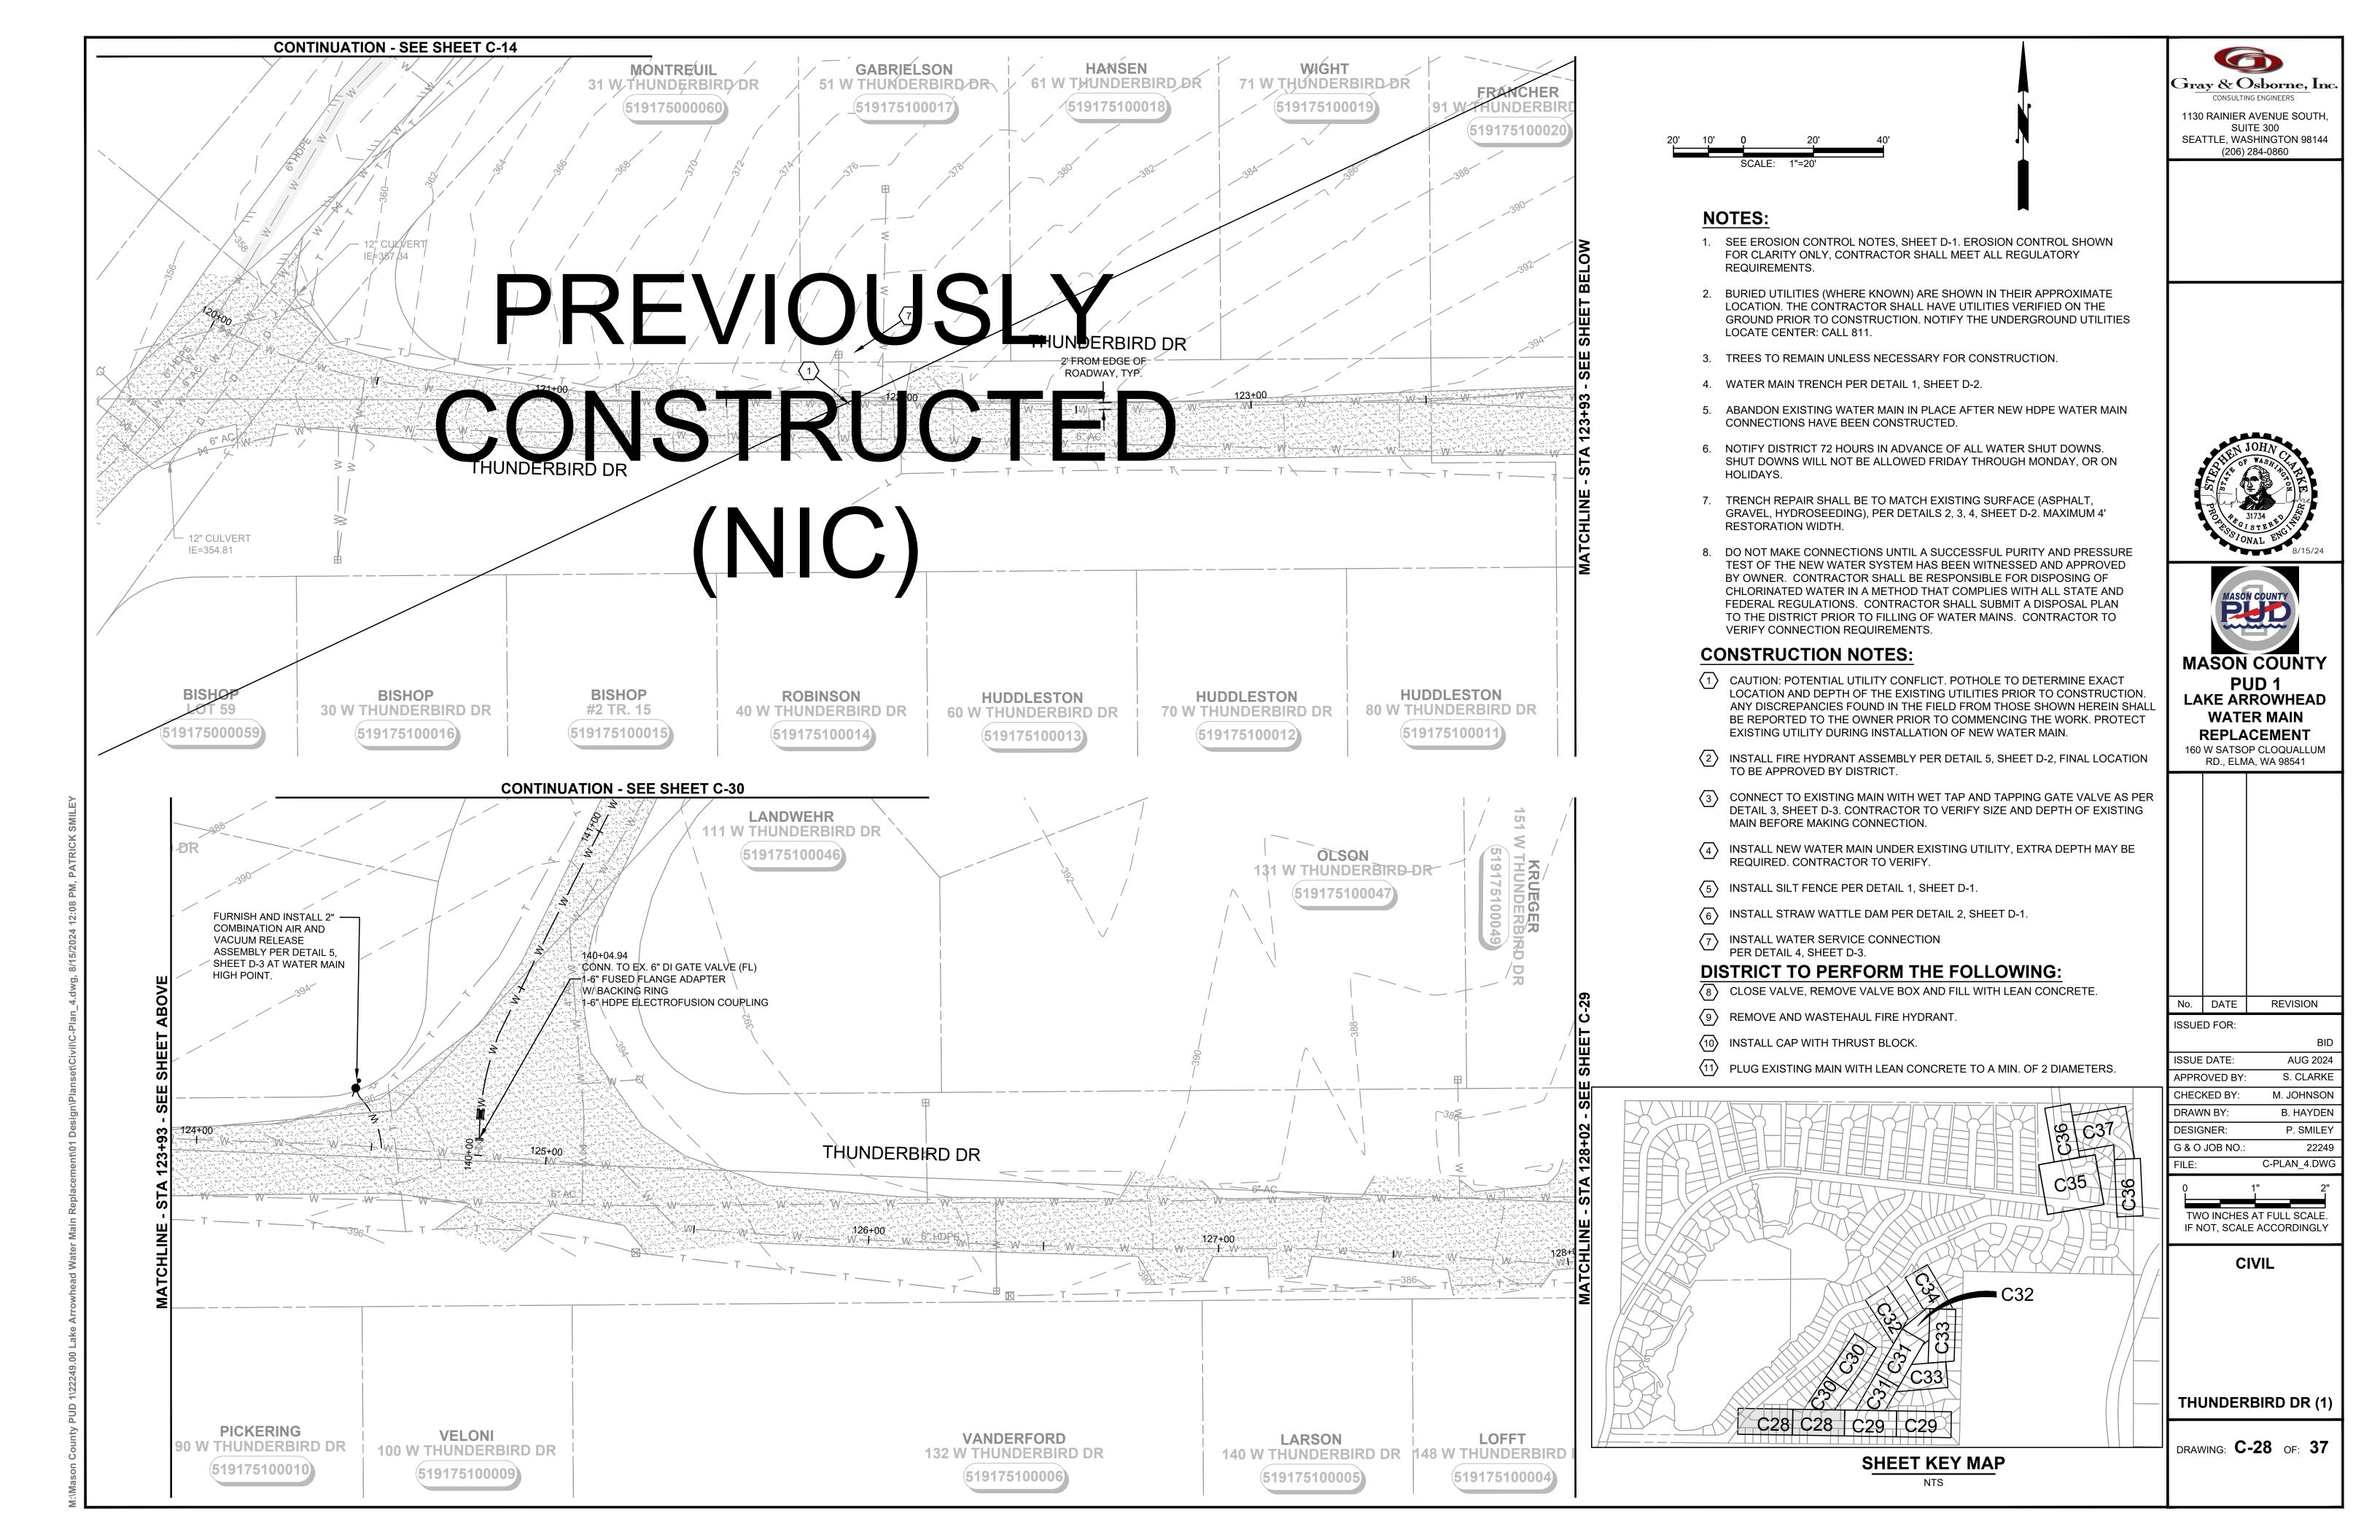

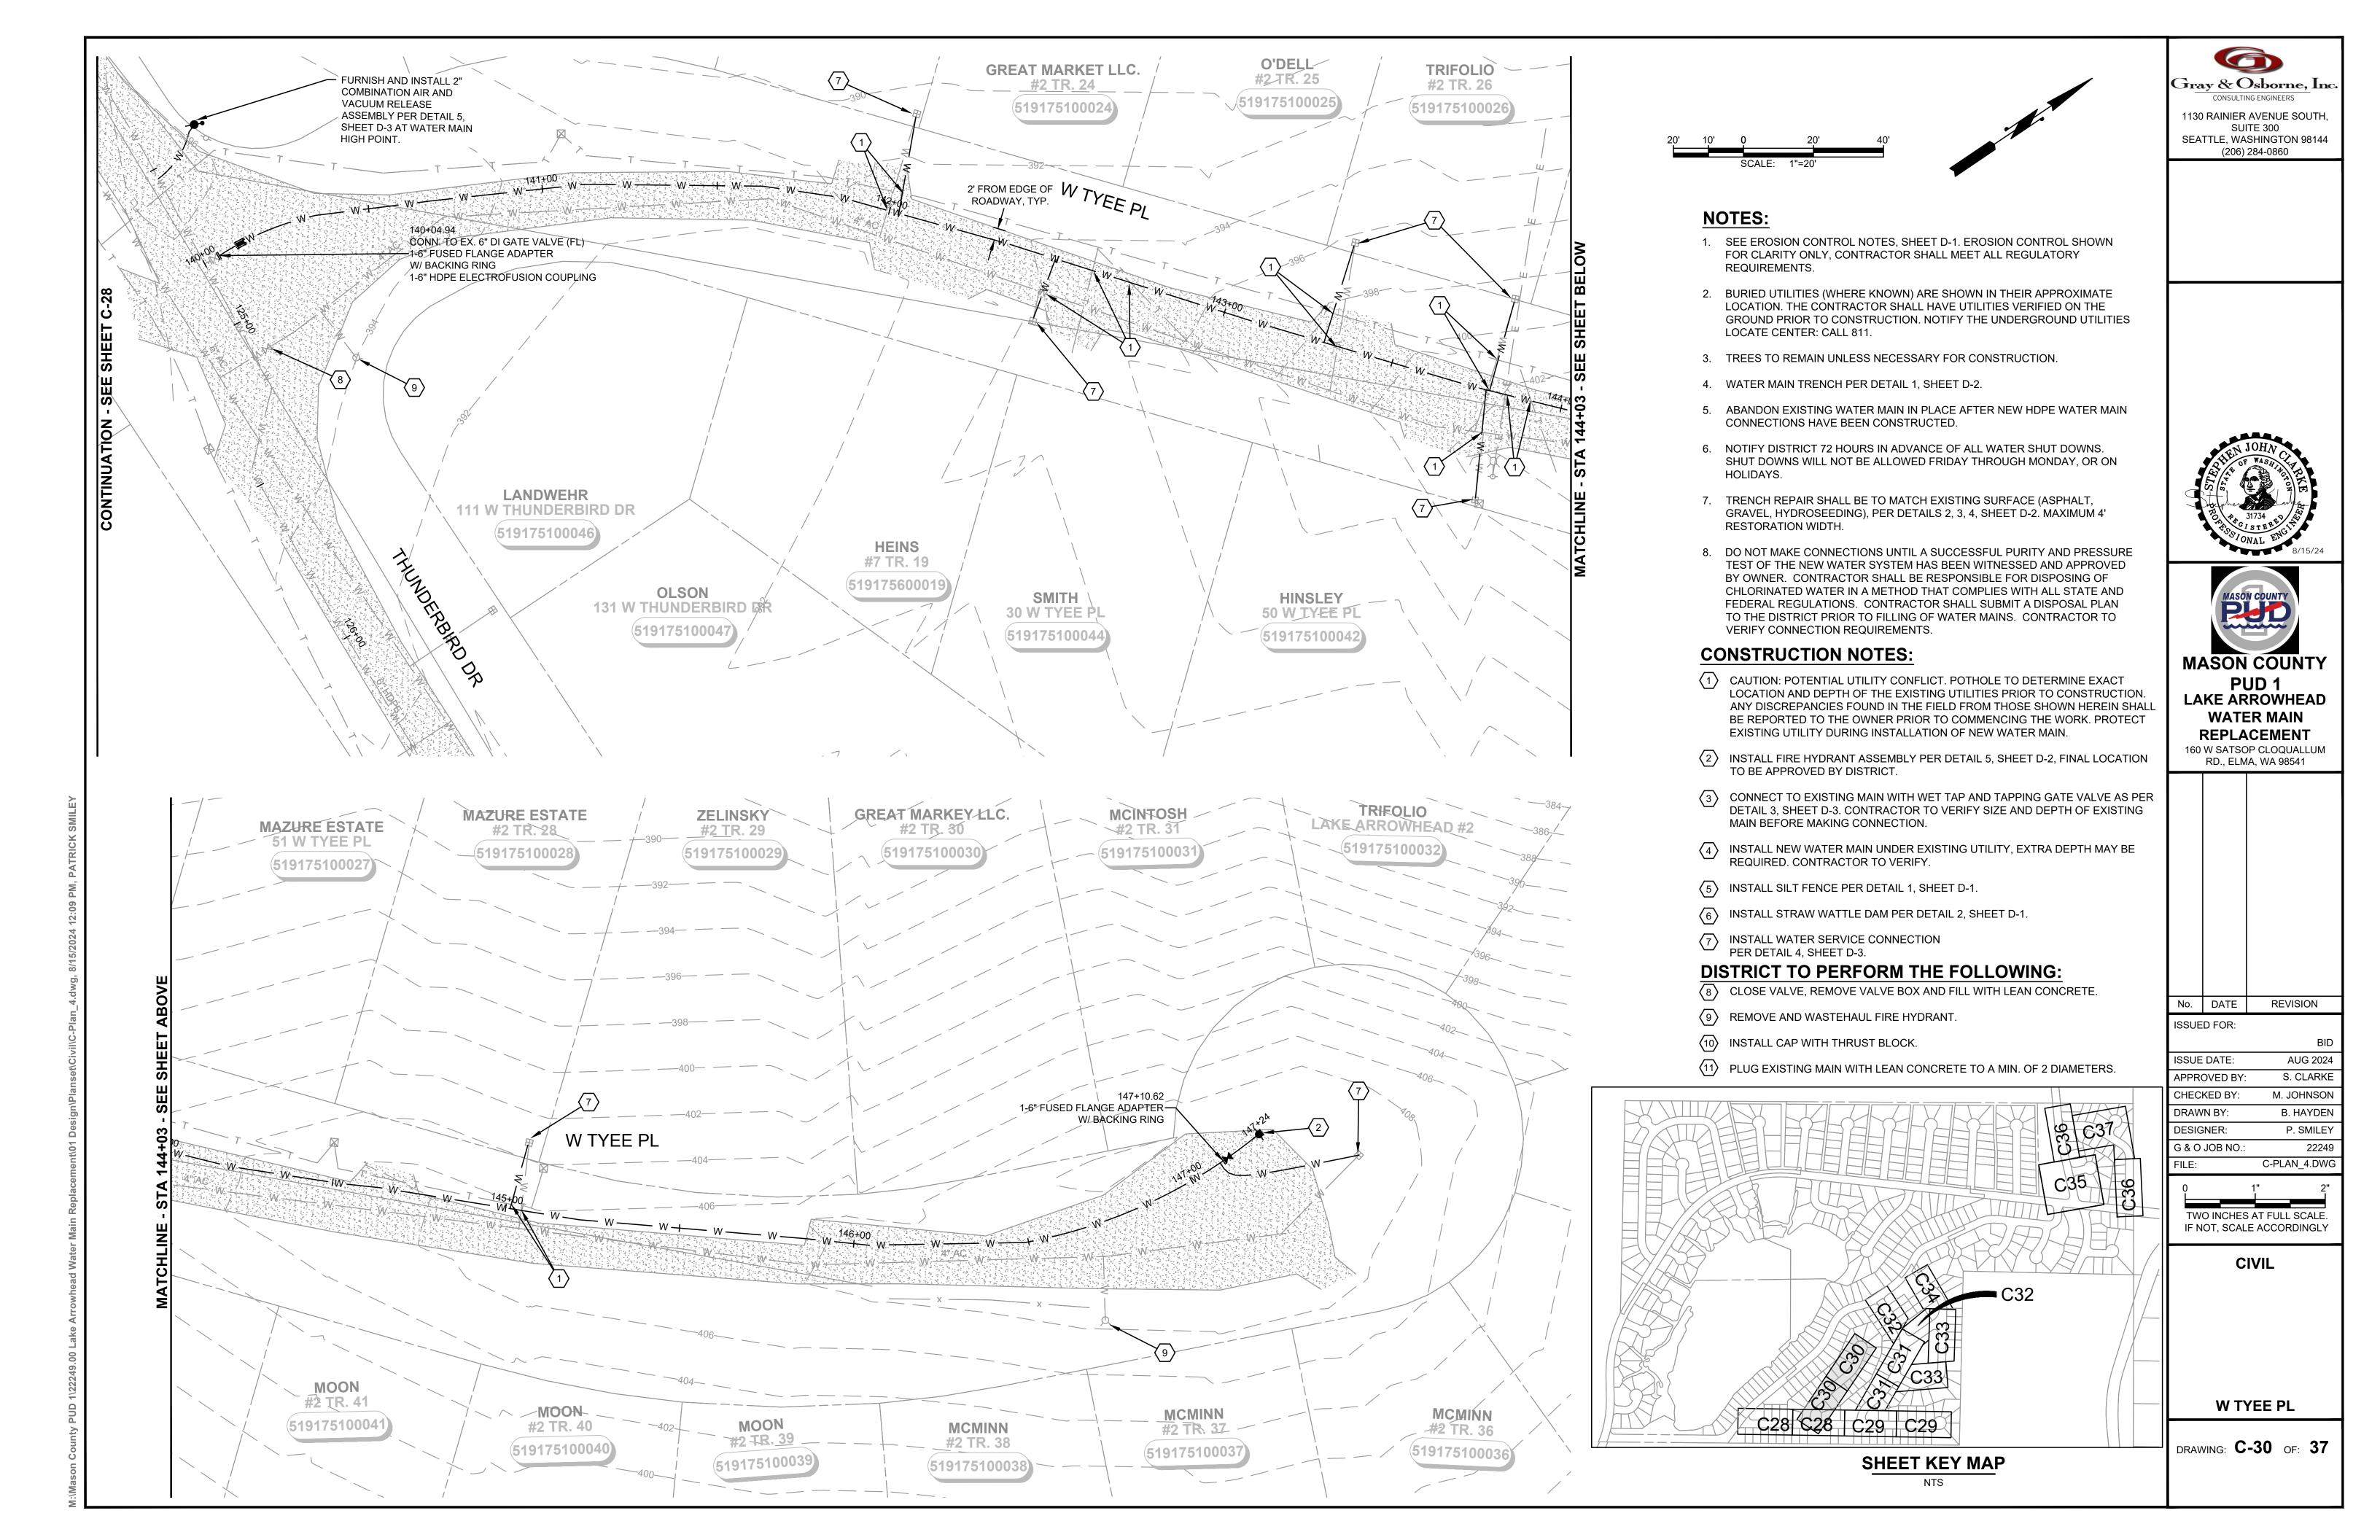

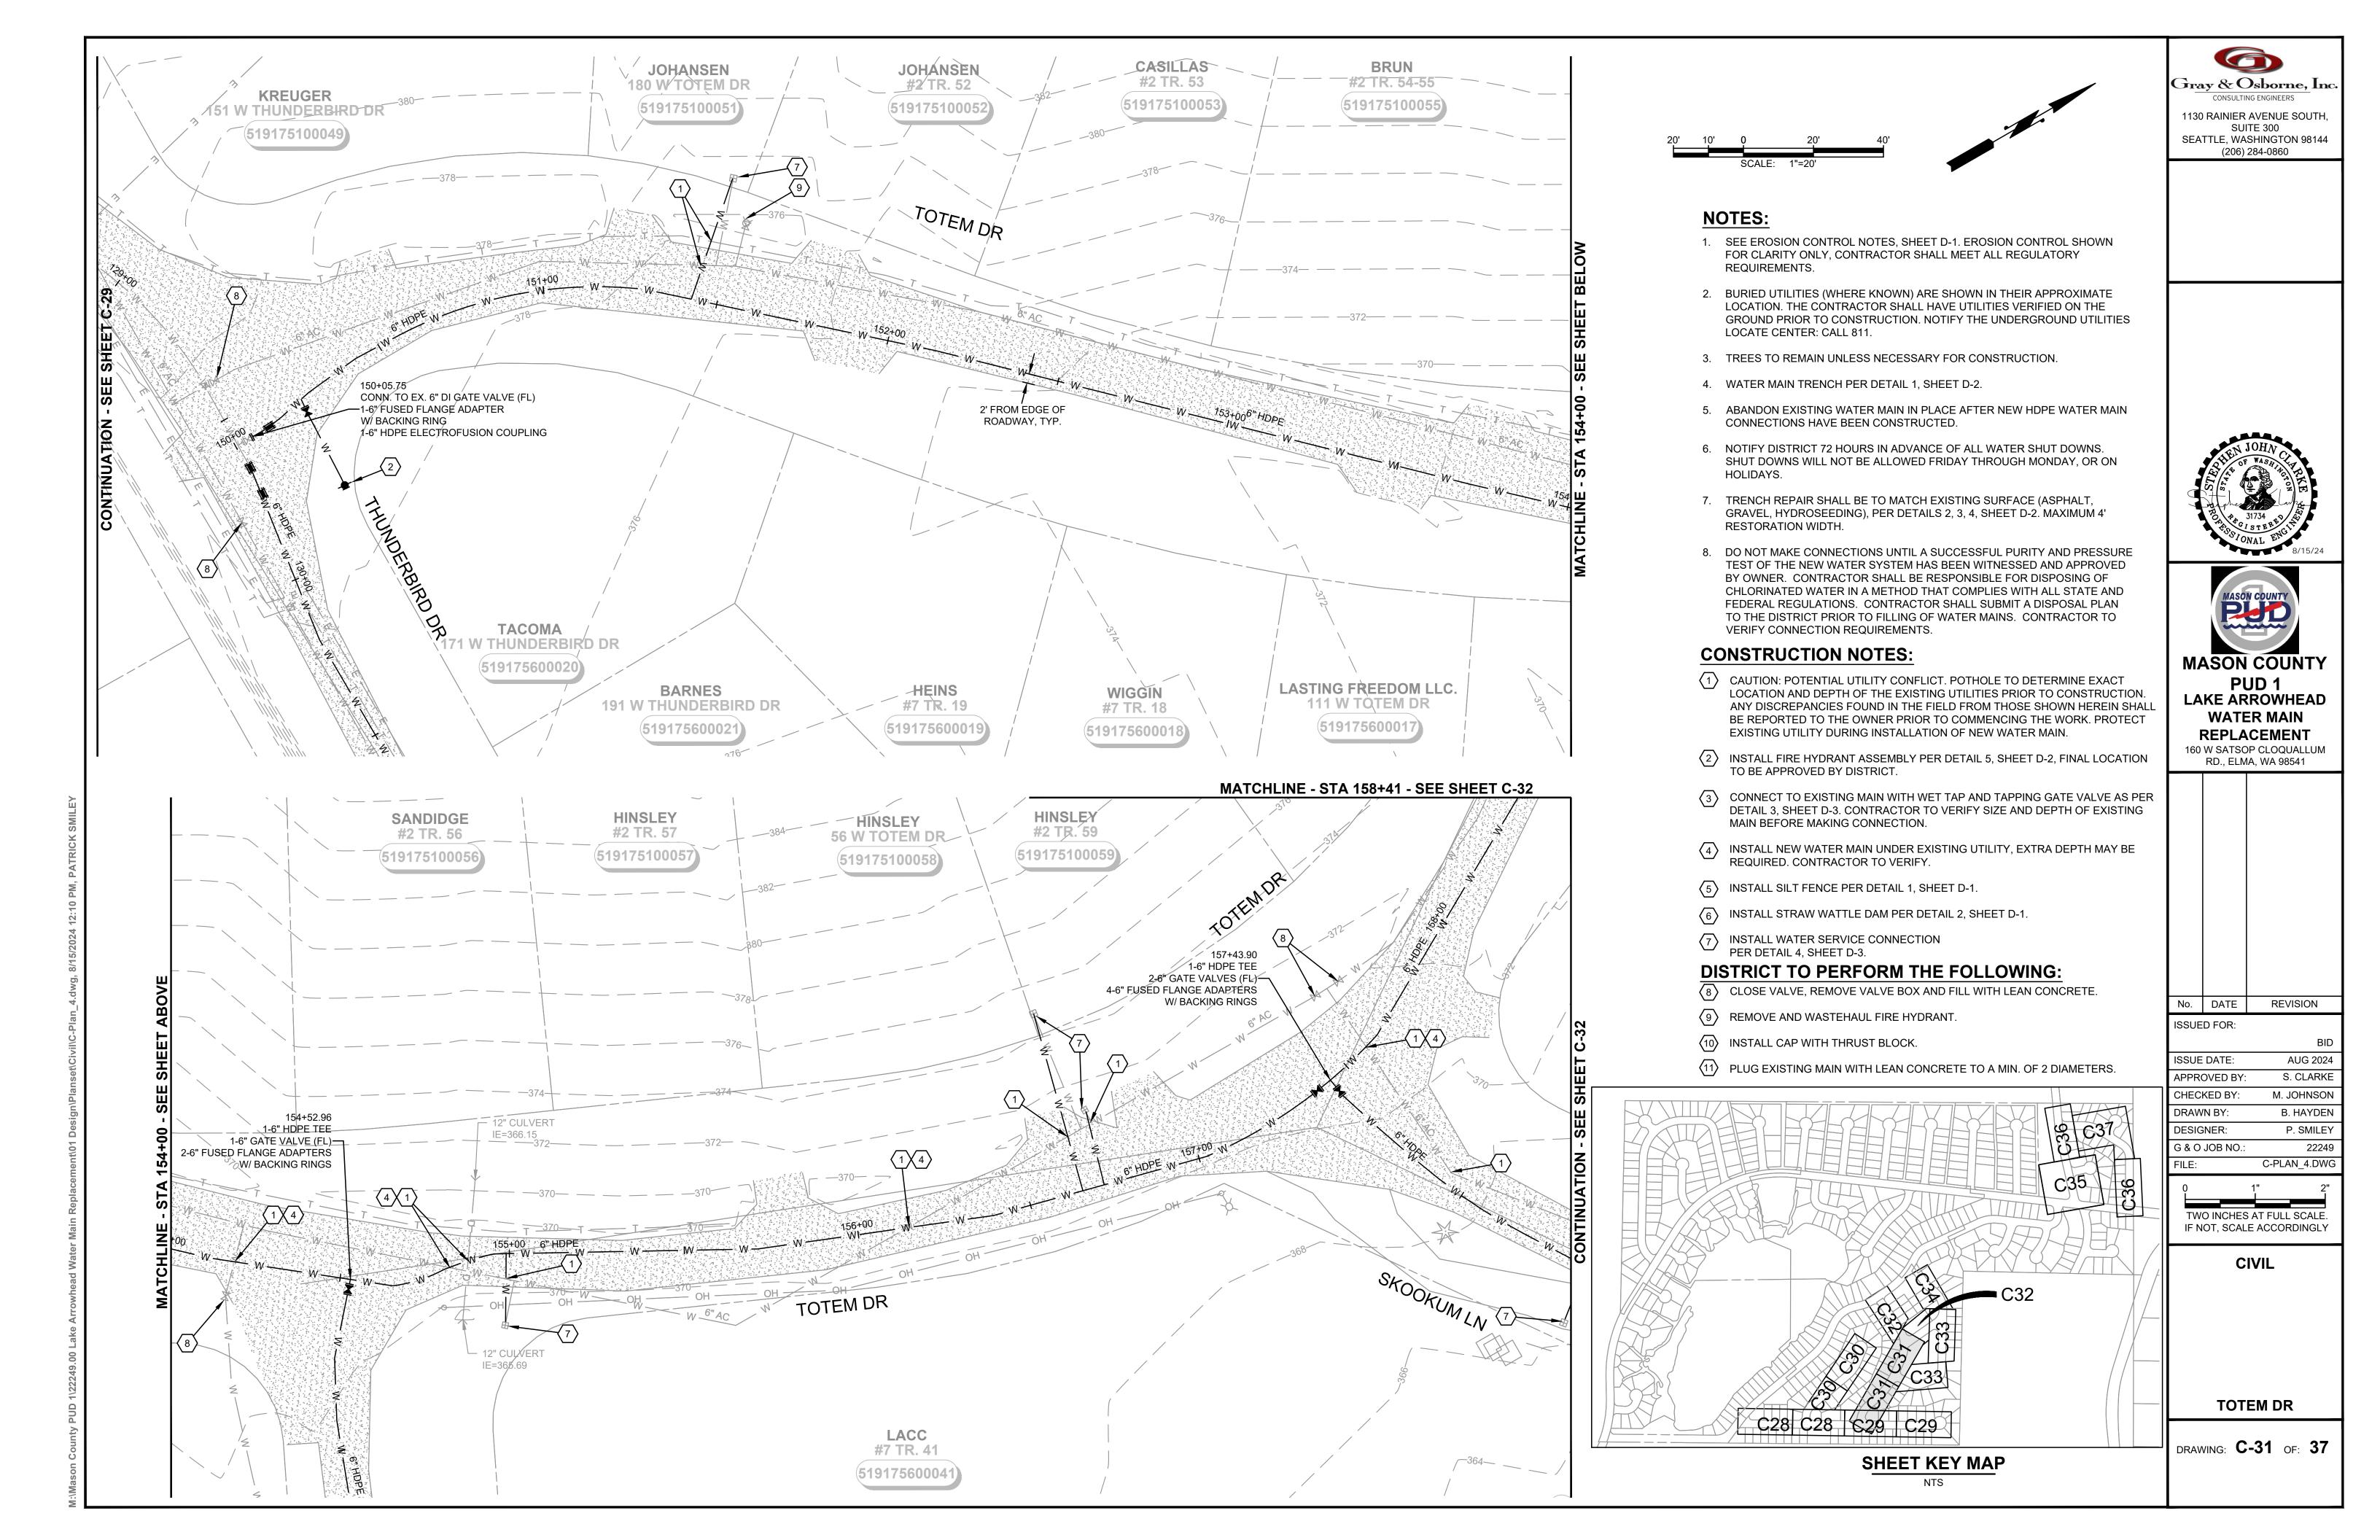

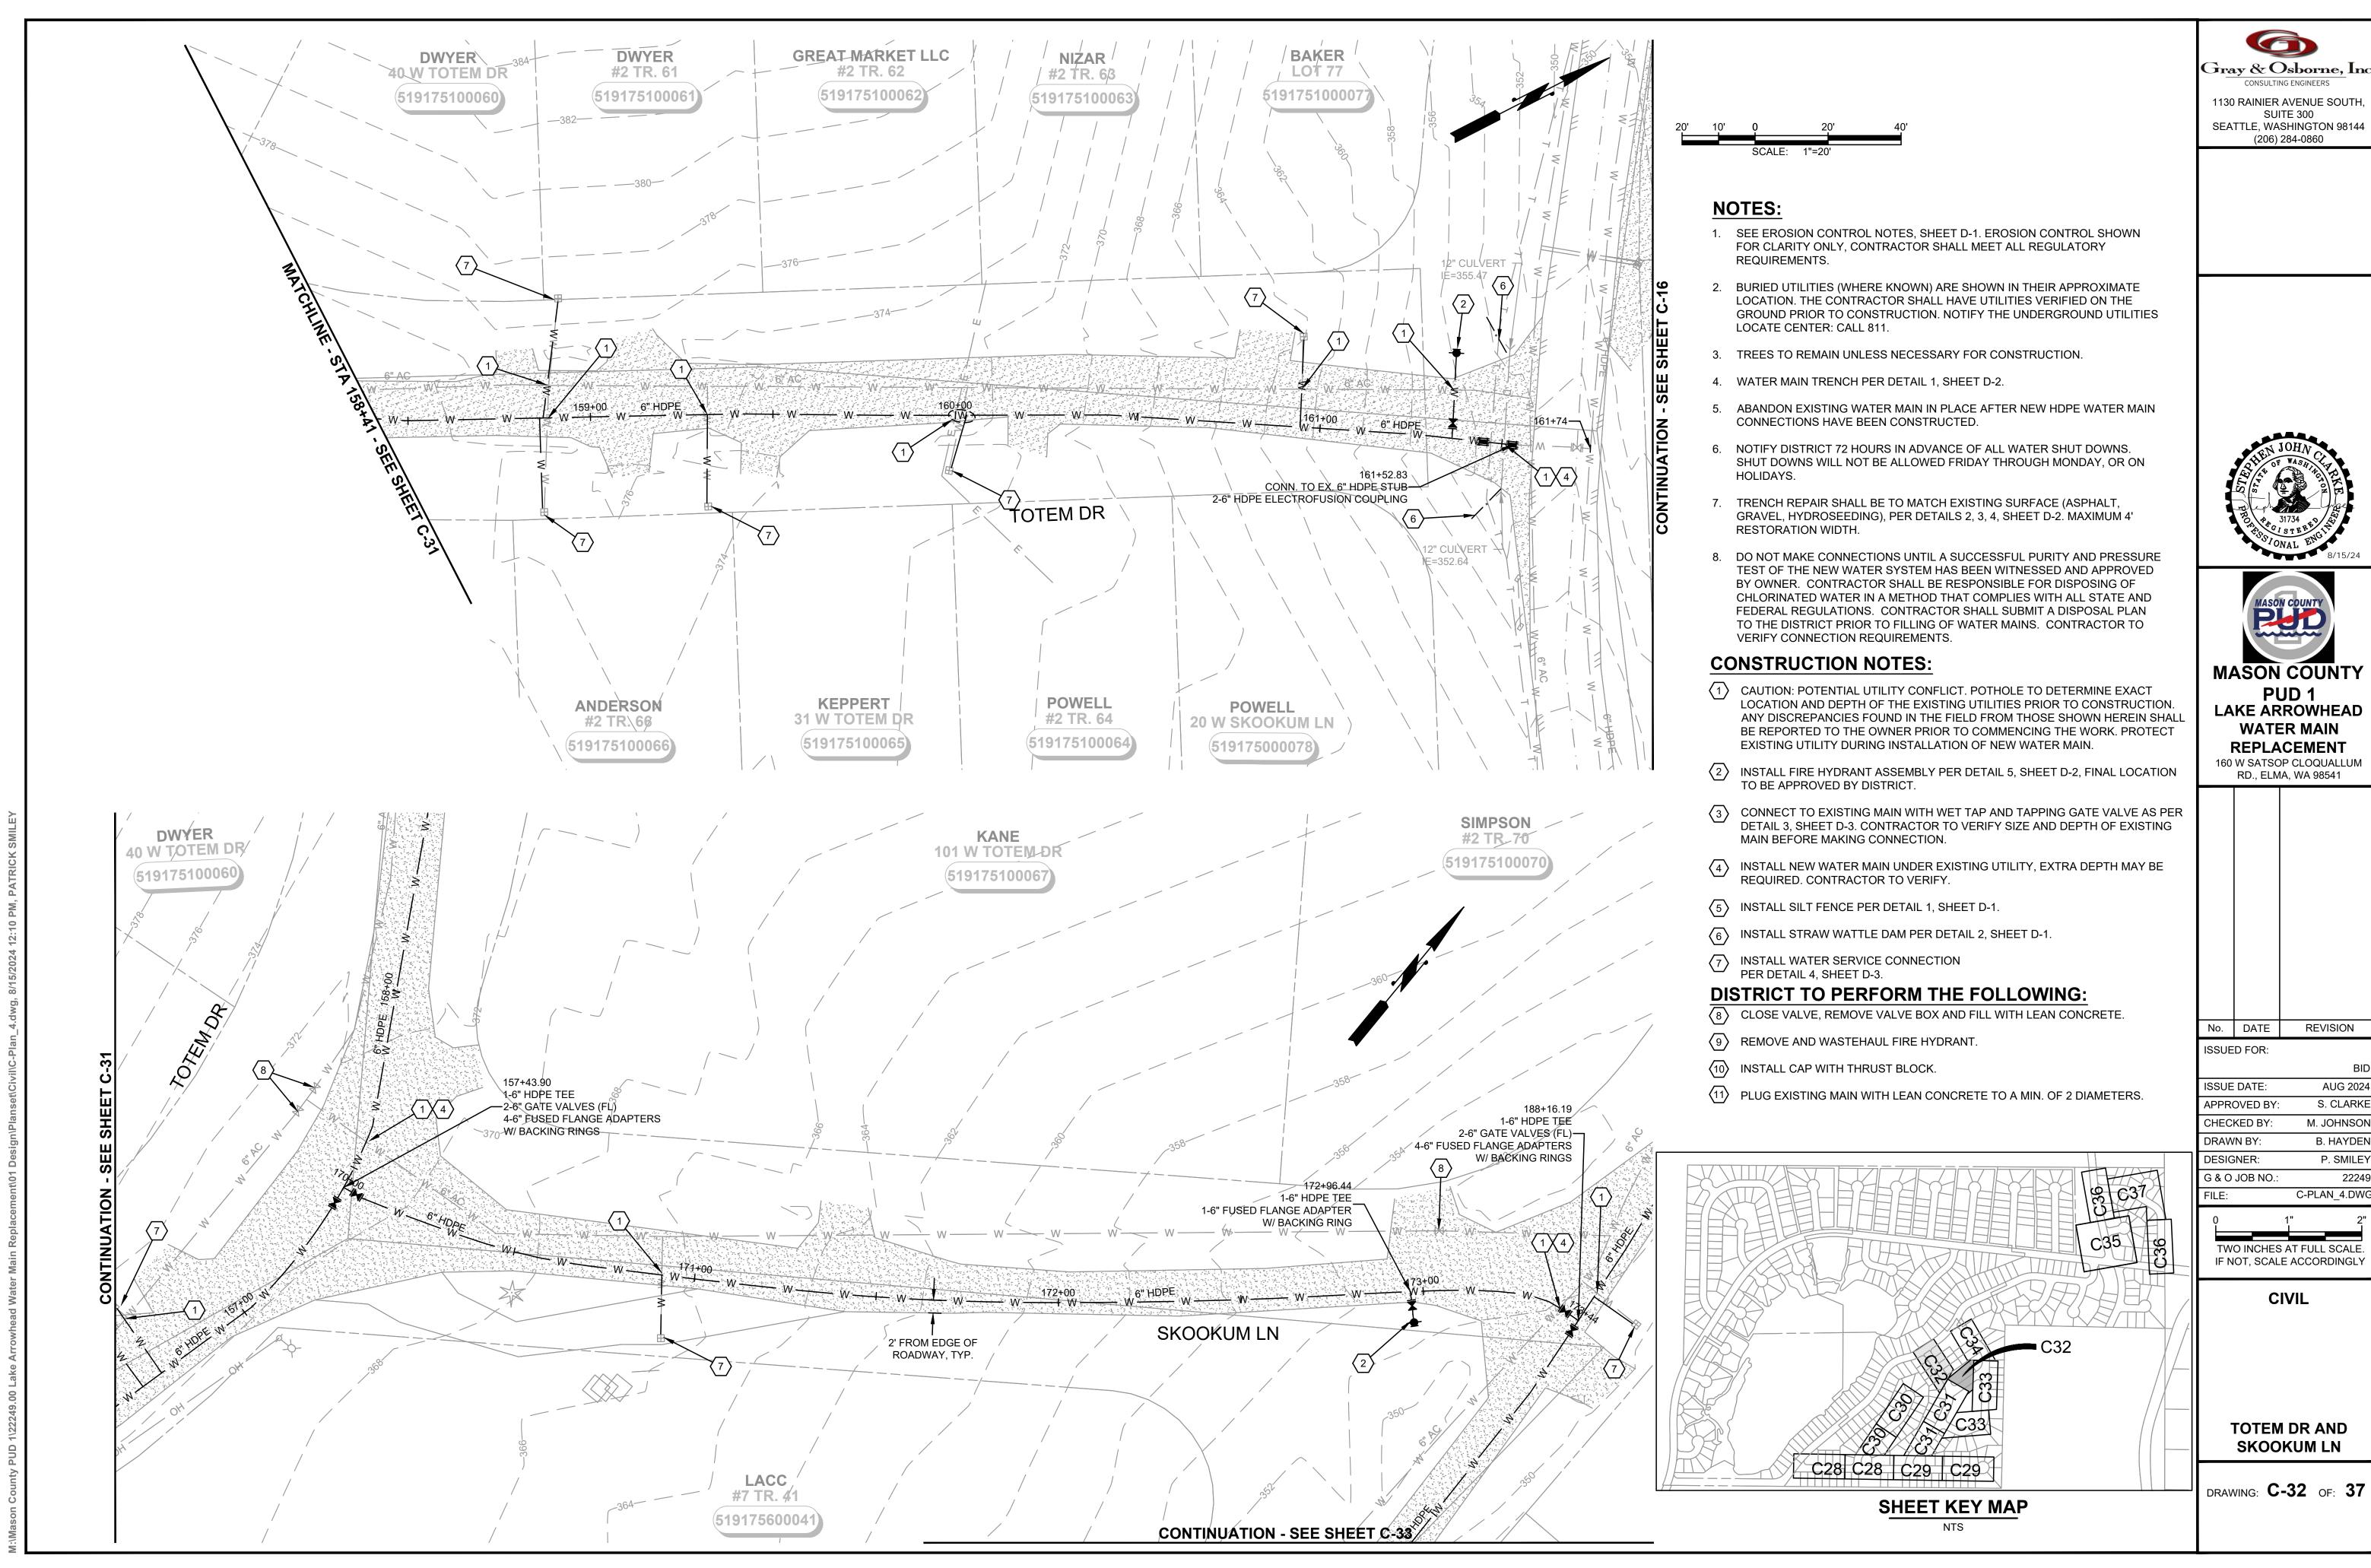





REVISION


AUG 2024 S. CLARKE M. JOHNSON

P. SMILEY

TWO INCHES AT FULL SCALE

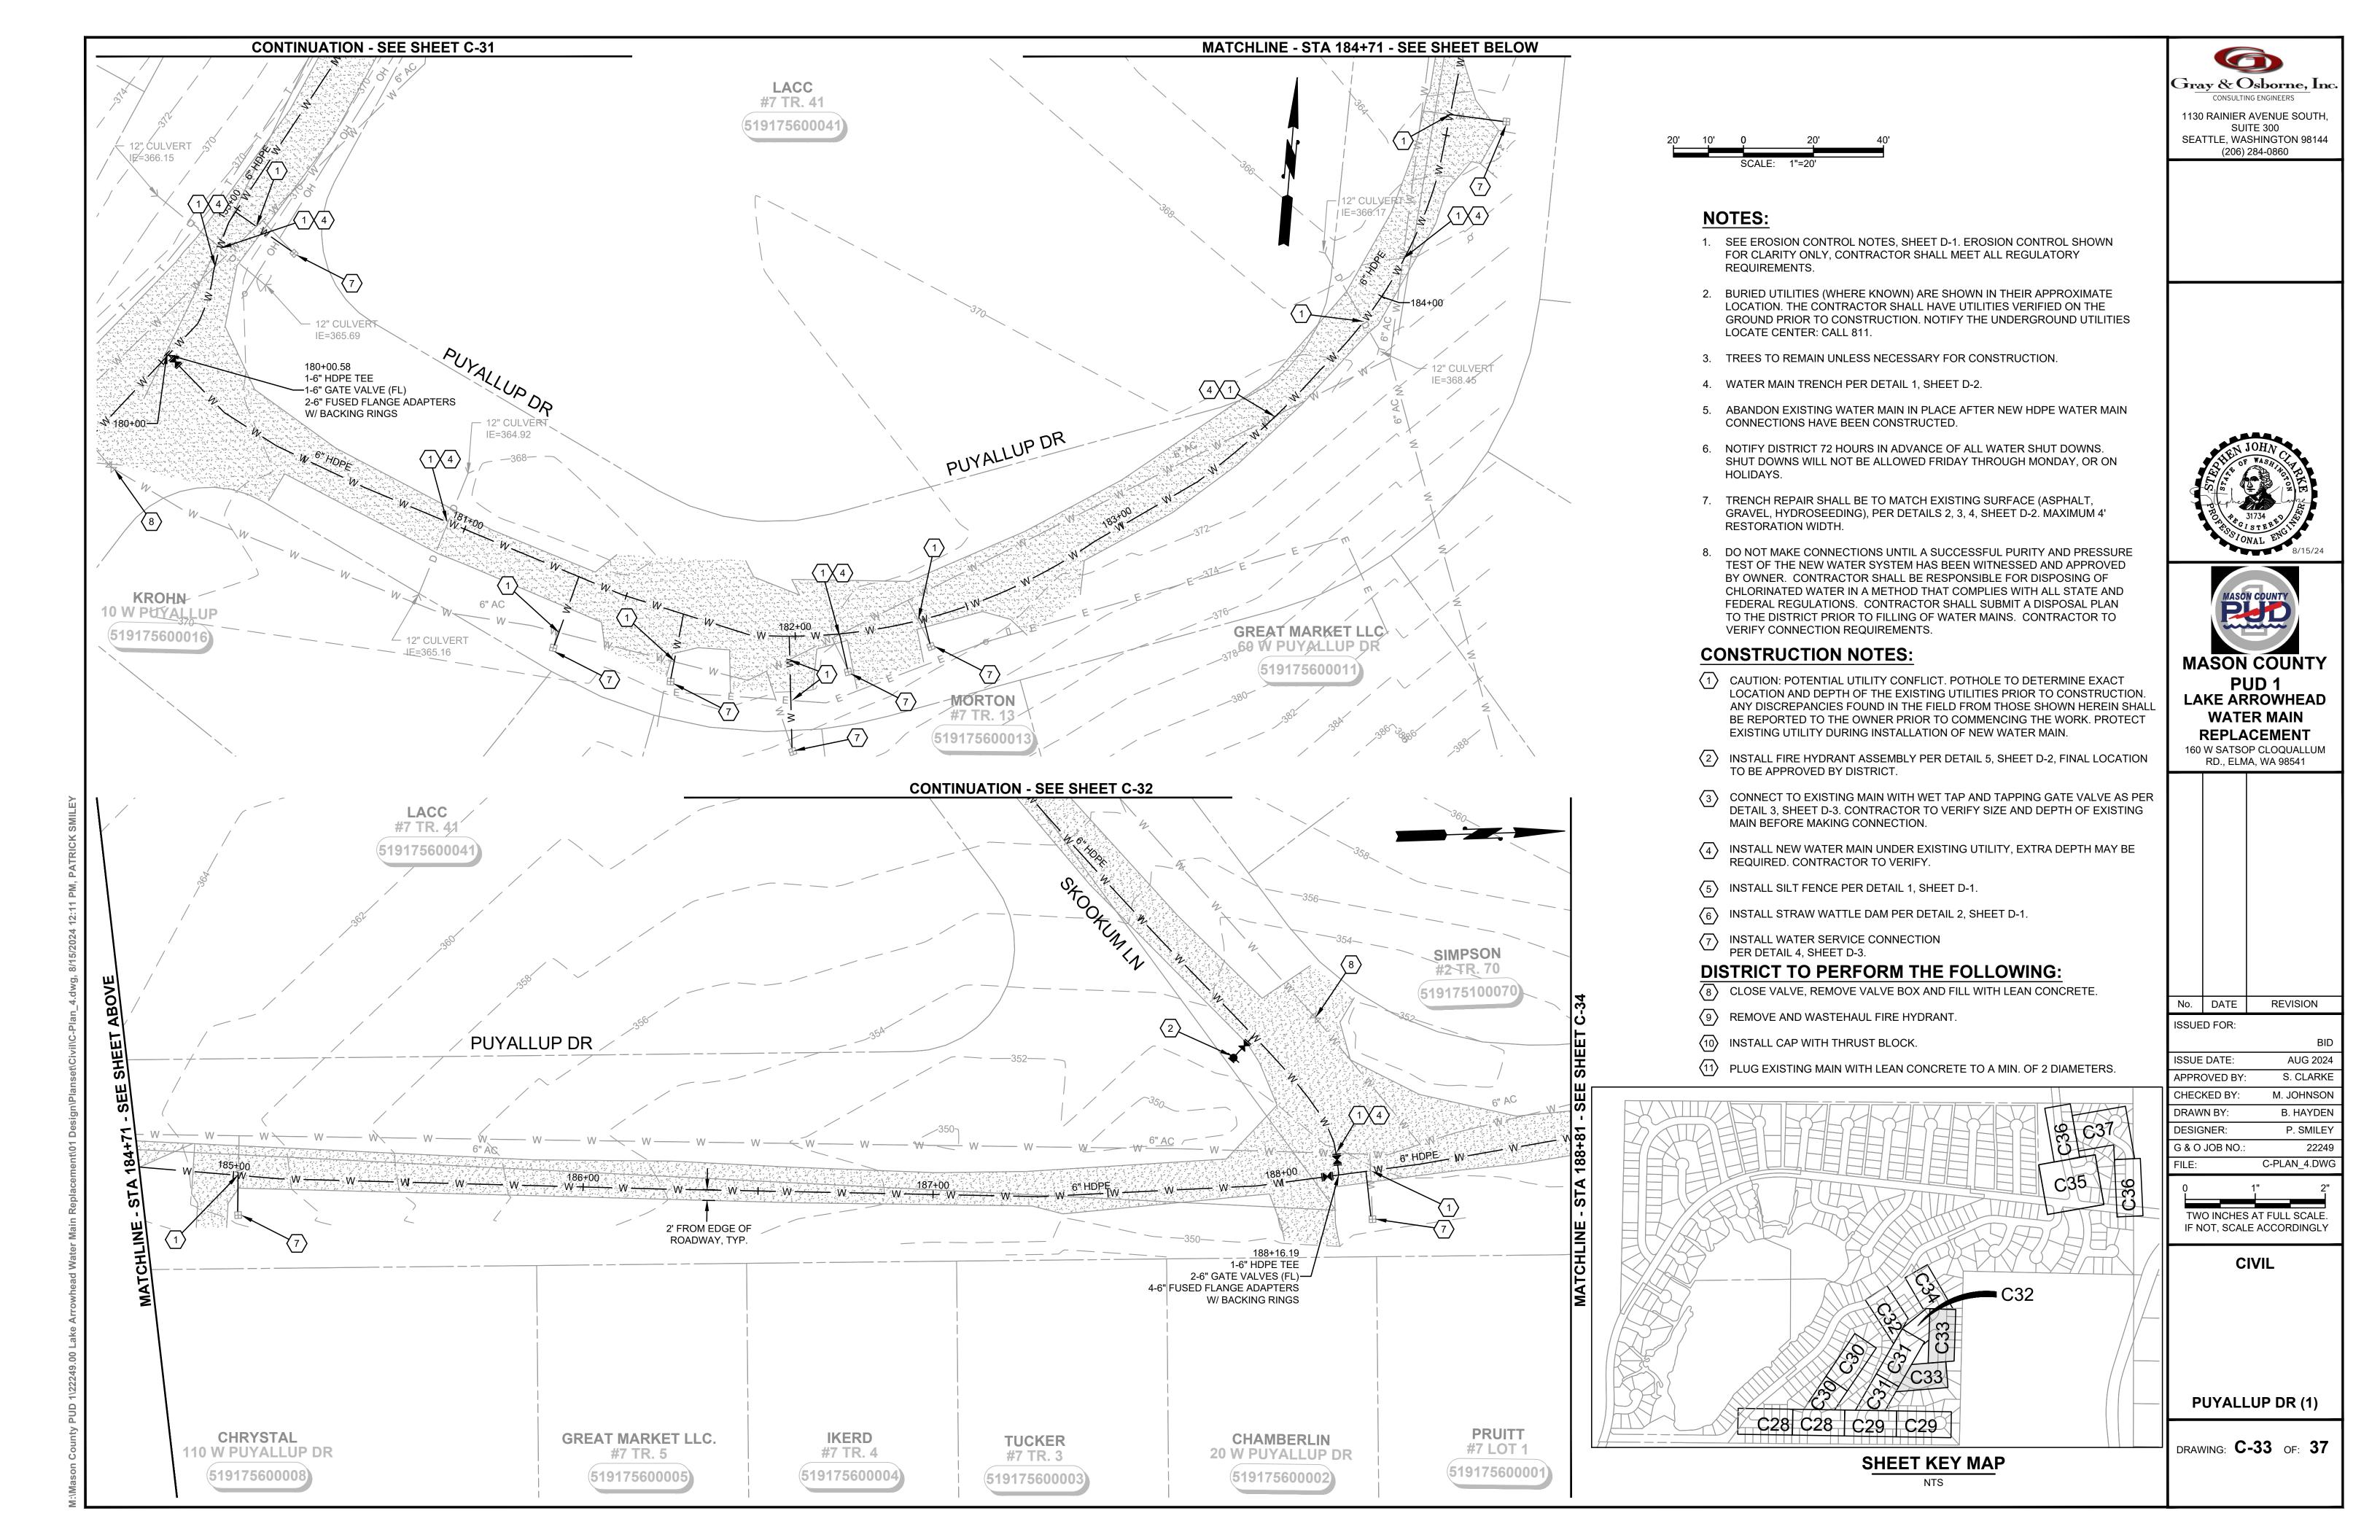

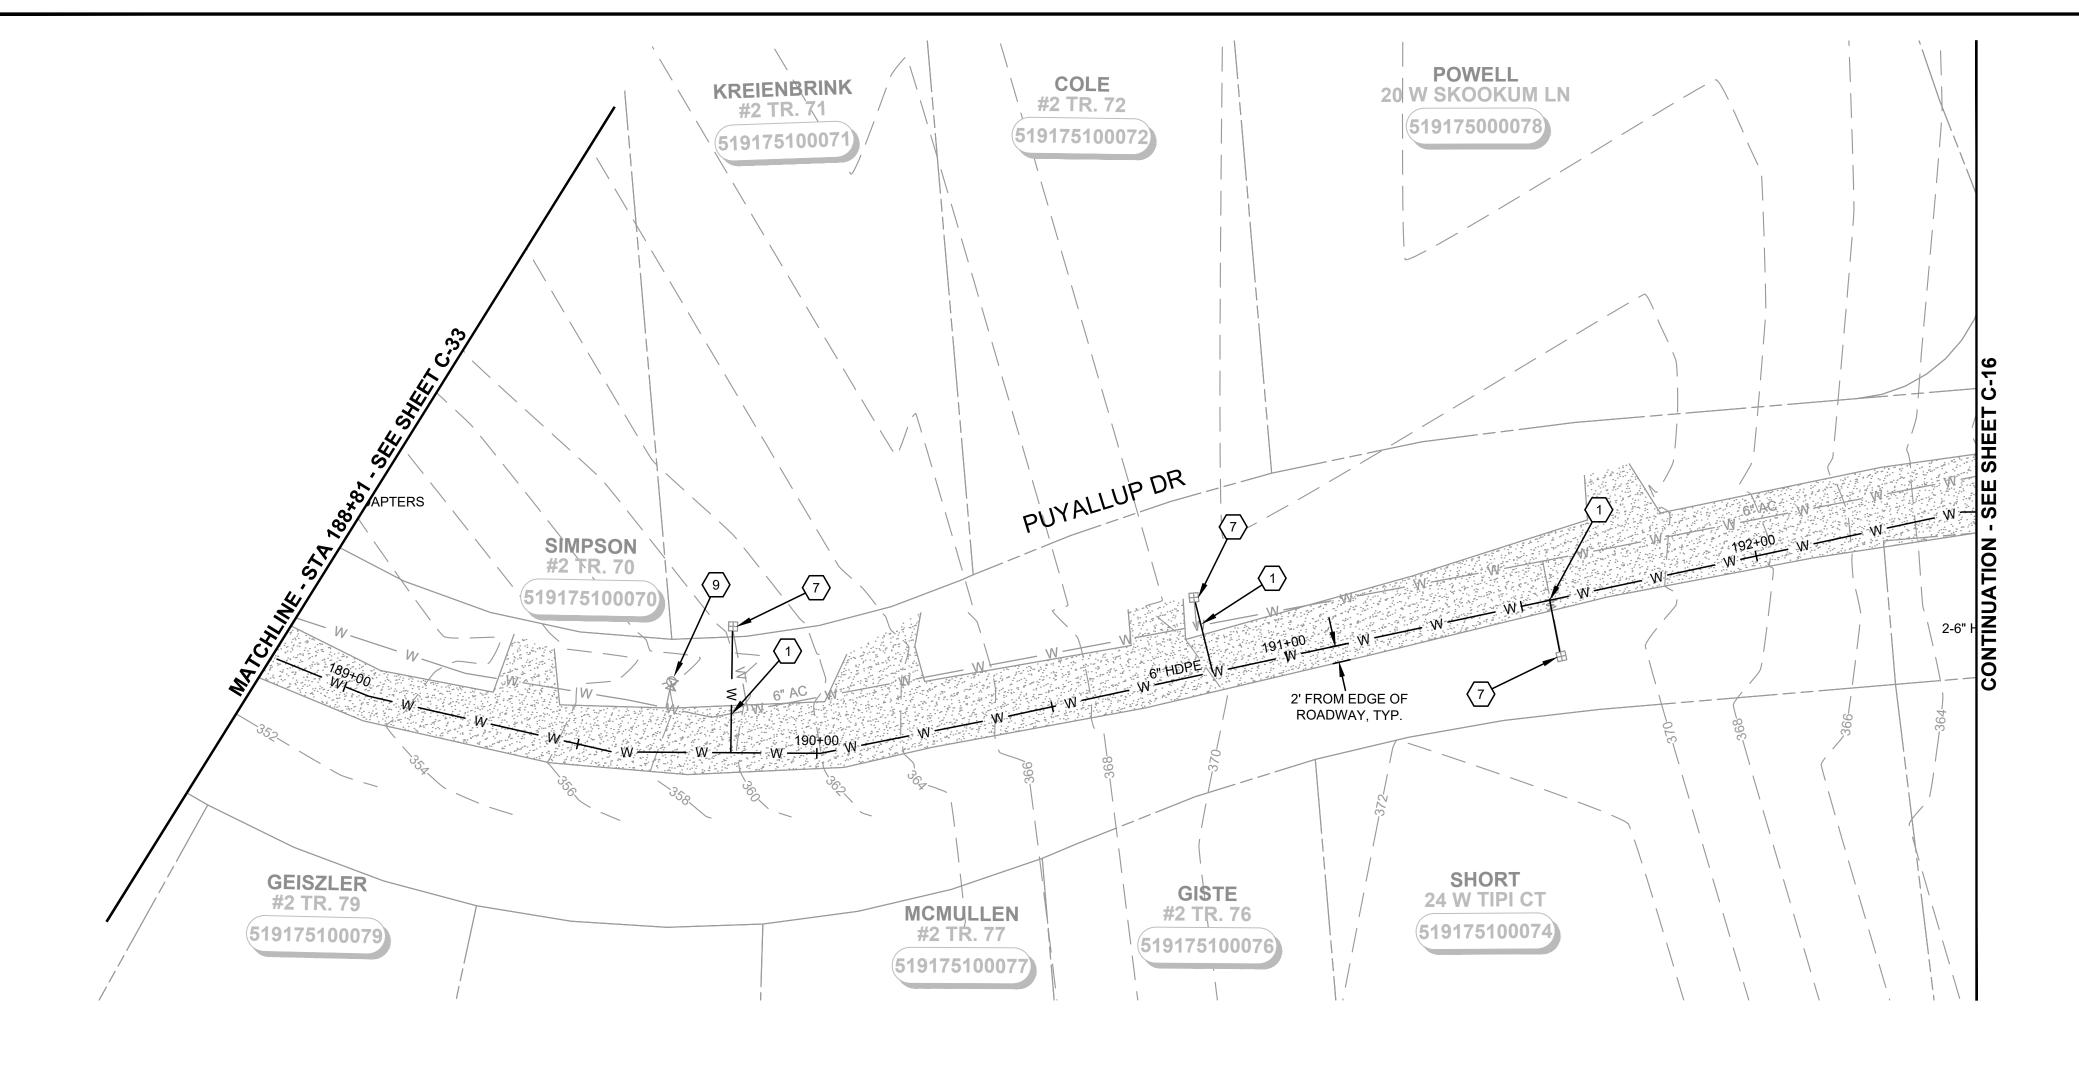

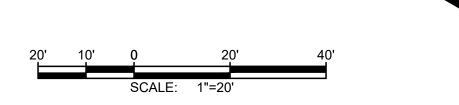

## 1130 R SEATT

#### NOTES:


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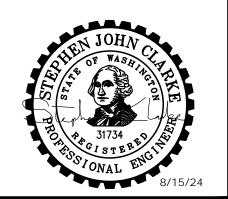


SHEET KEY MAP

NTS



1130 RAINIER AVENUE SOUTH, SUITE 300 SEATTLE, WASHINGTON 98144 (206) 284-0860

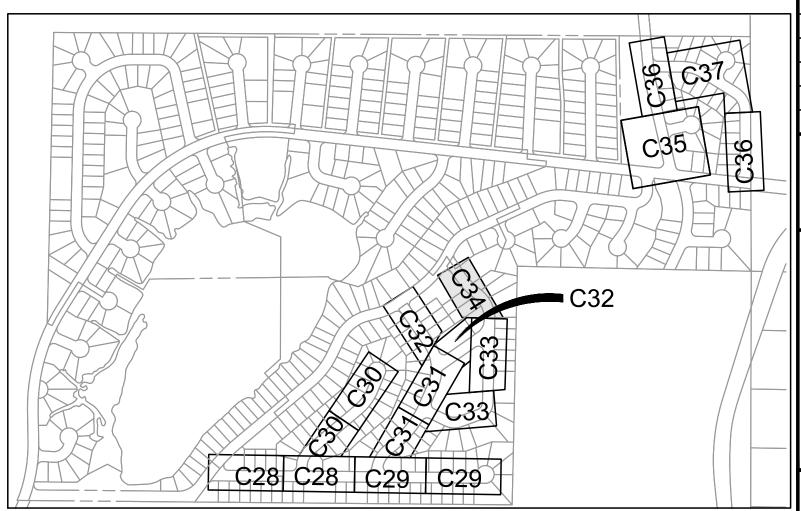



No DATE DEVISION

No. DATE REVISION
ISSUED FOR:

ISSUE DATE: AUG 2024
APPROVED BY: S. CLARKE
CHECKED BY: M. JOHNSON
DRAWN BY: B. HAYDEN

DRAWN BY:

DESIGNER:

P. SMILEY

G & O JOB NO.:

22249

FILE:


C-PLAN\_4.DWG

TWO INCHES AT FULL SCALE.
IF NOT, SCALE ACCORDINGLY

CIVIL


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DRAWING: C-34 OF: 37

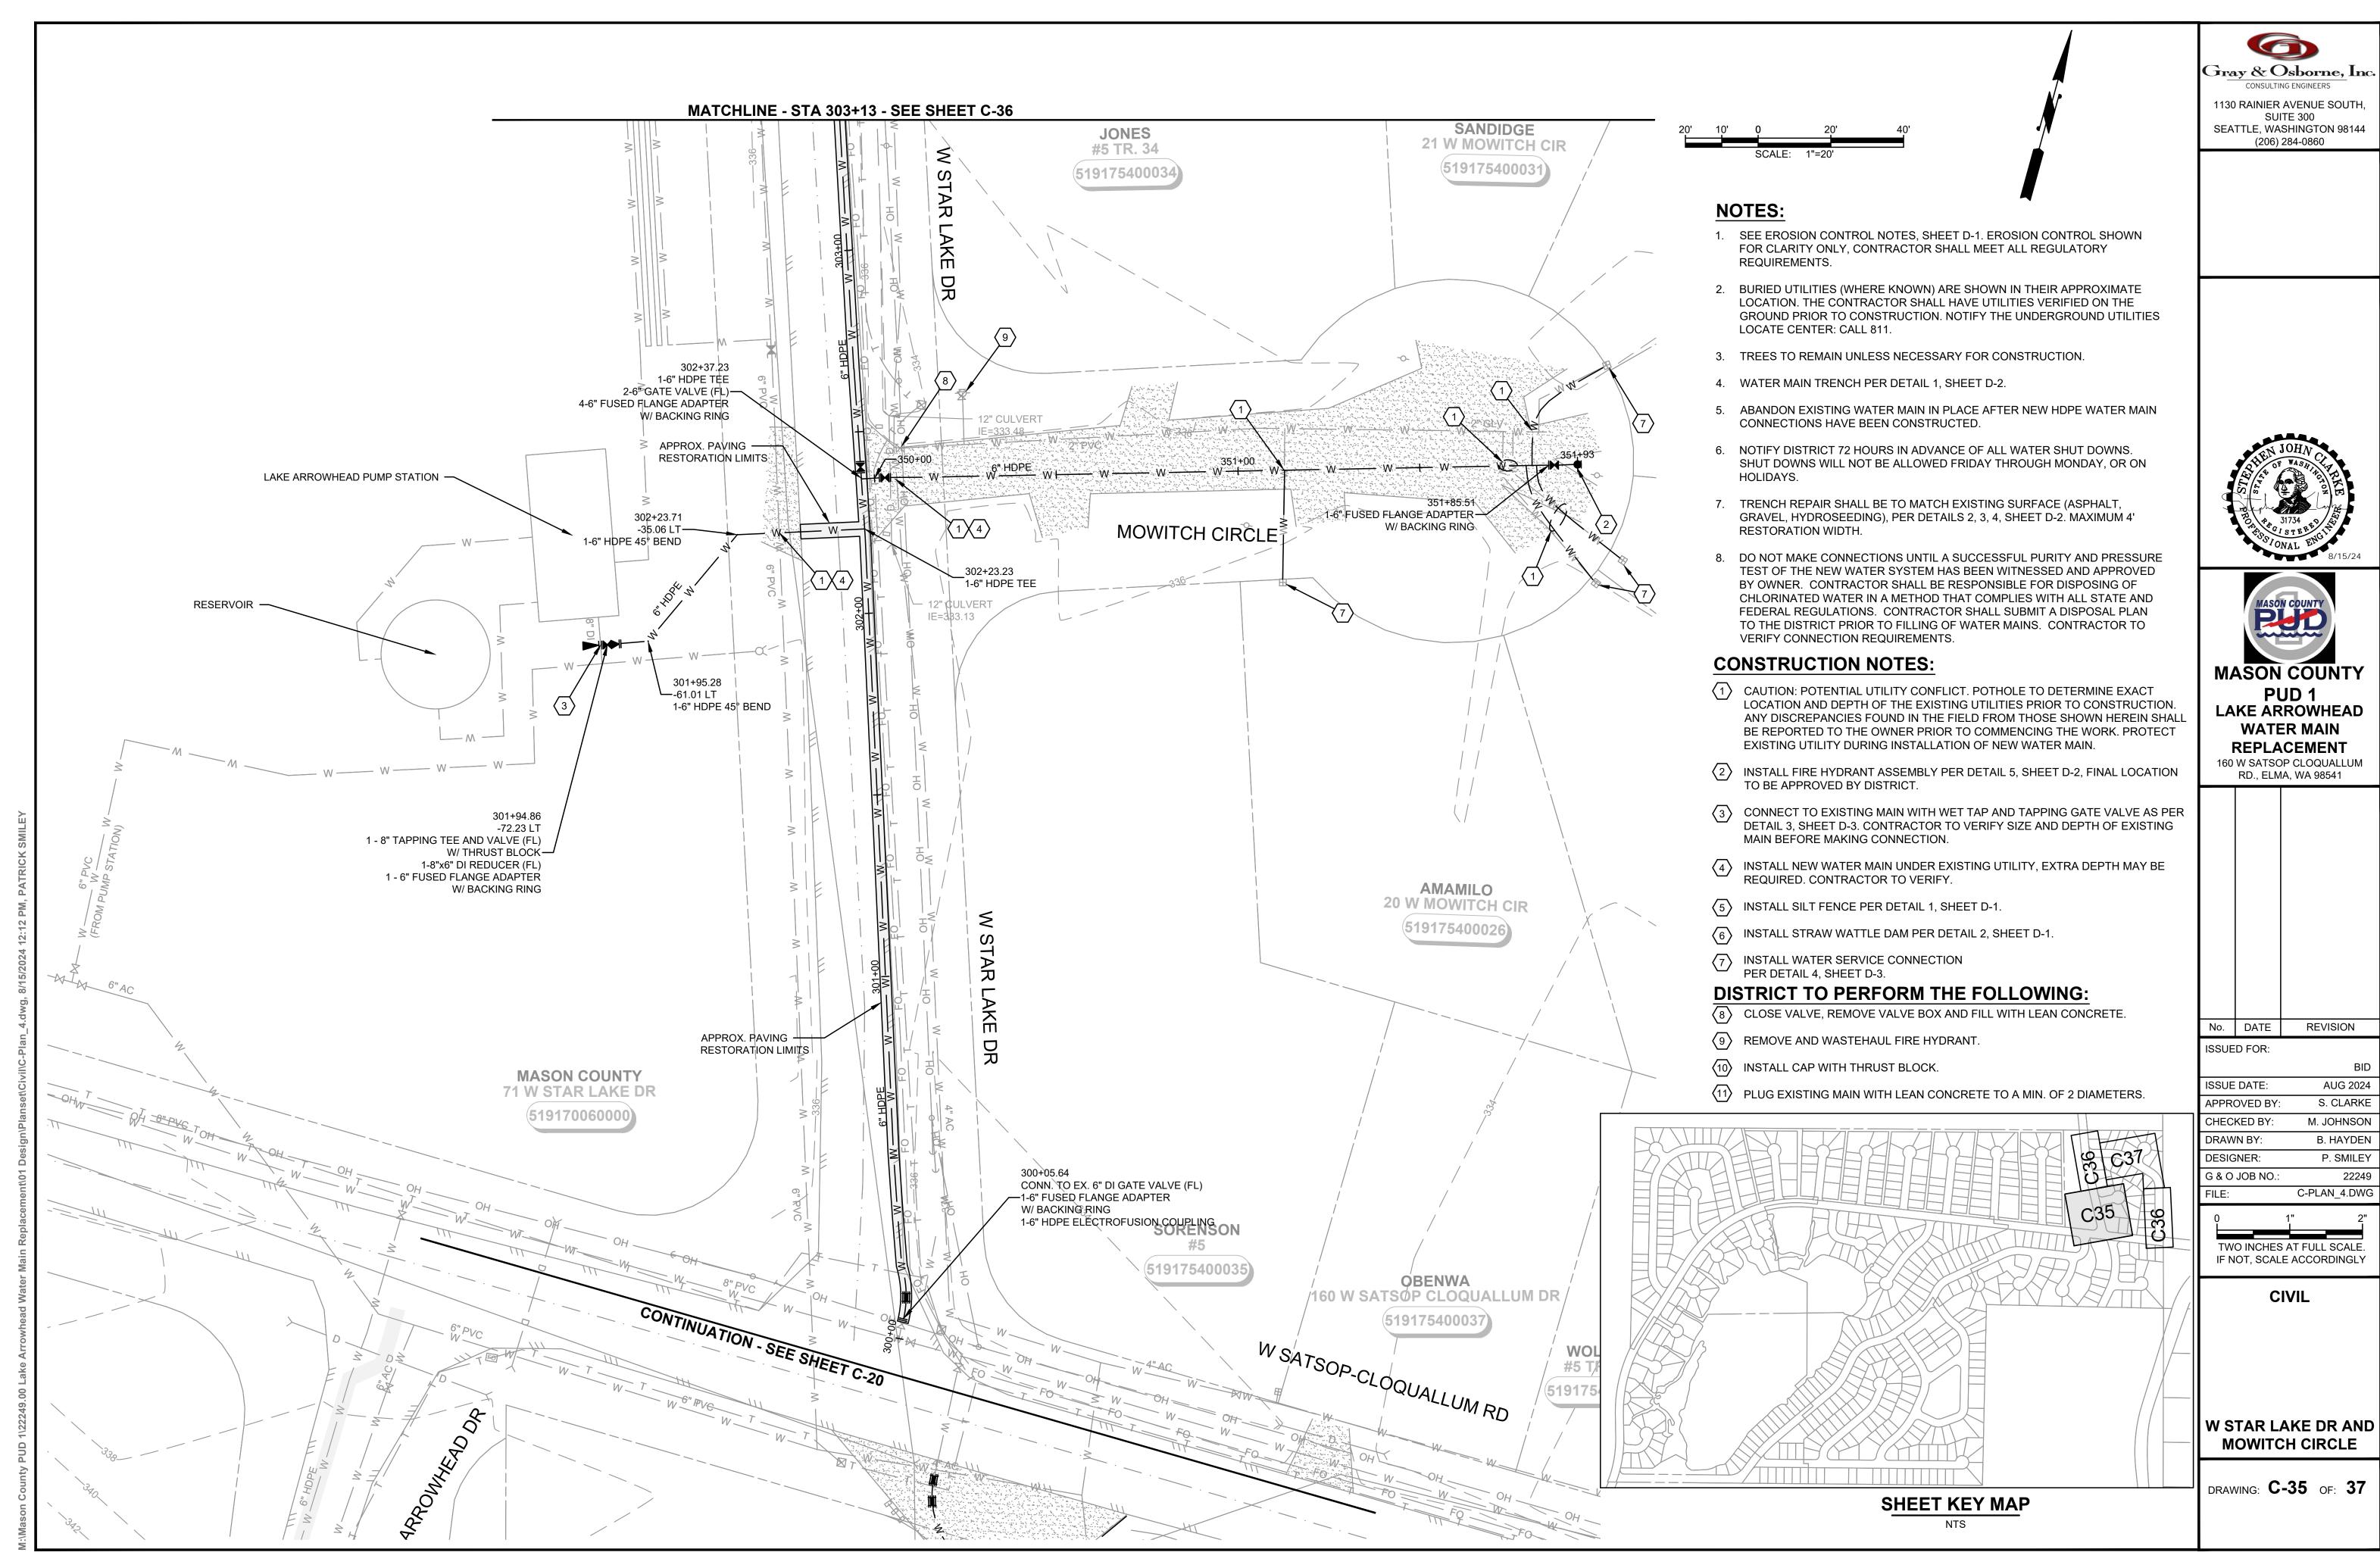


S. CLARKE M. JOHNSON B. HAYDEN

P. SMILEY C-PLAN\_4.DWG

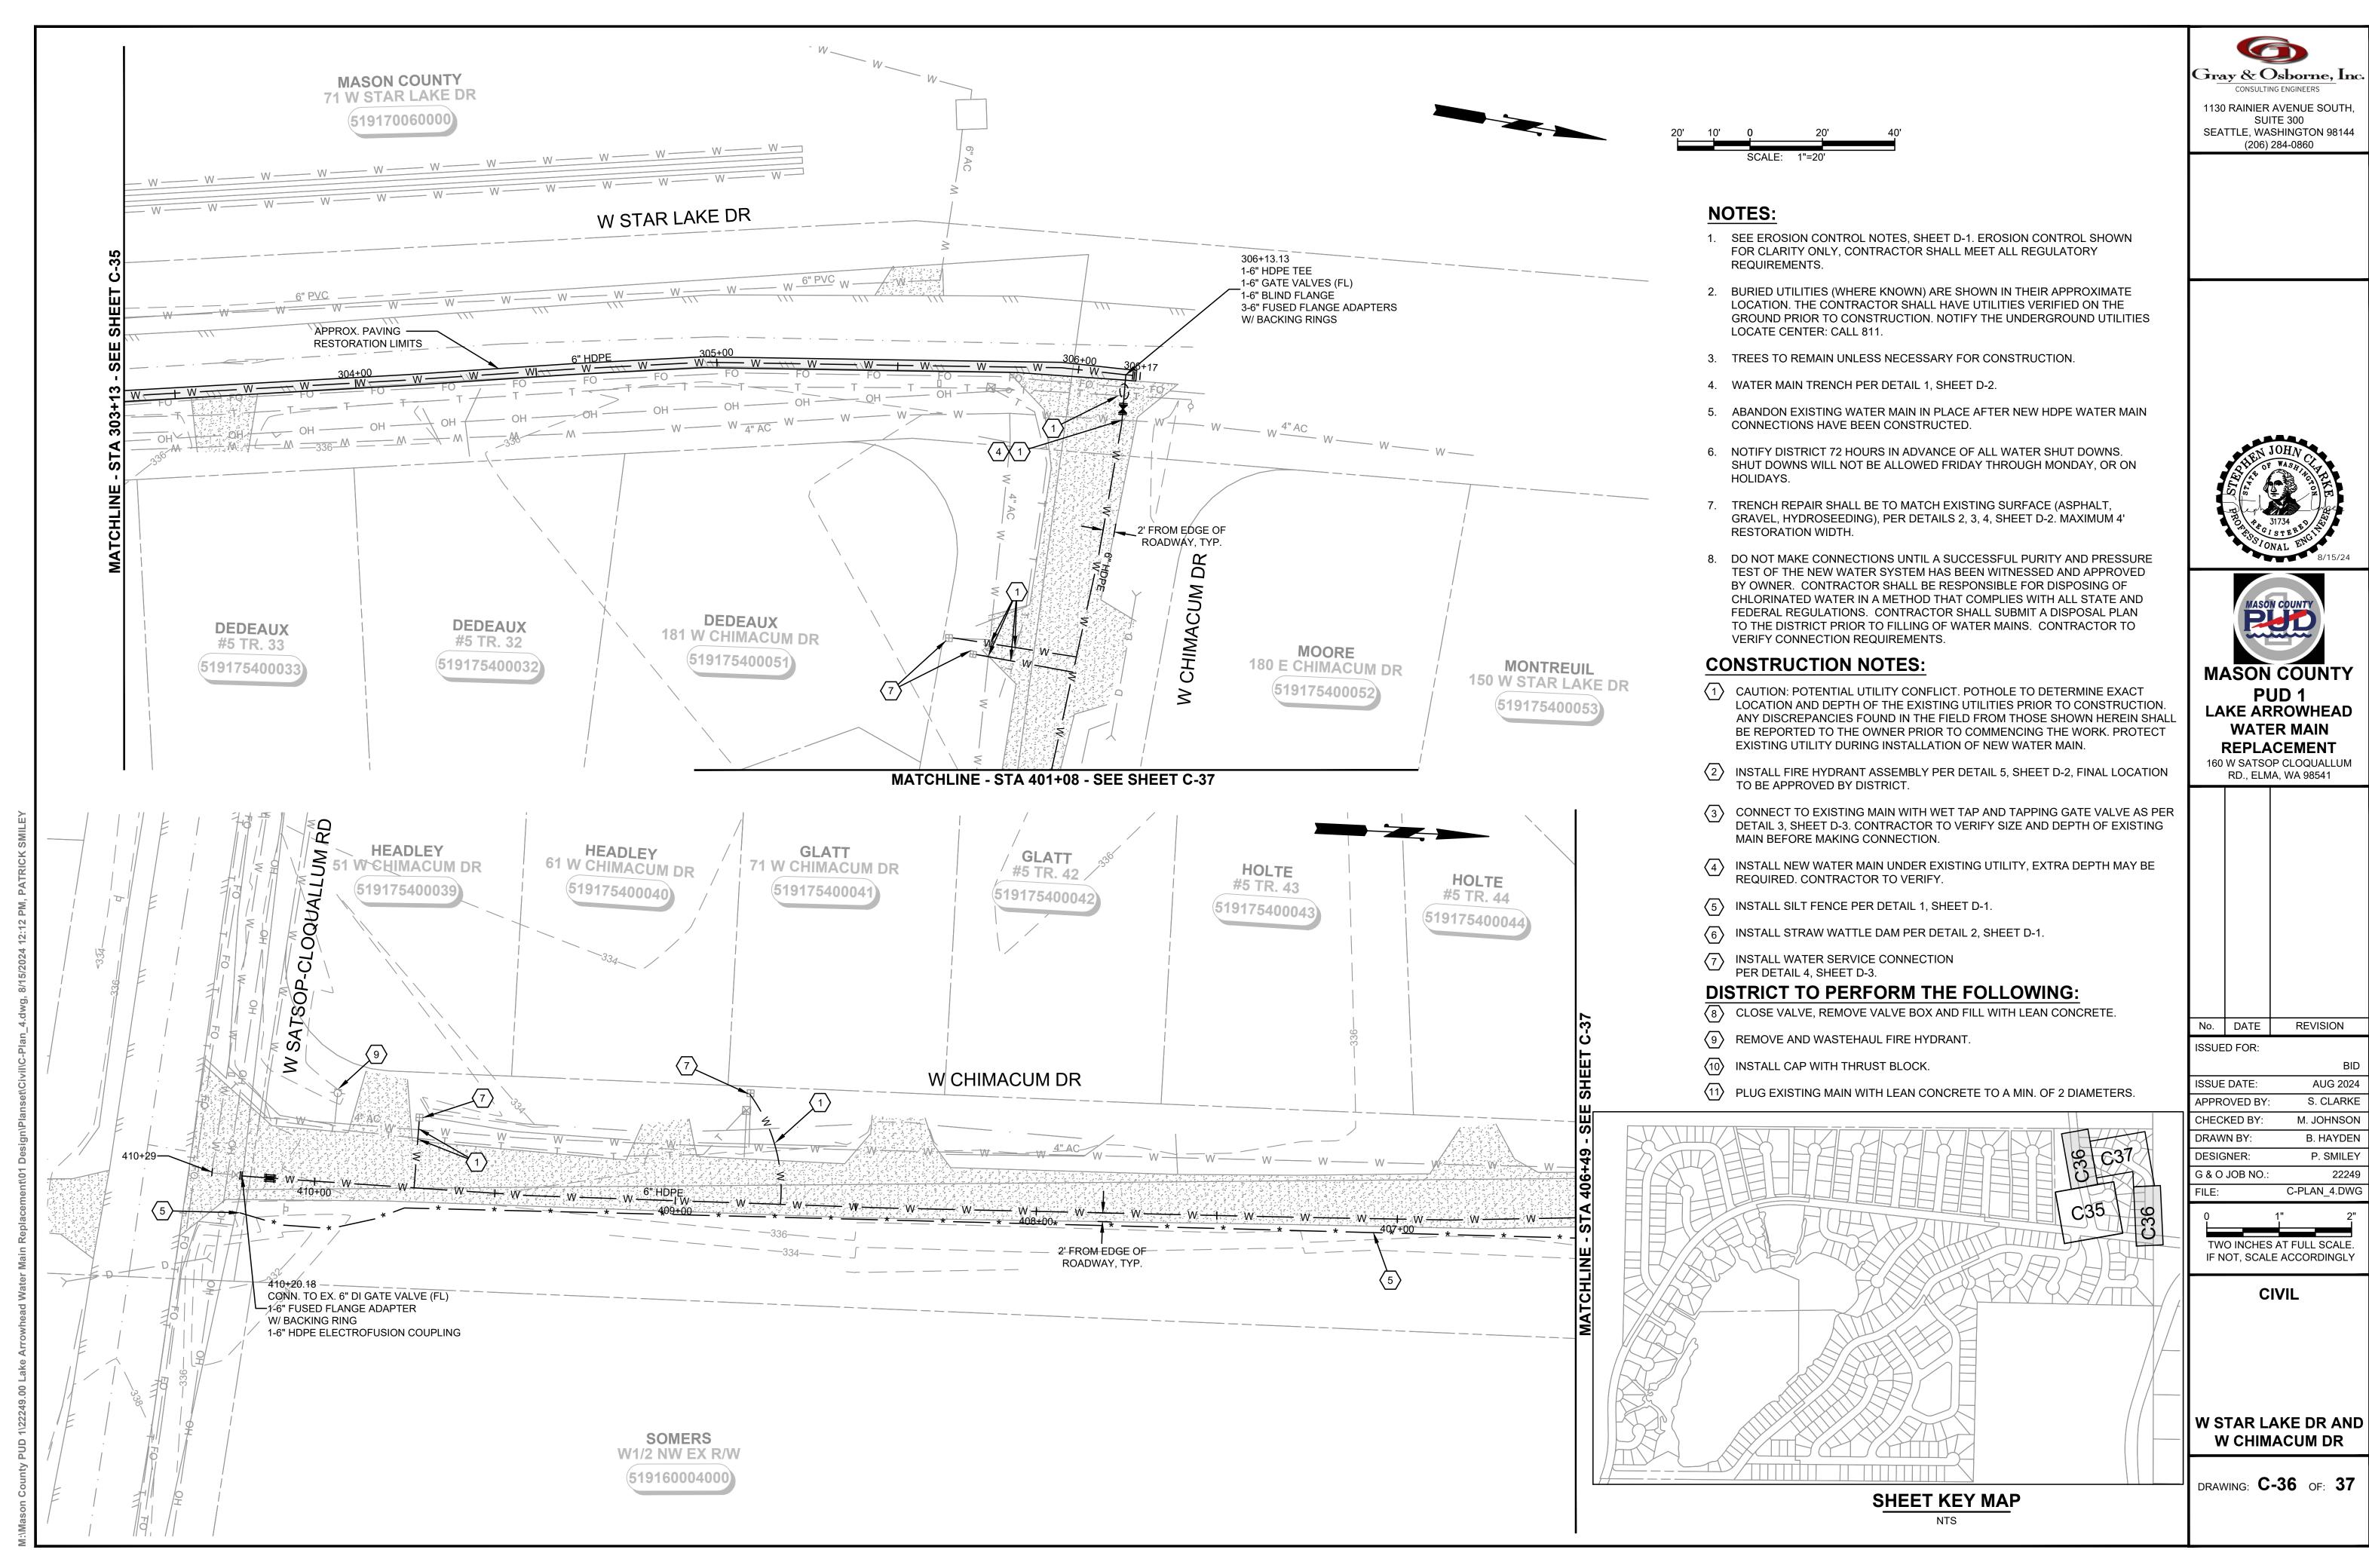

AUG 2024 S. CLARKE M. JOHNSON

B. HAYDEN P. SMILEY C-PLAN\_4.DWG

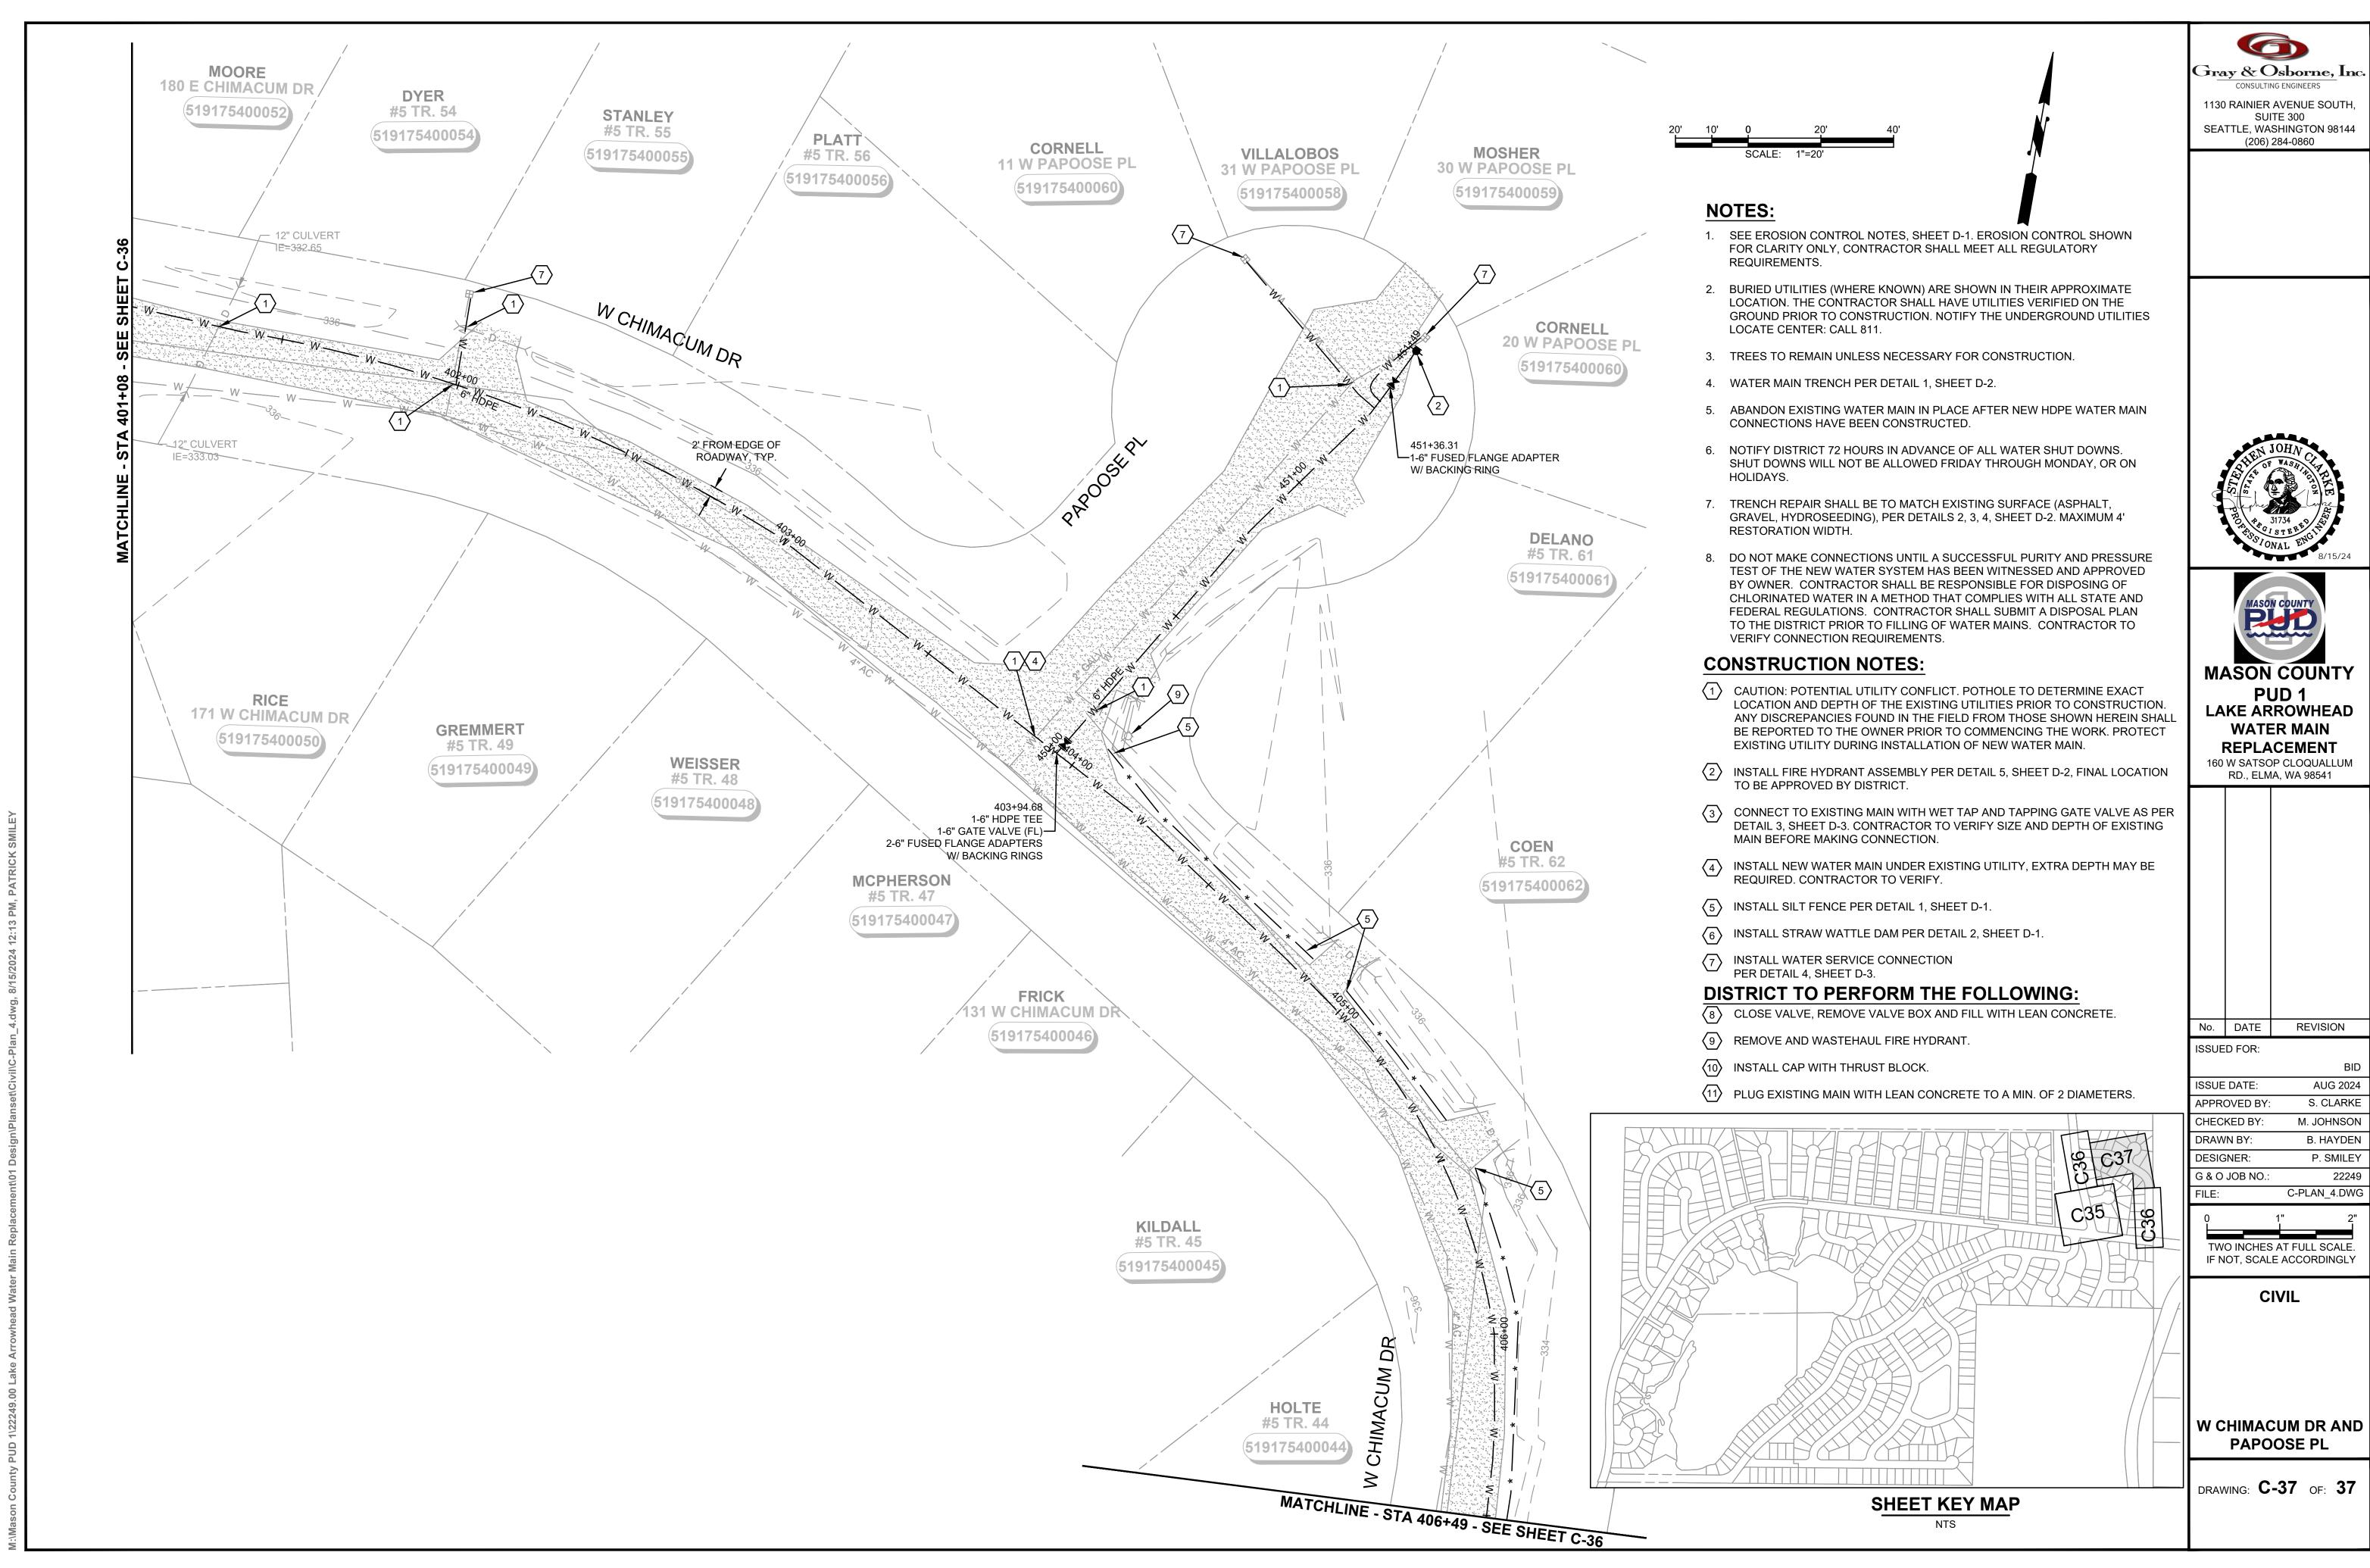



AUG 2024 S. CLARKE M. JOHNSON B. HAYDEN

P. SMILEY C-PLAN\_4.DWG